



# NORTH DAKOTA PARKS AND RECREATION DEPARTMENT

## ELECTRICAL UPGRADES GRAHAMS ISLAND STATE PARK 2023



### PROJECT CONTACTS

#### CLIENT

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#### PROJECT ENGINEERS

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#### UTILITIES

NORTHERN PLAINS ELECTRIC CO-OP  
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#### GENERAL NOTES:

- IT IS UNDERSTOOD THAT THESE PLANS WERE DESIGNED IN ACCORDANCE WITH STANDARD PRACTICES WIDELY ACCEPTED THROUGH THE FIELD OF ELECTRICAL ENGINEERING AND SURVEYING AT THE TIME THEY WERE ISSUED. ALTHOUGH THE PLANS REPRESENTED HERE HAVE BEEN DESIGN BY, OR UNDER THE DIRECT SUPERVISION OF, A REGISTERED PROFESSIONAL ENGINEER, BARTLETT & WEST WILL NOT BE RESPONSIBLE FOR THE ACCURACY OF ANY PHYSICAL WORK THAT IS NOT CONSTRUCTED UNDER THE DIRECT FULL TIME OBSERVATION OF PERSONNEL EMPLOYED BY BARTLETT & WEST.
- LOCATIONS OF EXISTING UTILITIES SHOWN ARE APPROXIMATE AND BASED UPON INFORMATION PROVIDED TO BARTLETT & WEST AND/OR FIELD OBSERVED. ACCURACY OF LOCATIONS OF ALL UNDERGROUND UTILITIES IS NEITHER GUARANTEED NOR WARRANTED. THE CONTRACTOR SHALL BE RESPONSIBLE FOR LOCATING AND VERIFYING ALL UNDERGROUND UTILITIES PRIOR TO CONSTRUCTION.
- ALL CONSTRUCTION SHALL CONFORM WITH LOCAL AND STATE BUILDING, PLUMBING, AND ELECTRICAL CODES.



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GI-E-601	ELECTRICAL SCHEDULES
GI-E-602	ELECTRICAL SCHEDULES
GI-E-603	ELECTRICAL RISER DIAGRAMS




Know what's below.  
Call 811 before you dig.

**Bartlett & West**

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**GRAHAMS ISLAND STATE PARK  
COVER SHEET**

**NORTH DAKOTA PARKS & RECREATION DEPARTMENT  
ELECTRICAL UPGRADES  
BISMARCK, NORTH DAKOTA**

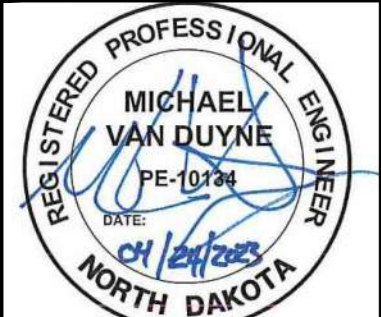

DESIGNED BY:	ARH
DRAWN BY:	SDM
APPROVED BY:	MSV
DESIGN PROJ:	21219.000
CONST PROJ:	
SCALE:	AS NOTED
DATE:	04-24-2023
DRAWING NO:	<b>GI-CS</b>
SHEET NO:	1 of 32

LIGHTING / ELECTRICAL

	POLE MOUNTED LIGHTING FIXTURE WITH TENNON ARM		BRANCH CIRCUIT IN CONDUIT CONCEALED IN CEILING OR WALL
	POLE MOUNTED LIGHTING FIXTURE		BRANCH CIRCUIT BELOW GRADE OR SLAB
	CEILING MOUNTED LIGHTING FIXTURE 1x4 AND ID TAG		BRANCH CIRCUIT IN EXPOSED CONDUIT
	CEILING MOUNTED LIGHTING FIXTURE 2x2 AND ID TAG		BRANCH CIRCUIT HOMERUN TO PANEL
	CEILING MOUNTED LIGHTING FIXTURE 2x4 AND ID TAG		DIAGONAL LINES INDICATE NUMBER OF CONDUCTORS
	EMERGENCY LIGHTING FIXTURE		GROUND WIRE - INCLUDED IN ALL BRANCH CIRCUITS UNLESS OTHERWISE NOTED
	CEILING MOUNTED DAYLIGHT CONTROLLED		#18 WIRE
	CEILING MOUNTED WITH EMERGENCY BALLAST		#16 WIRE
	CEILING MOUNTED LIGHT FIXTURE WITH NIGHT LIGHT		#14 WIRE
	PADDLE CEILING FAN		#12 WIRE
	CEILING MOUNTED EXIT LIGHT		BRANCH CIRCUIT OR FEEDER - SEE SCHEDULE FOR CONDUCTOR & CONDUIT QUANTITY & SIZE
	EXIT LIGHT (WALL MOUNTED)		FLEXIBLE CONDUIT
	CEILING MOUNT		TWISTED PAIR
	WALL MOUNT		LIGHTING CONTROL WIRING
	LIGHT TRACK WITH LIGHT TYPES AS INDICATED		MOTOR CONTROLLER
	SINGLE RECEPTACLE		MANUAL MOTOR CONTROLLER
	DUPLEX RECEPTACLE		COMBINATION MOTOR CONTROLLER
	FOURPLEX RECEPTACLE		DISCONNECT SWITCH
	RECESSED FLOOR MOUNTED JUNCTION BOX		EQUIPMENT MOTOR
	SURFACE MOUNTED JUNCTION BOX		UTILITY METER
	CEILING MOUNTED JUNCTION BOX		
	PHOTOCELL		
	ELECTRICAL POWER PEDESTAL		
	JUNCTION BOX		
	TYPE 1 JUNCTION BOX		
	TYPE 2 JUNCTION BOX		
	PLUGMOLD - OUTLETS AT 12" O.C. UNLESS OTHERWISE NOTED		
	TIME SWITCH		
	LIGHTING CONTACTOR		
	SPRING WOUND TIMER		
	HAND-OFF-AUTO SELECTOR SWITCH		
	MANUAL STARTER WITH THERMAL OVERLOADS		
	LIGHTING PANEL		
	DISTRIBUTION PANEL		
	TELEPHONE TERMINAL PANEL		
	THERMOSTAT		
	HUMIDISTAT		
	(1) RJ-45 COMMUNICATION/DATA OUTLET		
	(2) RJ-45 COMMUNICATION/DATA OUTLET		
	(4) RJ-45 COMMUNICATION/DATA OUTLET		
	CEILING MOUNTED COMMUNICATION/DATA OUTLET		
	FLOOR MOUNTED COMMUNICATION/DATA OUTLET		
	TELEVISION OUTLET		
	WALL SPEAKER		
	CEILING SPEAKER		
	COLUMN SPEAKER		
	HORN SPEAKER		
	CALL-IN STATION		
	MOTION DETECTOR		
	CLOSED CIRCUIT TELEVISION OUTLET		
	PUSHBUTTON STATION		
	RELAY CABINET		
	CLOCK SPEAKER		
	CARD READER		
	MAGNETIC LOCK		
	ALARM CONTACTS		
	SECURITY CAMERA		
	SINGLE POLE SWITCH		
	DOUBLE POLE SWITCH		
	3-WAY SWITCH		
	4-WAY SWITCH		
	SINGLE POLE SWITCH WITH PILOT LAMP		
	MOMENTARY CONTACT		
	SINGLE POLE SWITCH, KEY OPERATED		
	DIMMER SWITCH		
	LOW VOLTAGE SWITCH		
	VACANCY SENSOR SWITCH		
	OCCUPANCY SENSOR		
	POWER PACK		

BAR IS ONE INCH ON OFFICIAL DRAWINGS. 0 1" IF NOT ONE INCH, ADJUST SCALE ACCORDINGLY.

GENERAL SYMBOLS

	INDICATES DIRECTION OF PLAN NORTH
	DETAIL REFERENCE - UPPER NUMBER INDICATES DETAIL NUMBER, LOWER NUMBER INDICATES SHEET NUMBER
	PLAN NOTE REFERENCE
	REVISION DELTA
	ROOM NUMBER REFERENCE
	SECTION CUT REFERENCE - UPPER NUMBER INDICATES DETAIL NUMBER, LOWER NUMBER INDICATES SHEET NUMBER
	CONTINUATION
	INDICATES CONNECTION TO EXISTING SYSTEM
	BREAK LINE
	MATCHLINE


ABBREVIATIONS

GENERAL:			
AFF	ABOVE FINISHED FLOOR	G/C	GENERAL CONTRACTOR
AFG	ABOVE FINISHED GRADE	M/C	MECHANICAL CONTRACTOR
CL	CENTERLINE ELEVATION	E/C	ELECTRICAL CONTRACTOR
DN	DOWN	P/C	PLUMBING CONTRACTOR
EX	EXISTING		

ELECTRICAL:	
AC	ALTERNATING CURRENT
BKR	BREAKER
CTCB	CONTROL TRANSFORMER CIRCUIT BREAKER
DISC	DISCONNECT SWITCH
DR	DUPLEX RECEPTACLE, GFI
DCB	DISCONNECT CIRCUIT BREAKER
GFCB	GROUND FAULT CIRCUIT BREAKER
HBCB	HOT BOX CIRCUIT BREAKER
LCB	LIGHT CIRCUIT BREAKER
MCB	MAIN CIRCUIT BREAKER
MD	MOTORIZED DAMPER
MPCB	MOTOR POWER CIRCUIT BREAKER
PCB	PUMP CIRCUIT BREAKER
PHCB	PANEL HEATER CIRCUIT BREAKER
RCB	RECEPTACLE CIRCUIT BREAKER
SCB	SPARE CIRCUIT BREAKER
TR	TRANSFORMER
TCB	TRANSFORMER CIRCUIT BREAKER
TR	TELEMETRY RADIO
VCCB	VALVE CONTROLS CIRCUIT BREAKER
VFD	VARIABLE FREQUENCY DRIVE


" "	QUOTATION AROUND TEXT INDICATES A SCHEDULED ITEM
*	THESE LETTERS ADJACENT TO ANY SYMBOL INDICATES DEVICE BOTTOM TO BE MOUNTED 4" ABOVE COUNTER TOP BACKSPASH
GFCI	THESE LETTERS ADJACENT TO ANY SYMBOL INDICATES GROUND FAULT INTERRUPTER
IG	THESE LETTERS ADJACENT TO ANY SYMBOL INDICATES ISOLATED GROUND SERVICE
TL	THESE LETTERS ADJACENT TO ANY SYMBOL INDICATES LOCKING OR TWIST-LOCK TYPE DEVICE
WP	THESE LETTERS ADJACENT TO ANY SYMBOL INDICATES WEATHER-PROOF ENCLOSURE
XP	THESE LETTERS ADJACENT TO ANY SYMBOL INDICATES EXPLOSION-PROOF ENCLOSURE
##"	THESE NUMBERS ADJACENT TO ANY SYMBOL INDICATES THE MOUNTING HEIGHT AFF TO TOP OF OF DEVICE
TP	THESE LETTERS ADJACENT TO ANY SYMBOL INDICATES TAMPER PROOF

**ELECTRICAL SYMBOLS**  
**GRAHAMS ISLAND STATE PARK**  
 NORTH DAKOTA PARKS & RECREATION DEPARTMENT  
 ELECTRICAL UPGRADES  
 BISMARCK, NORTH DAKOTA

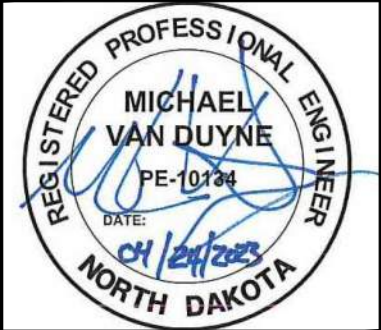


DESIGNED BY:	ARH
DRAWN BY:	SDM
APPROVED BY:	MSV
DESIGN PROJ:	21219.000
CONST PROJ:	
SCALE:	AS NOTED
DATE:	04-24-2023
DRAWING NO:	
<b>GI-E-000</b>	
SHEET NO:	

Last edit on: 4/21/2023 12:25 PM by: SDW01521 Drawing Name: F:\proj\21000\21219\21219.000\AutoCad\Plan Set\Graham's Island\21219.000E - Electrical Improvement Site Plans - GISF.dwg Layout Name: N. HOWARD UTILITY SITE PLAN Plotted By: SDW01521 Plotted on: 4/24/2023 2:21:46 PM

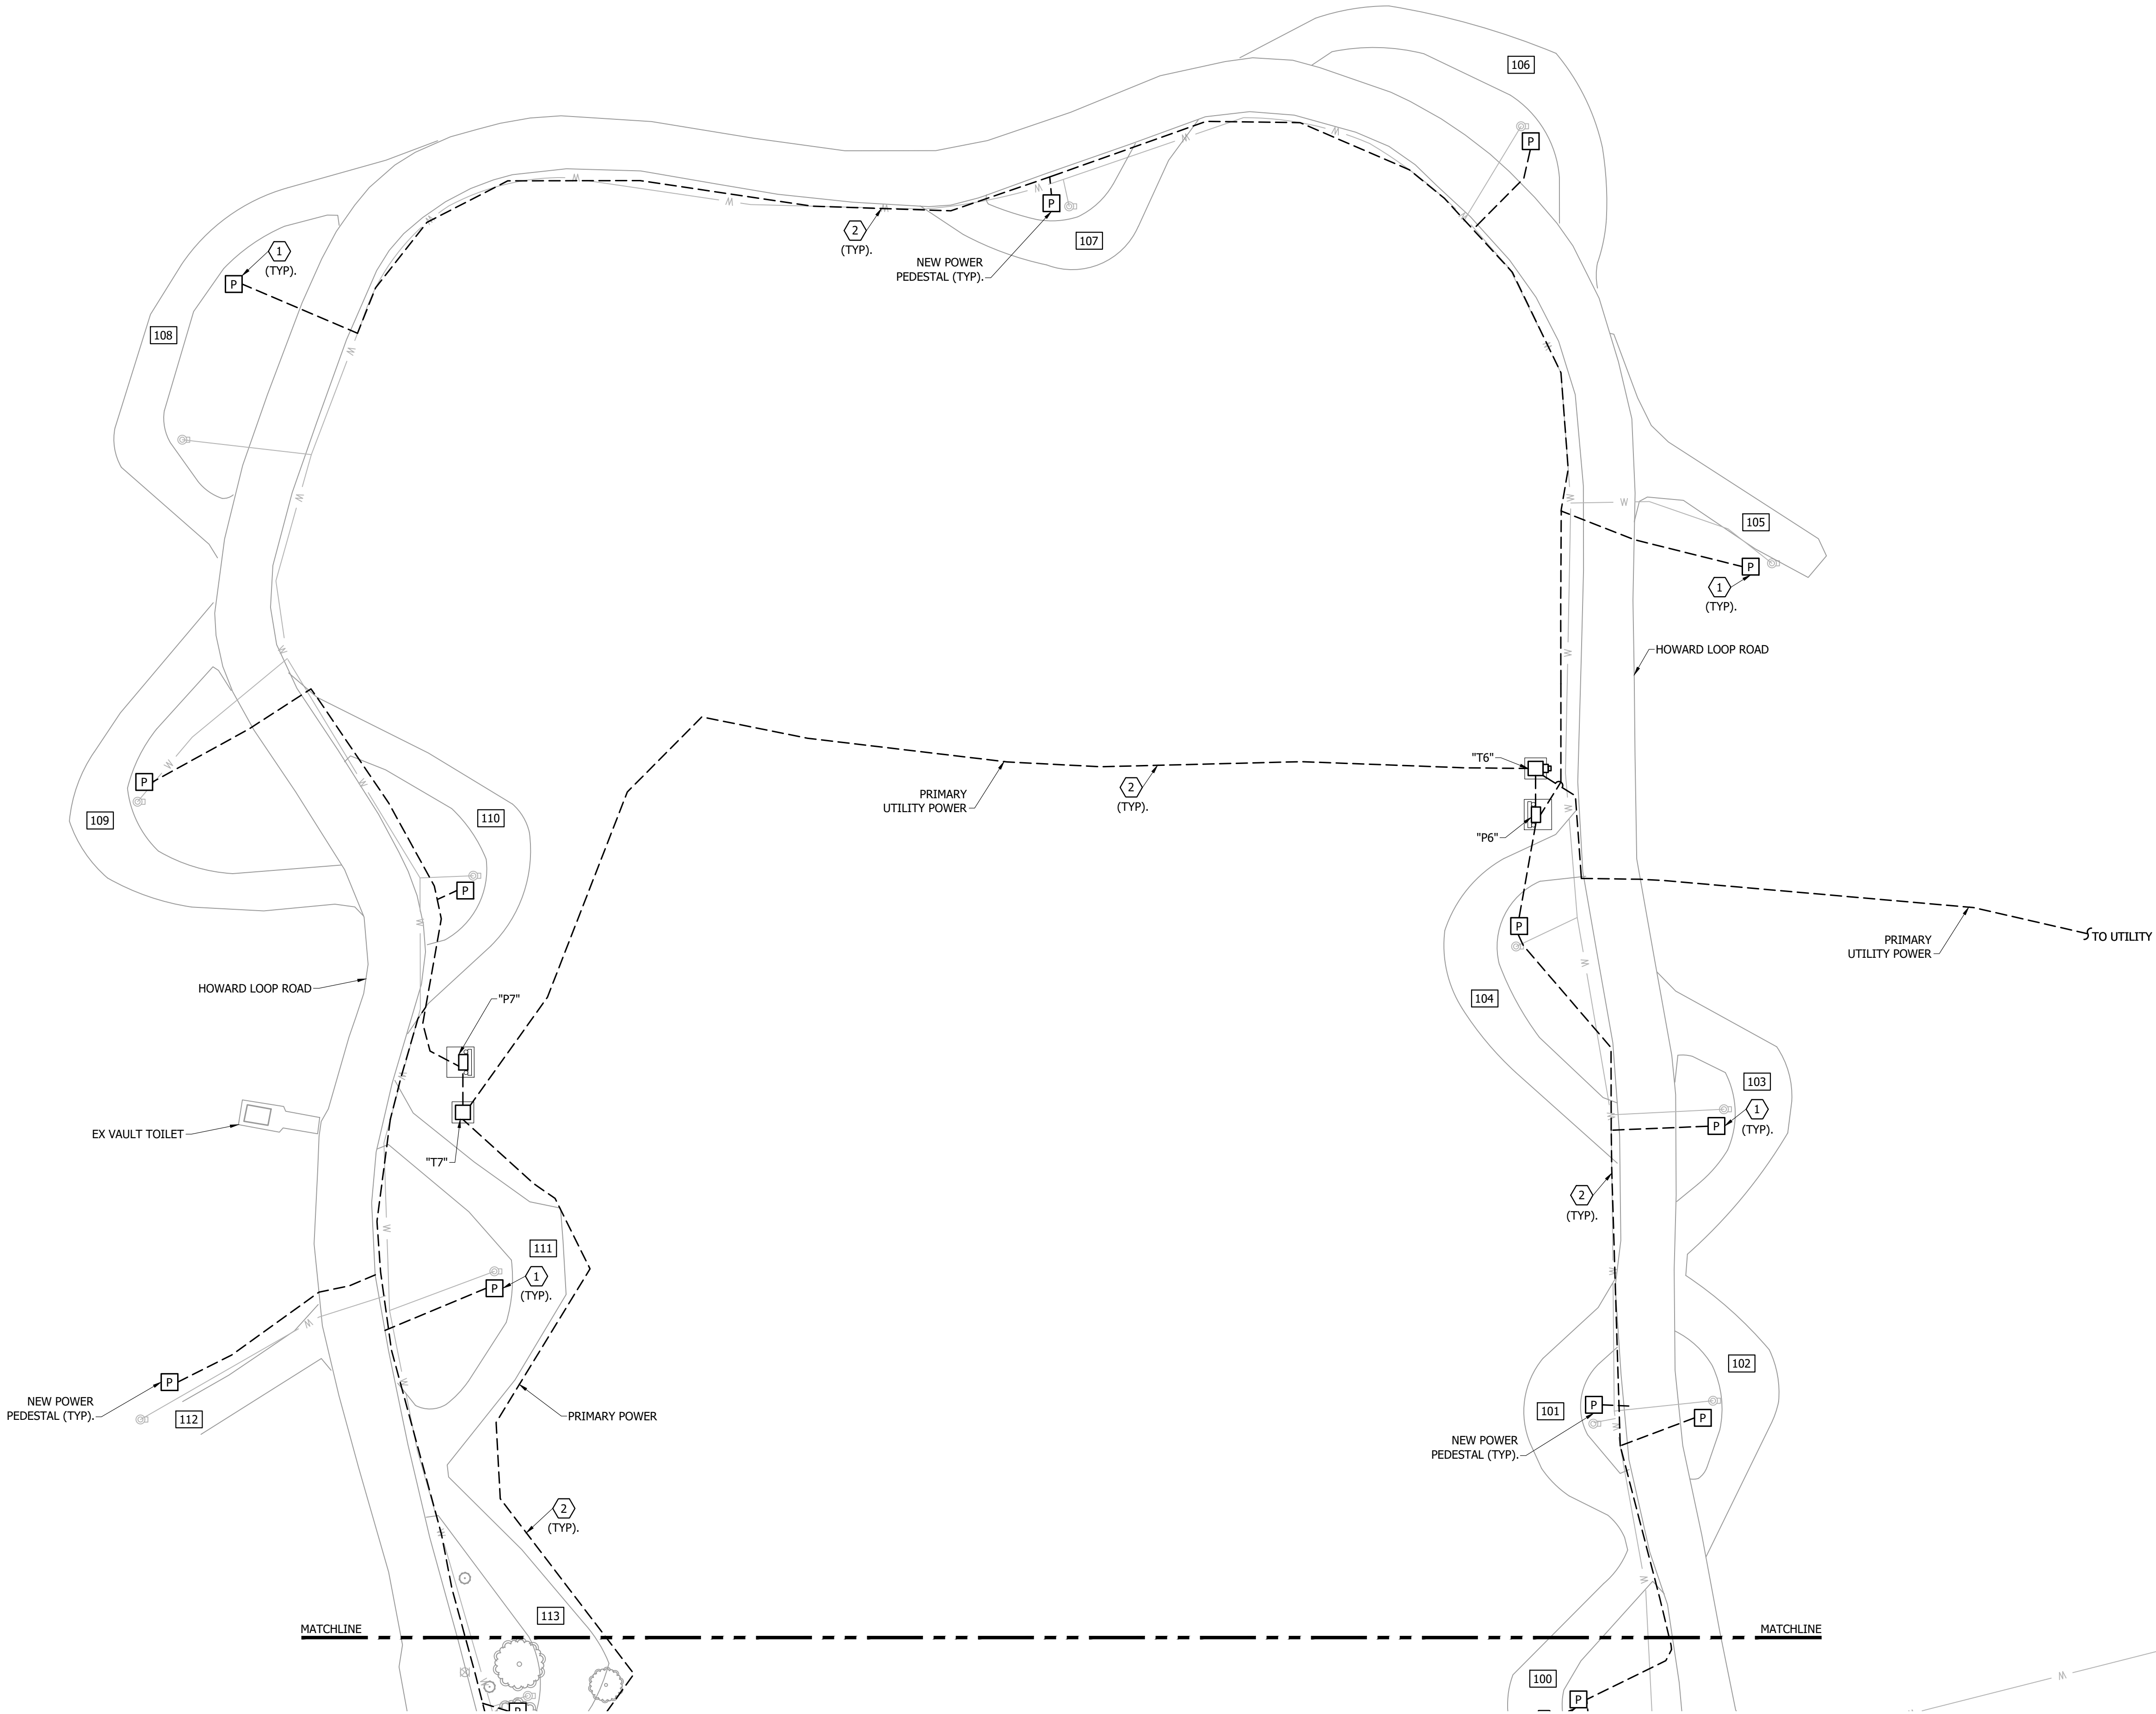

 UTILITY COORDINATION SITE PLAN - NORTH HOWARD CAMPGROUND  
SCALE: 1"=30'

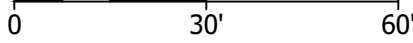

REFERENCE NOTES:

- 1 REFER TO ELECTRICAL SITE DETAIL SHEET GI-E-501 FOR ALL SITE DETAIL AND DIMENSIONS FOR ALL NEW PEDESTALS.
- 2 ALL NEW DIRECT BURY WIRE TO BE A MINIMUM DEPTH OF 24" BELOW FINISHED GRADE BY E/C. REFER TO ELECTRICAL IMPROVEMENT SITE PLANS - HOWARD LOOP FOR NEW ELECTRICAL IMPROVEMENTS.

BY	
DESCRIPTION	
DATE	
#	

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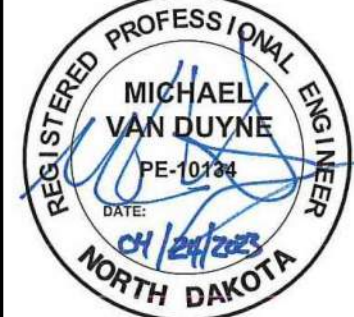
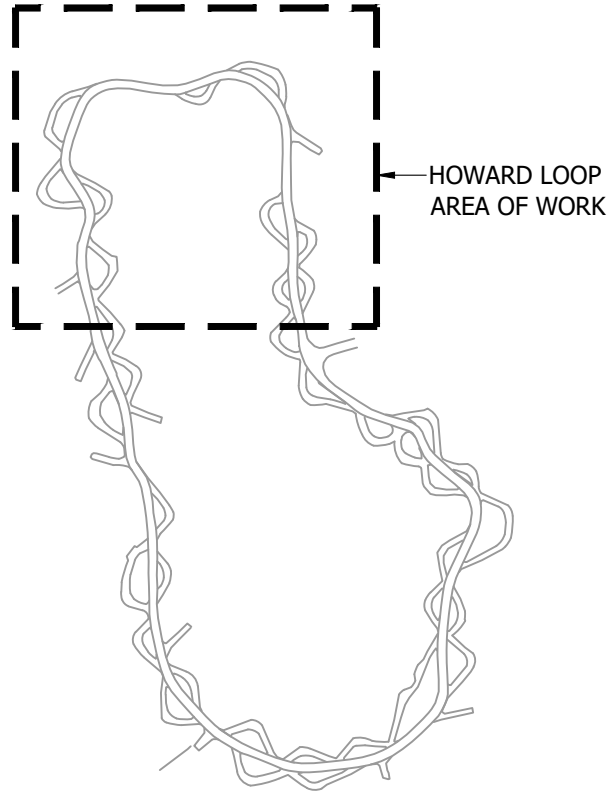
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GENERAL NOTES:

1. ALL UTILITY COORDINATION TO BE COMPLETED BEFORE START OF CONSTRUCTION. THE SEQUENCE OF CONSTRUCTION SHALL TAKE PLACE AS DESCRIBED IN ONE OF THE BELOW OPTIONS.
  - 1.1. THE REMOVAL OF EXISTING ELECTRICAL PEDESTALS, DIRECT BURY WIRE AND INSTALLATION OF NEW PEDESTALS, DIRECT BURY WIRE SHALL BE DONE PRIOR TO INSTALLATION OF NEW ELECTRICAL WATER PIPE AND HYDRANTS.
  - 1.2. CONSTRUCTION OF BOTH ELECTRICAL DEMOLITION/IMPROVEMENT AND WATER IMPROVEMENT SHALL TAKE PLACE AT THE SAME TIME.
2. E/C TO FIELD COORDINATE ALL WORK WITH OTHER TRADES.


UTILITY COORDINATION SITE PLAN  
NORTH HOWARD CAMPGROUND  
GRAHAM'S ISLAND STATE PARK  
NORTH DAKOTA PARKS & RECREATION DEPARTMENT  
ELECTRICAL UPGRADES  
BISMARCK, NORTH DAKOTA

KEY PLAN:



DESIGNED BY:	ARH
DRAWN BY:	ARH/SDM
APPROVED BY:	MSV
DESIGN PROJ:	21219.000
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SCALE:	AS NOTED
DATE:	04-24-2023
DRAWING NO:	<b>GI-UC-101</b>
SHEET NO:	3 of 32

Last edit on: 4/21/2023 12:25 PM by: SDM01521 Drawing Name: F:\proj\21000\21219\21219\01219.000\AutoCad\Plan Set\Graham's Island\21219.000E - Electrical Improvement Site Plans - GISP.dwg Layout Name: W - HOWARD UTILITY SITE PLAN Plotted By: SDM01521 Plotted on: 4/24/2023 2:21:46 PM

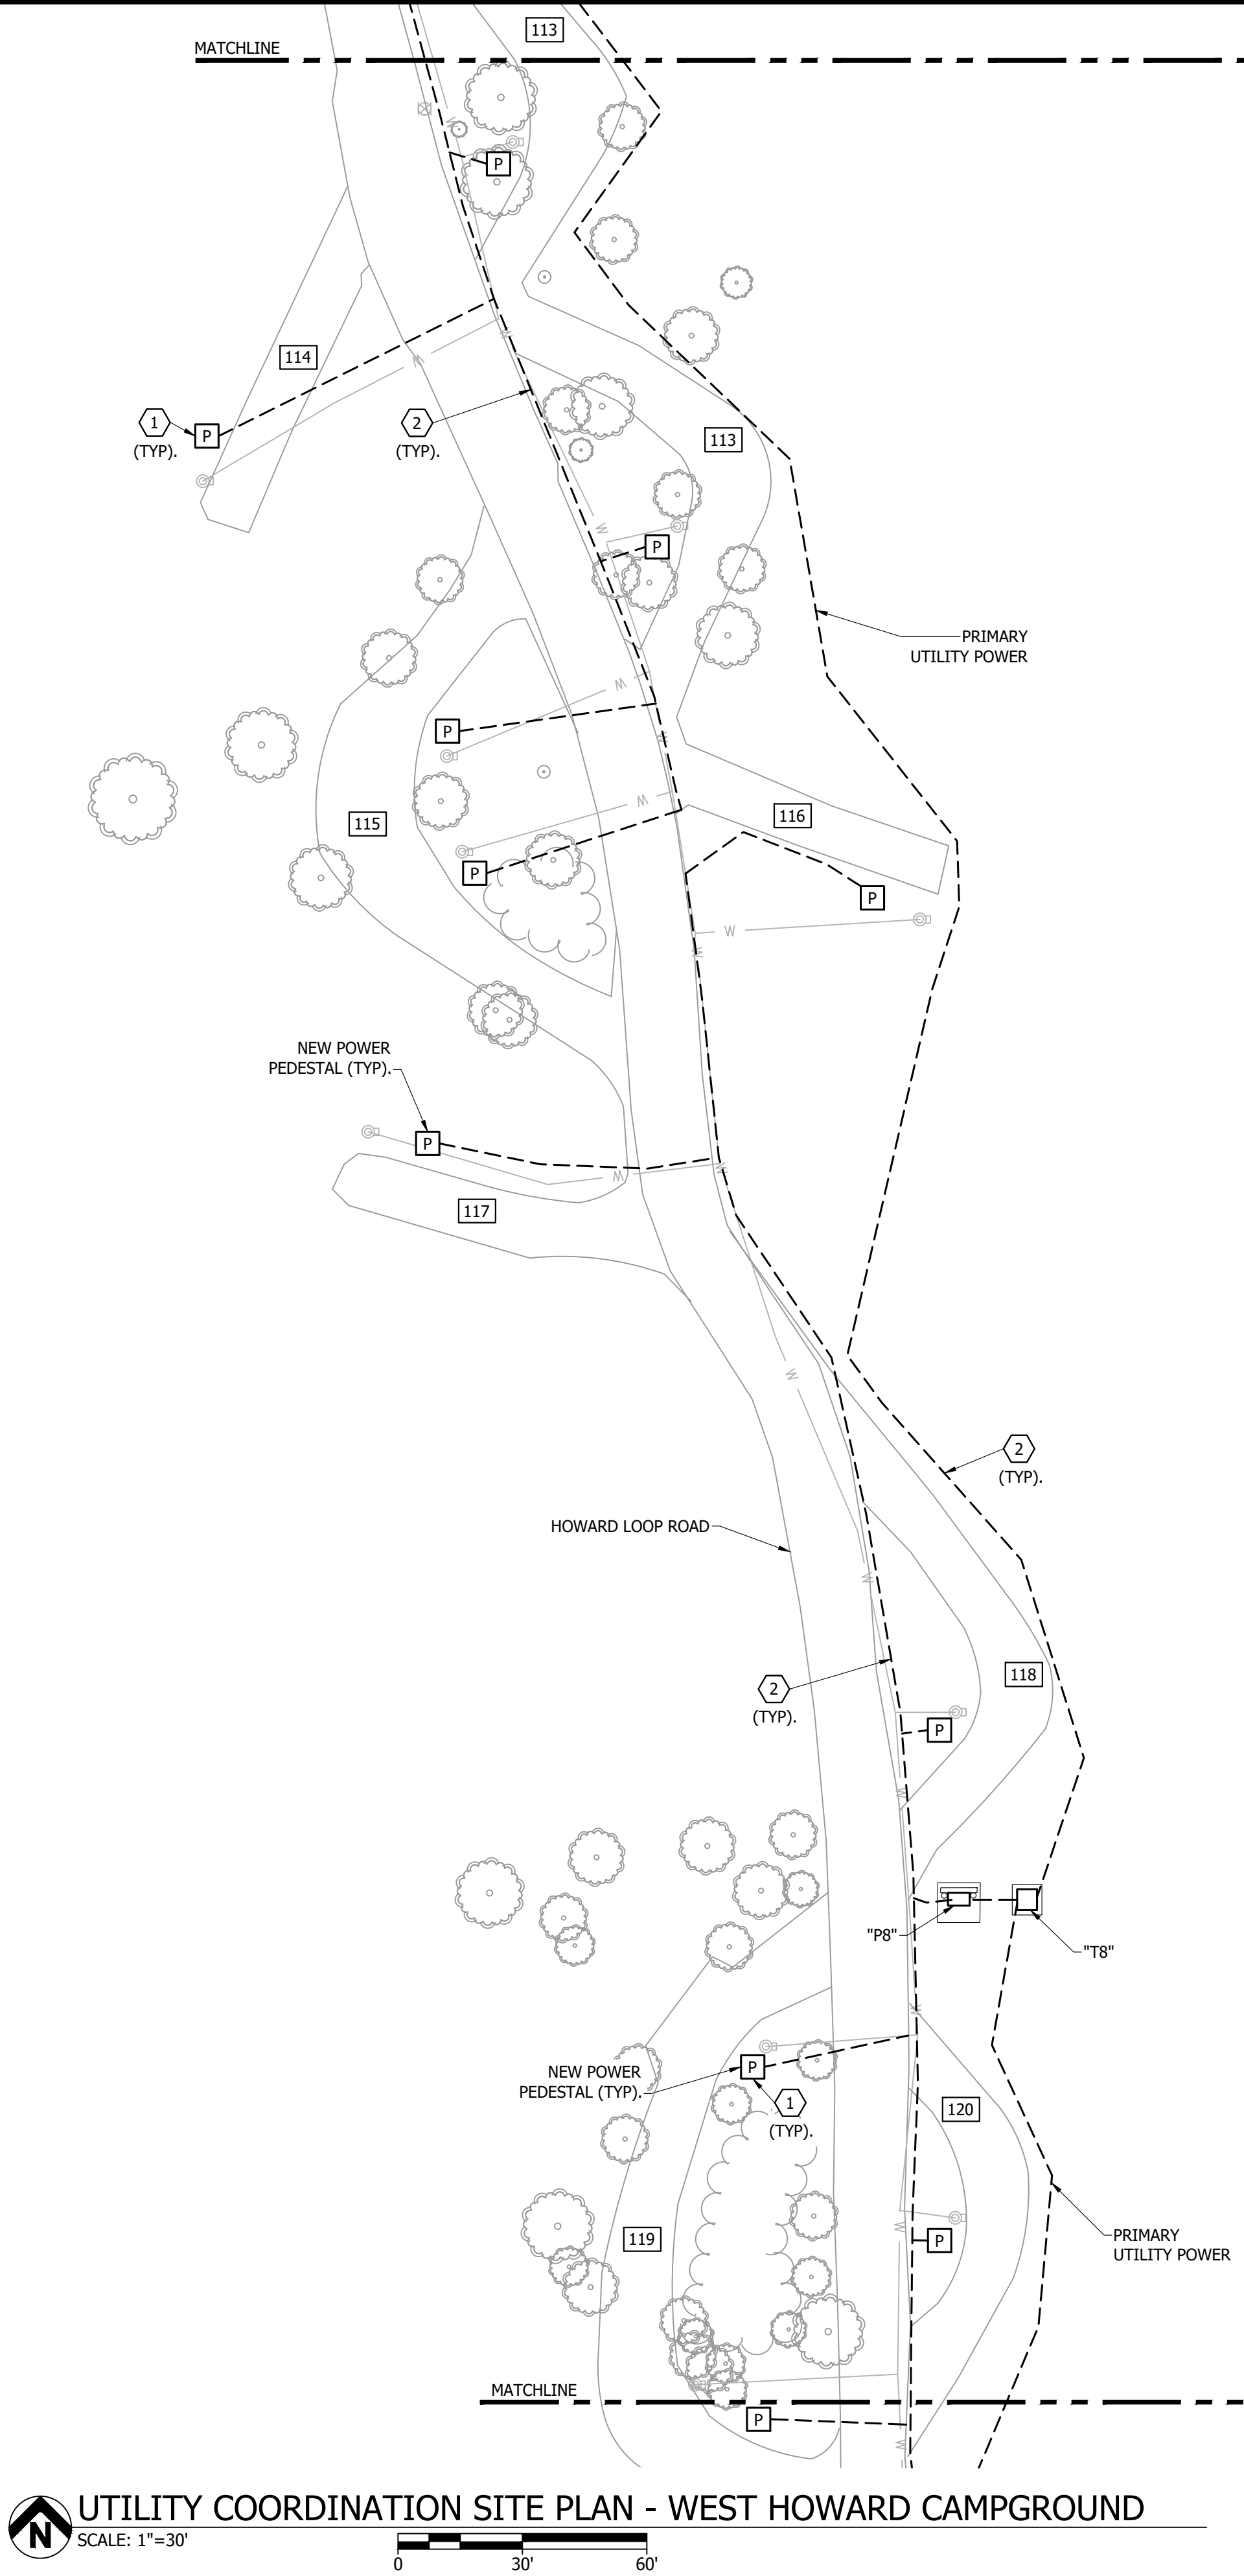

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REFERENCE NOTES:

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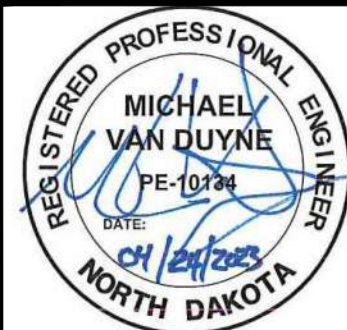
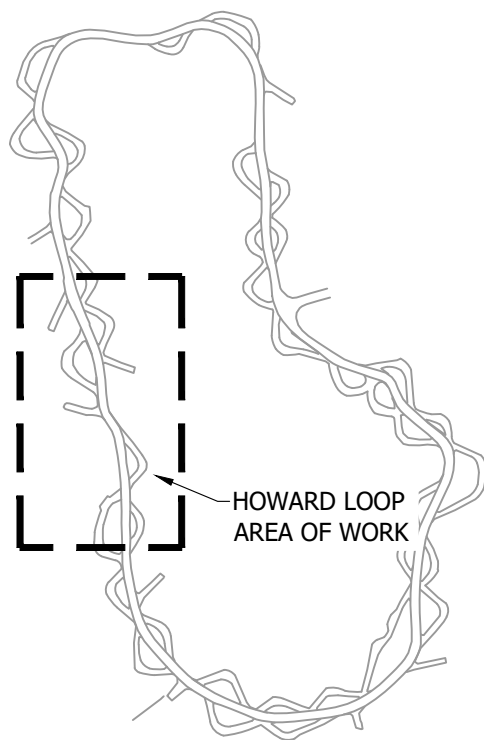
3456 E CENTURY AVENUE - BISMARCK, ND 58503  
PHONE 701-258-1110 - FAX 701-258-1111  
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GENERAL NOTES:

1. ALL UTILITY COORDINATION TO BE COMPLETED BEFORE START OF CONSTRUCTION. THE SEQUENCE OF CONSTRUCTION SHALL TAKE PLACE AS DESCRIBED IN ONE OF THE BELOW OPTIONS.
  - 1.1. THE REMOVAL OF EXISTING ELECTRICAL PEDESTALS, DIRECT BURY WIRE AND INSTALLATION OF NEW PEDESTALS, DIRECT BURY WIRE SHALL BE DONE PRIOR TO INSTALLATION OF NEW ELECTRICAL WATER PIPE AND HYDRANTS.
  - 1.2. CONSTRUCTION OF BOTH ELECTRICAL DEMOLITION/IMPROVEMENT AND WATER IMPROVEMENT SHALL TAKE PLACE AT THE SAME TIME.
2. E/C TO FIELD COORDINATE ALL WORK WITH OTHER TRADES.

UTILITY COORDINATION SITE PLAN  
WEST HOWARD CAMPGROUND  
GRAHAM'S ISLAND STATE PARK  
NORTH DAKOTA PARKS & RECREATION DEPARTMENT  
ELECTRICAL UPGRADES  
BISMARCK, NORTH DAKOTA

KEY PLAN:



DESIGNED BY:	ARH
DRAWN BY:	ARH/SDM
APPROVED BY:	MSV
DESIGN PROJ:	21219.000
CONST PROJ:	
SCALE:	AS NOTED
DATE:	04-24-2023
DRAWING NO:	<b>GI-UC-102</b>
SHEET NO:	4 of 32




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**Bartlett & West**

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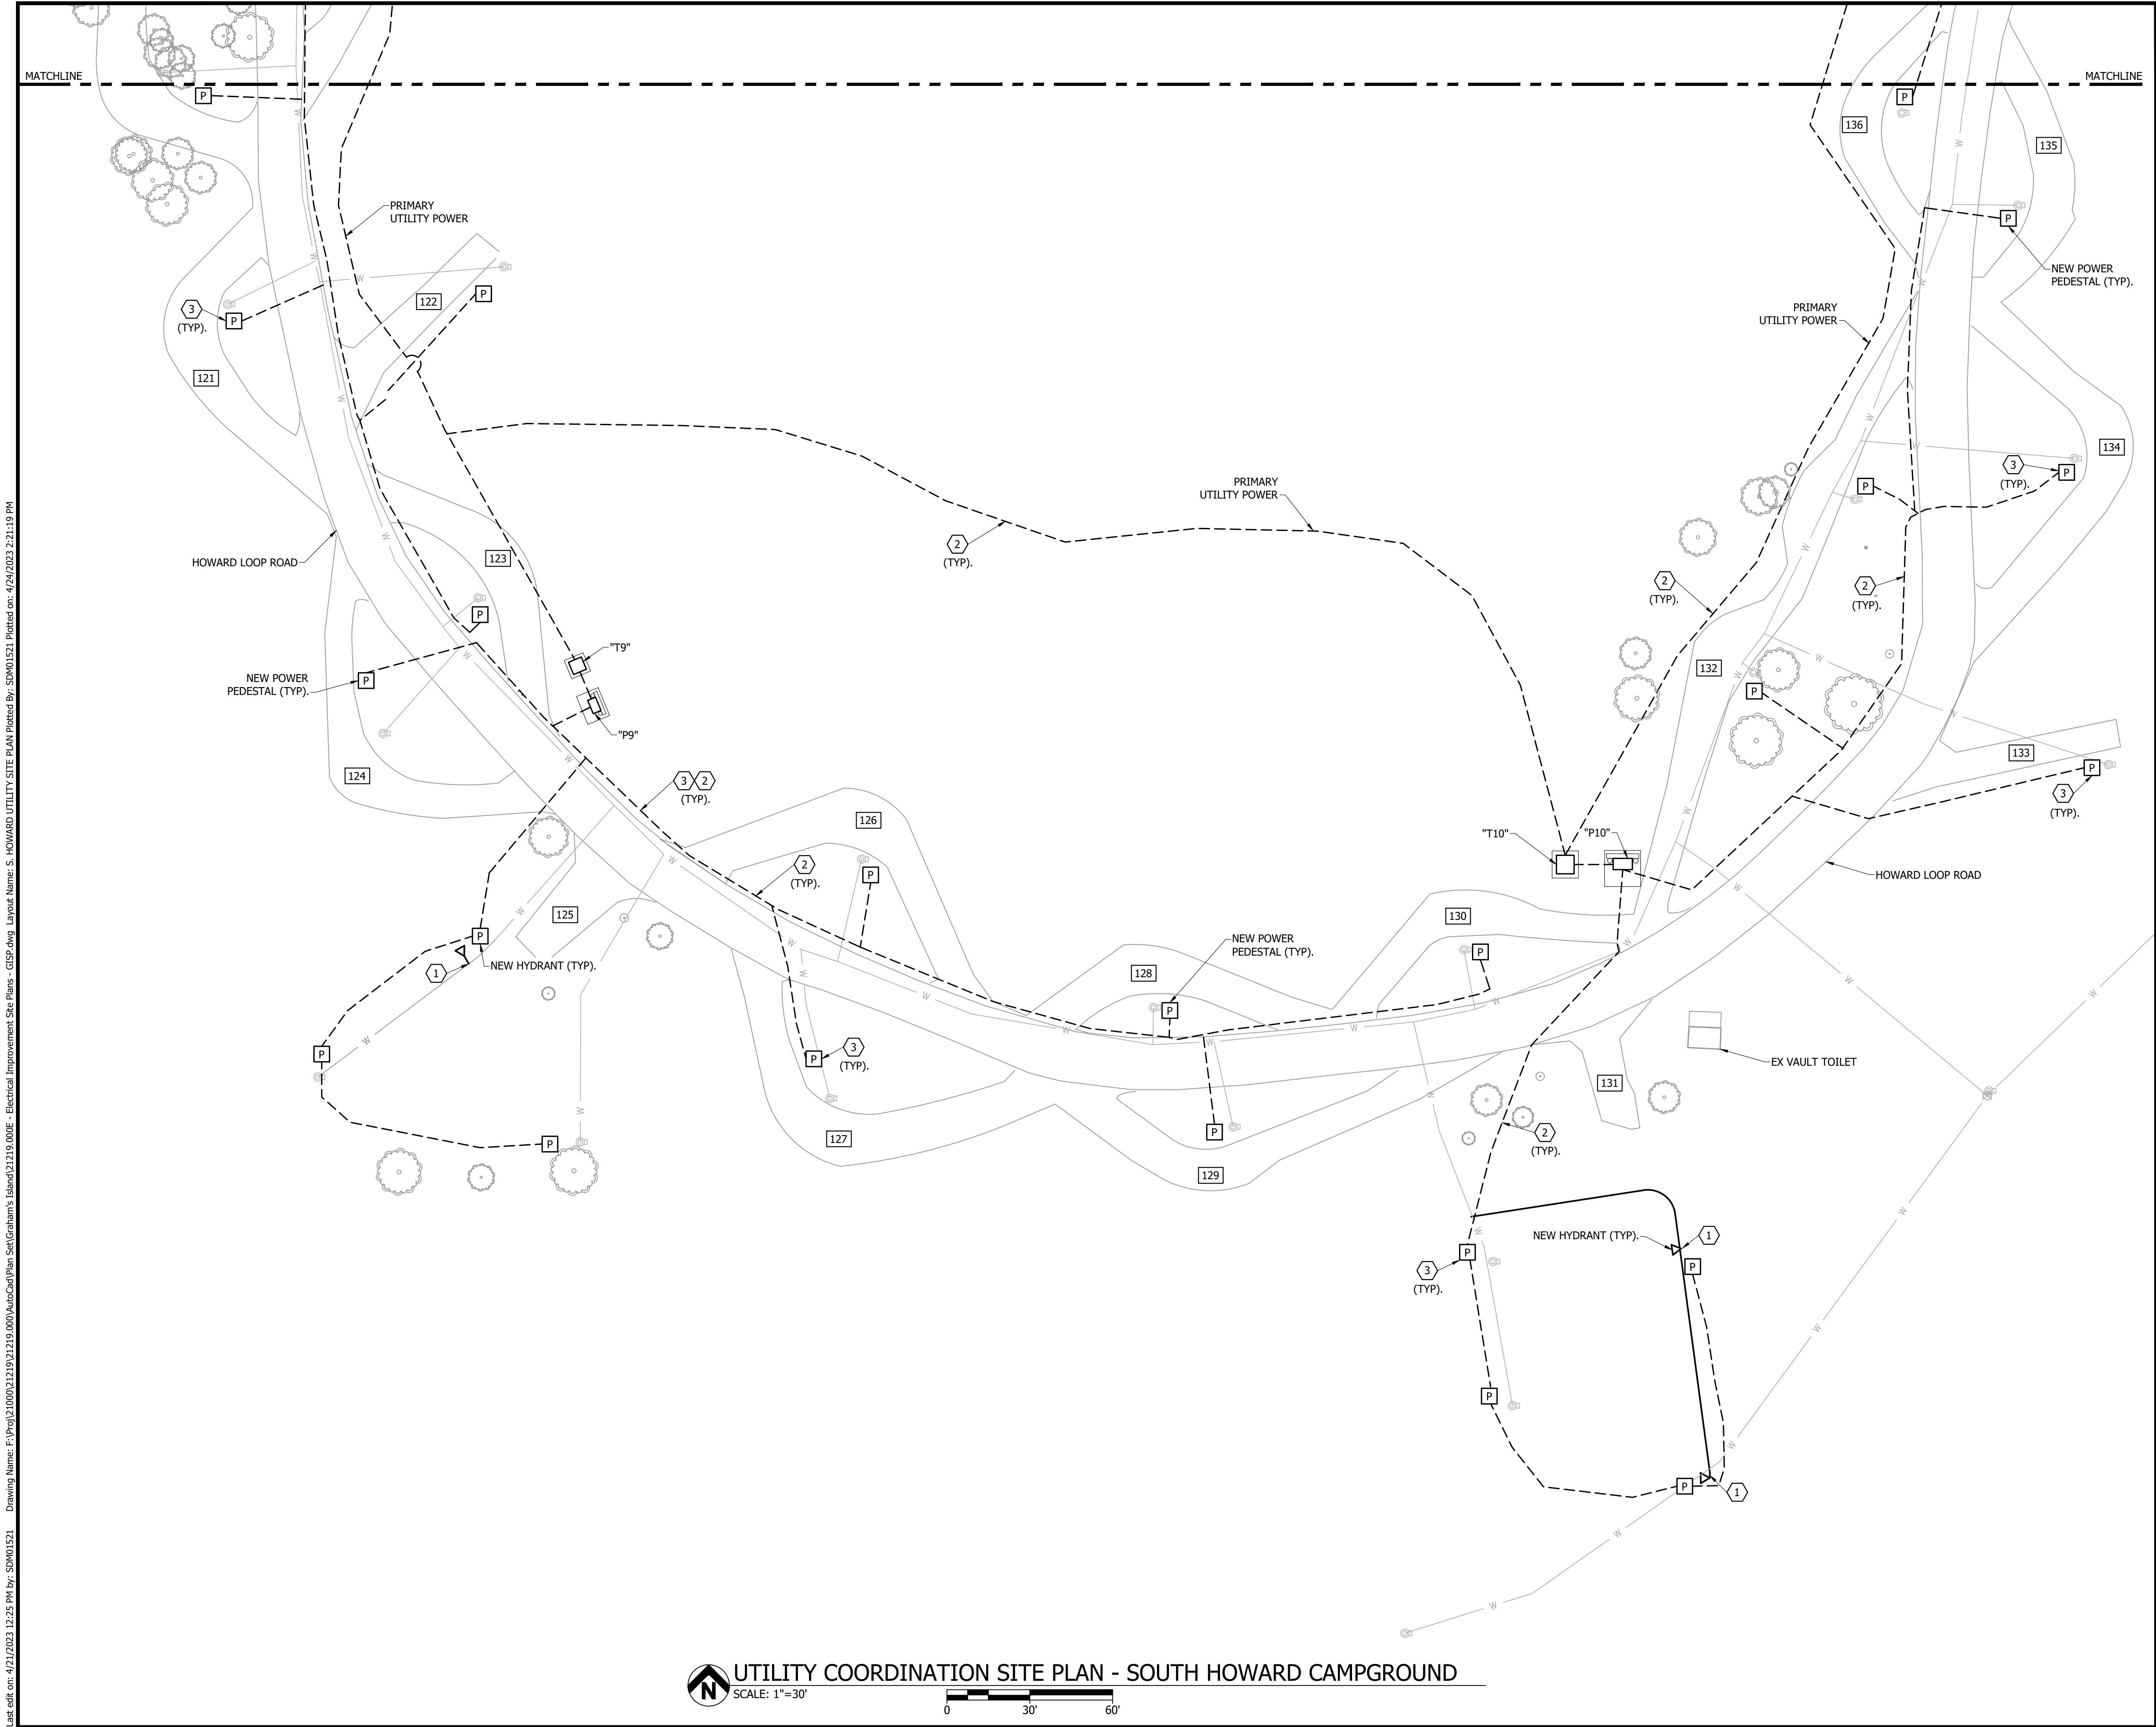
A diagram of a DNA molecule represented by a tangled line. A dashed rectangular box highlights a specific region on the right side of the molecule. An arrow points from the text "HOWARD LOOP AREA OF WORK" to this dashed box.

**UTILITY COORDINATION SITE PLAN  
EAST HOWARD CAMPGROUND  
GRAHAMS ISLAND STATE PARK  
NORTH DAKOTA PARKS & RECREATION DEPARTMENT  
ELECTRICAL UPGRADES  
BISMARCK, NORTH DAKOTA**



DESIGNED BY:	ARH
DRAWN BY:	ARH/SDM
APPROVED BY:	MSV
DESIGN PROJ:	21219.000
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SHEET NO:	
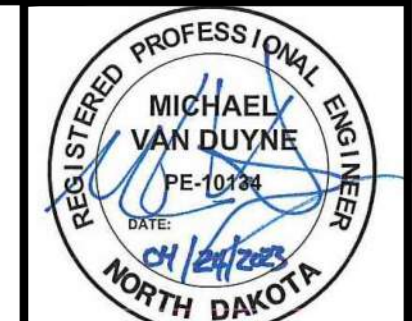
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REFERENCE NOTES:	
1	ALL NEW WATER PIPE TO BE BURIED APPROXIMATELY 36" TO TOP OF PIPE BELOW FINISHED GRADE BY P/C. REFER TO WATER IMPROVEMENT SITE PLANS - HOWARD LOOP FOR NEW WATER IMPROVEMENTS.
2	ALL NEW DIRECT BURY WIRE TO BE A MINIMUM DEPTH OF 24" BELOW FINISHED GRADE BY E/C. REFER TO ELECTRICAL IMPROVEMENT SITE PLANS - HOWARD LOOP FOR NEW ELECTRICAL IMPROVEMENTS.
3	REFER TO ELECTRICAL SITE DETAIL SHEET GI-E-501 FOR ALL SITE DETAIL AND DIMENSIONS FOR ALL NEW PEDESTALS.

BY

DESCRIPTION

DATE

#

**Bartlett & West**  
3456 E CENTURY AVENUE - BISMARCK, ND 58503  
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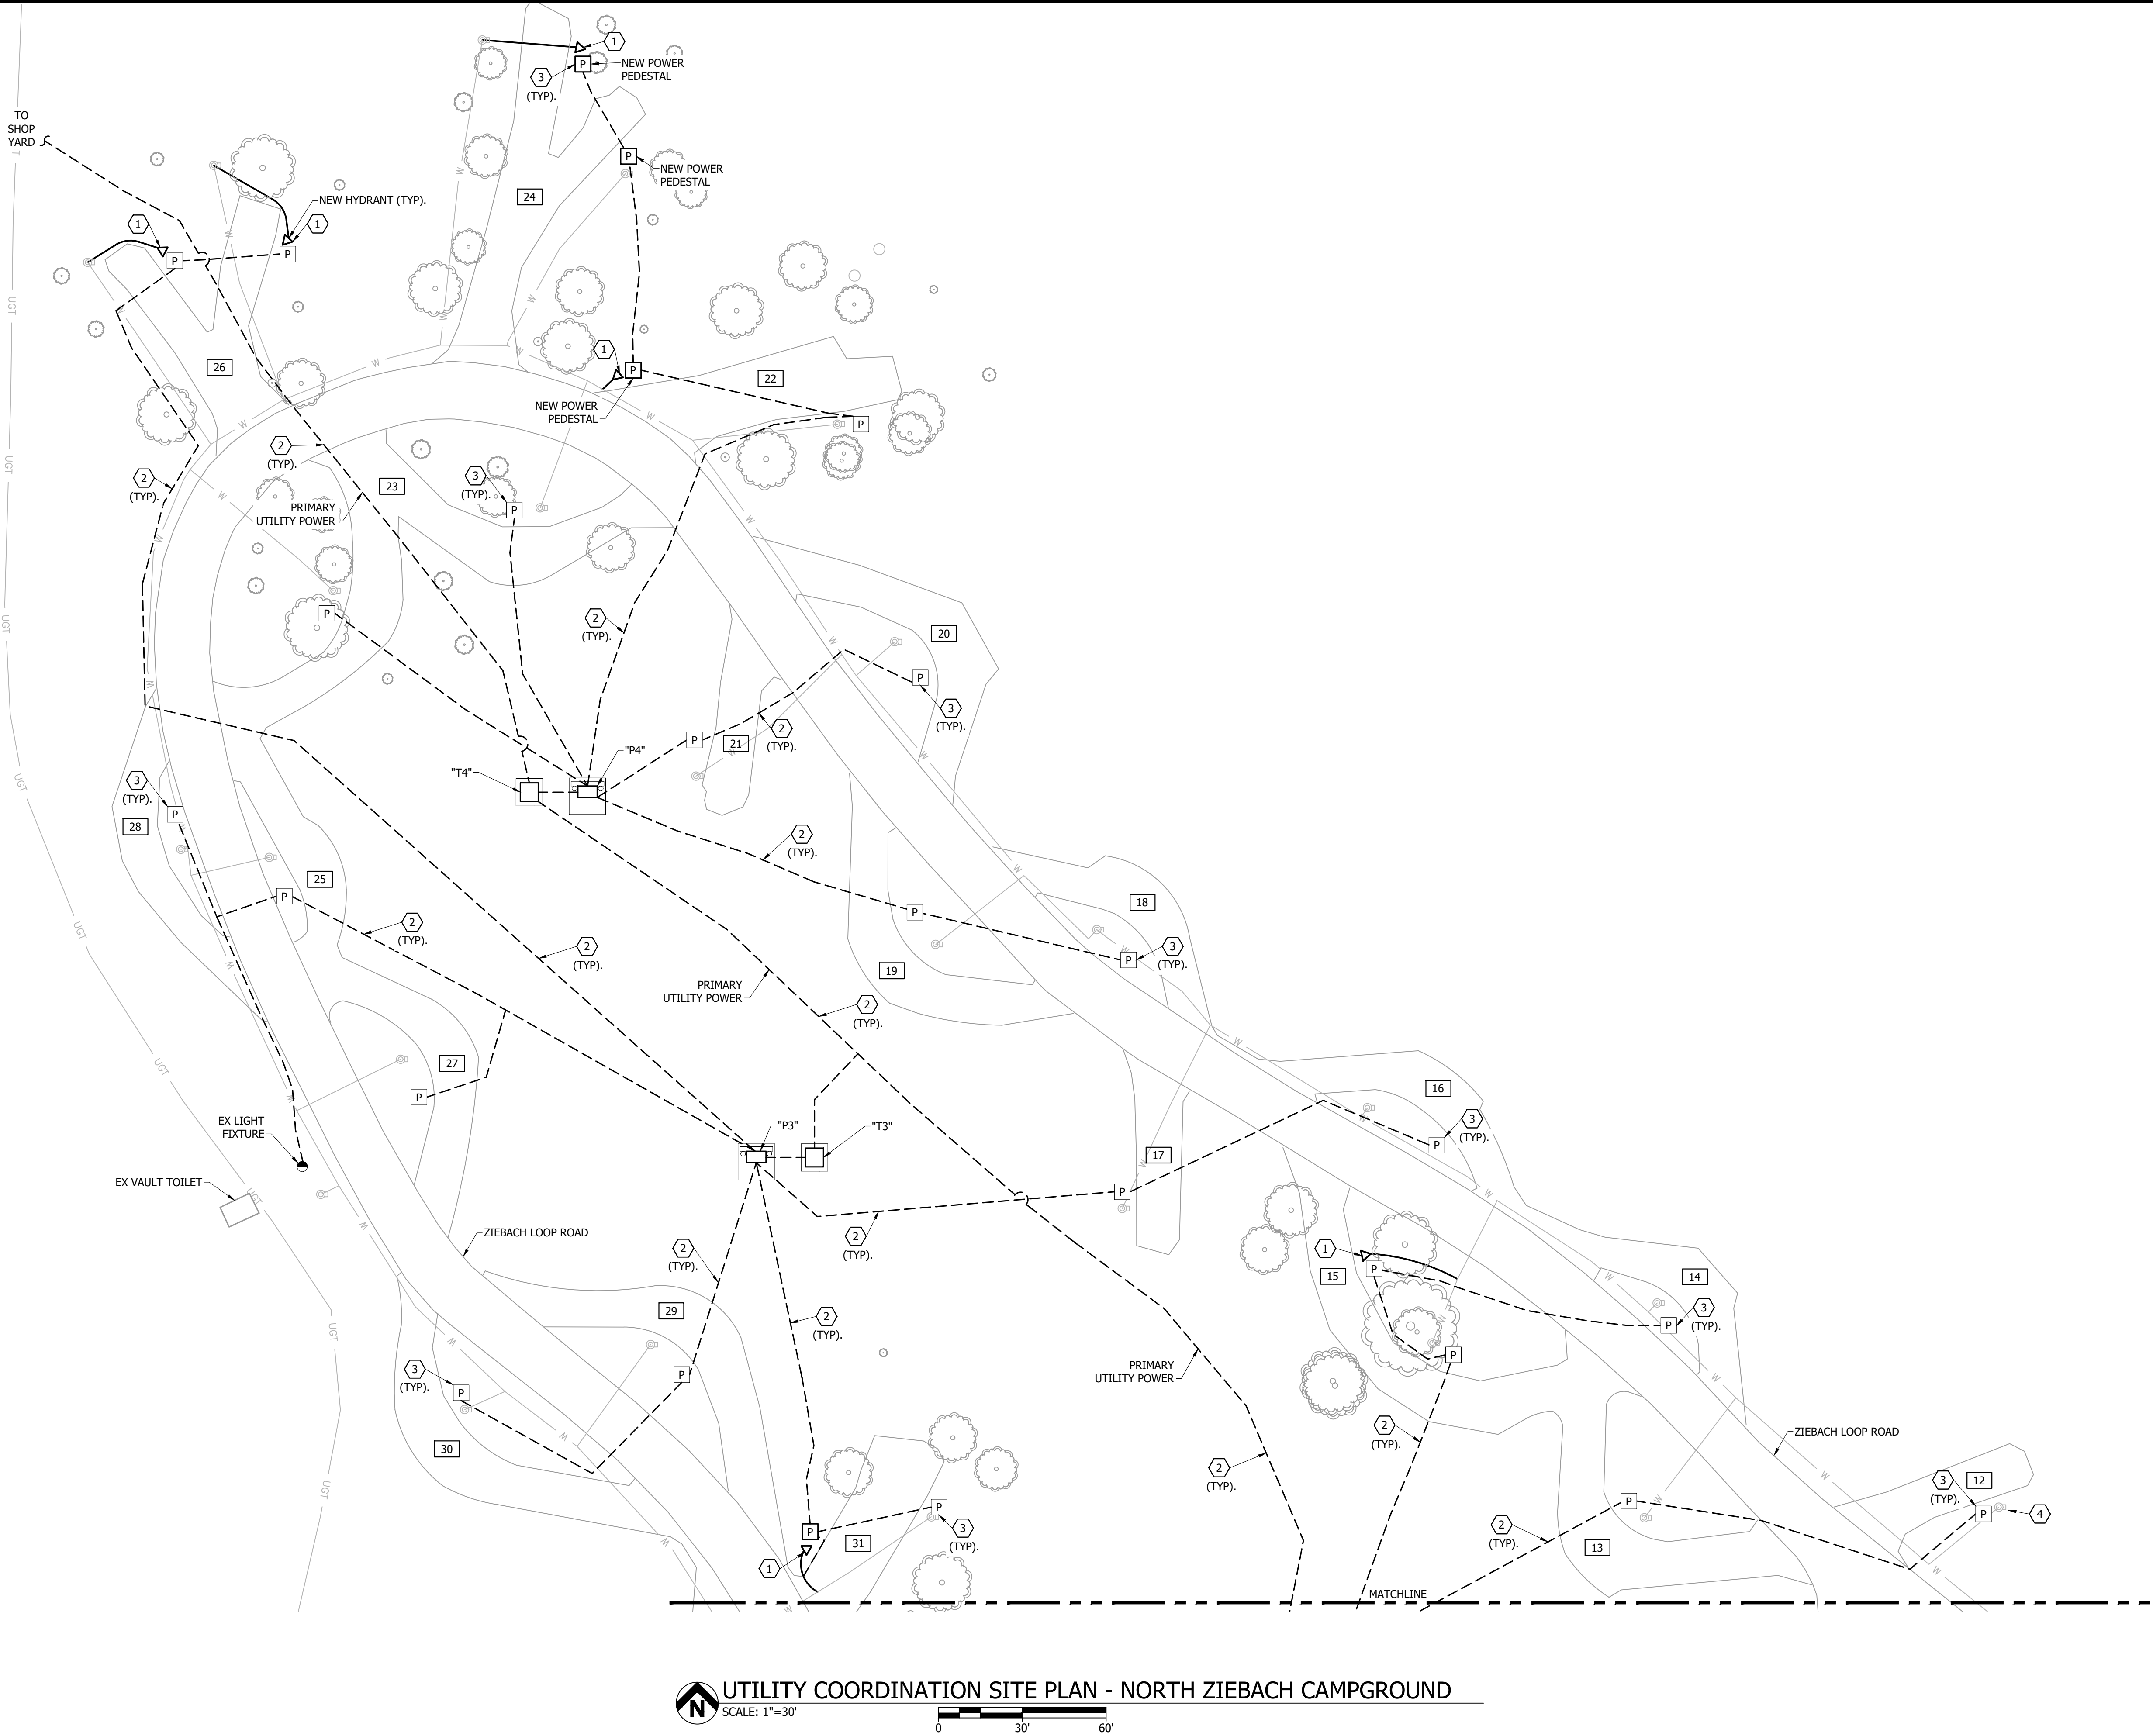
**KEY PLAN:**

**UTILITY COORDINATION SITE PLAN**  
**SOUTH HOWARD CAMPGROUND**  
**GRAHAMS ISLAND STATE PARK**  
**NORTH DAKOTA PARKS & RECREATION DEPARTMENT**  
**ELECTRICAL UPGRADES**  
**BISMARCK, NORTH DAKOTA**

REGISTERED PROFESSIONAL ENGINEER  
MICHAEL VAN DUYN  
PE-10724  
DATE: 04/24/2023  
NORTH DAKOTA

DESIGNED BY:	ARH
DRAWN BY:	ARH/SDM
APPROVED BY:	MSV
DESIGN PROJ:	21219.000
CONST PROJ:	
SCALE:	AS NOTED
DATE:	04-24-2023
DRAWING NO:	<b>GI-UC-104</b>
SHEET NO:	6 of 32

Last edit on: 4/21/2023 12:25 PM by: SDM01521 Drawing Name: F:\Proj\21000\21219\21219.000\AutoCad\Plan Set\Graham's Island\21219.000E - Electrical Improvement Site Plans - GISP.dwg Layout Name: N. ZIEBACH UTILITY SITE PLAN Plotted By: SDM01521 Plotted on: 4/24/2023 2:21:10 PM



 UTILITY COORDINATION SITE PLAN - NORTH ZIEBACH CAMPGROUND  
SCALE: 1"=30'


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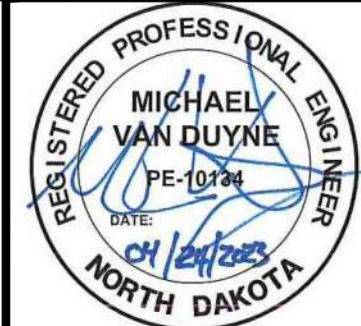
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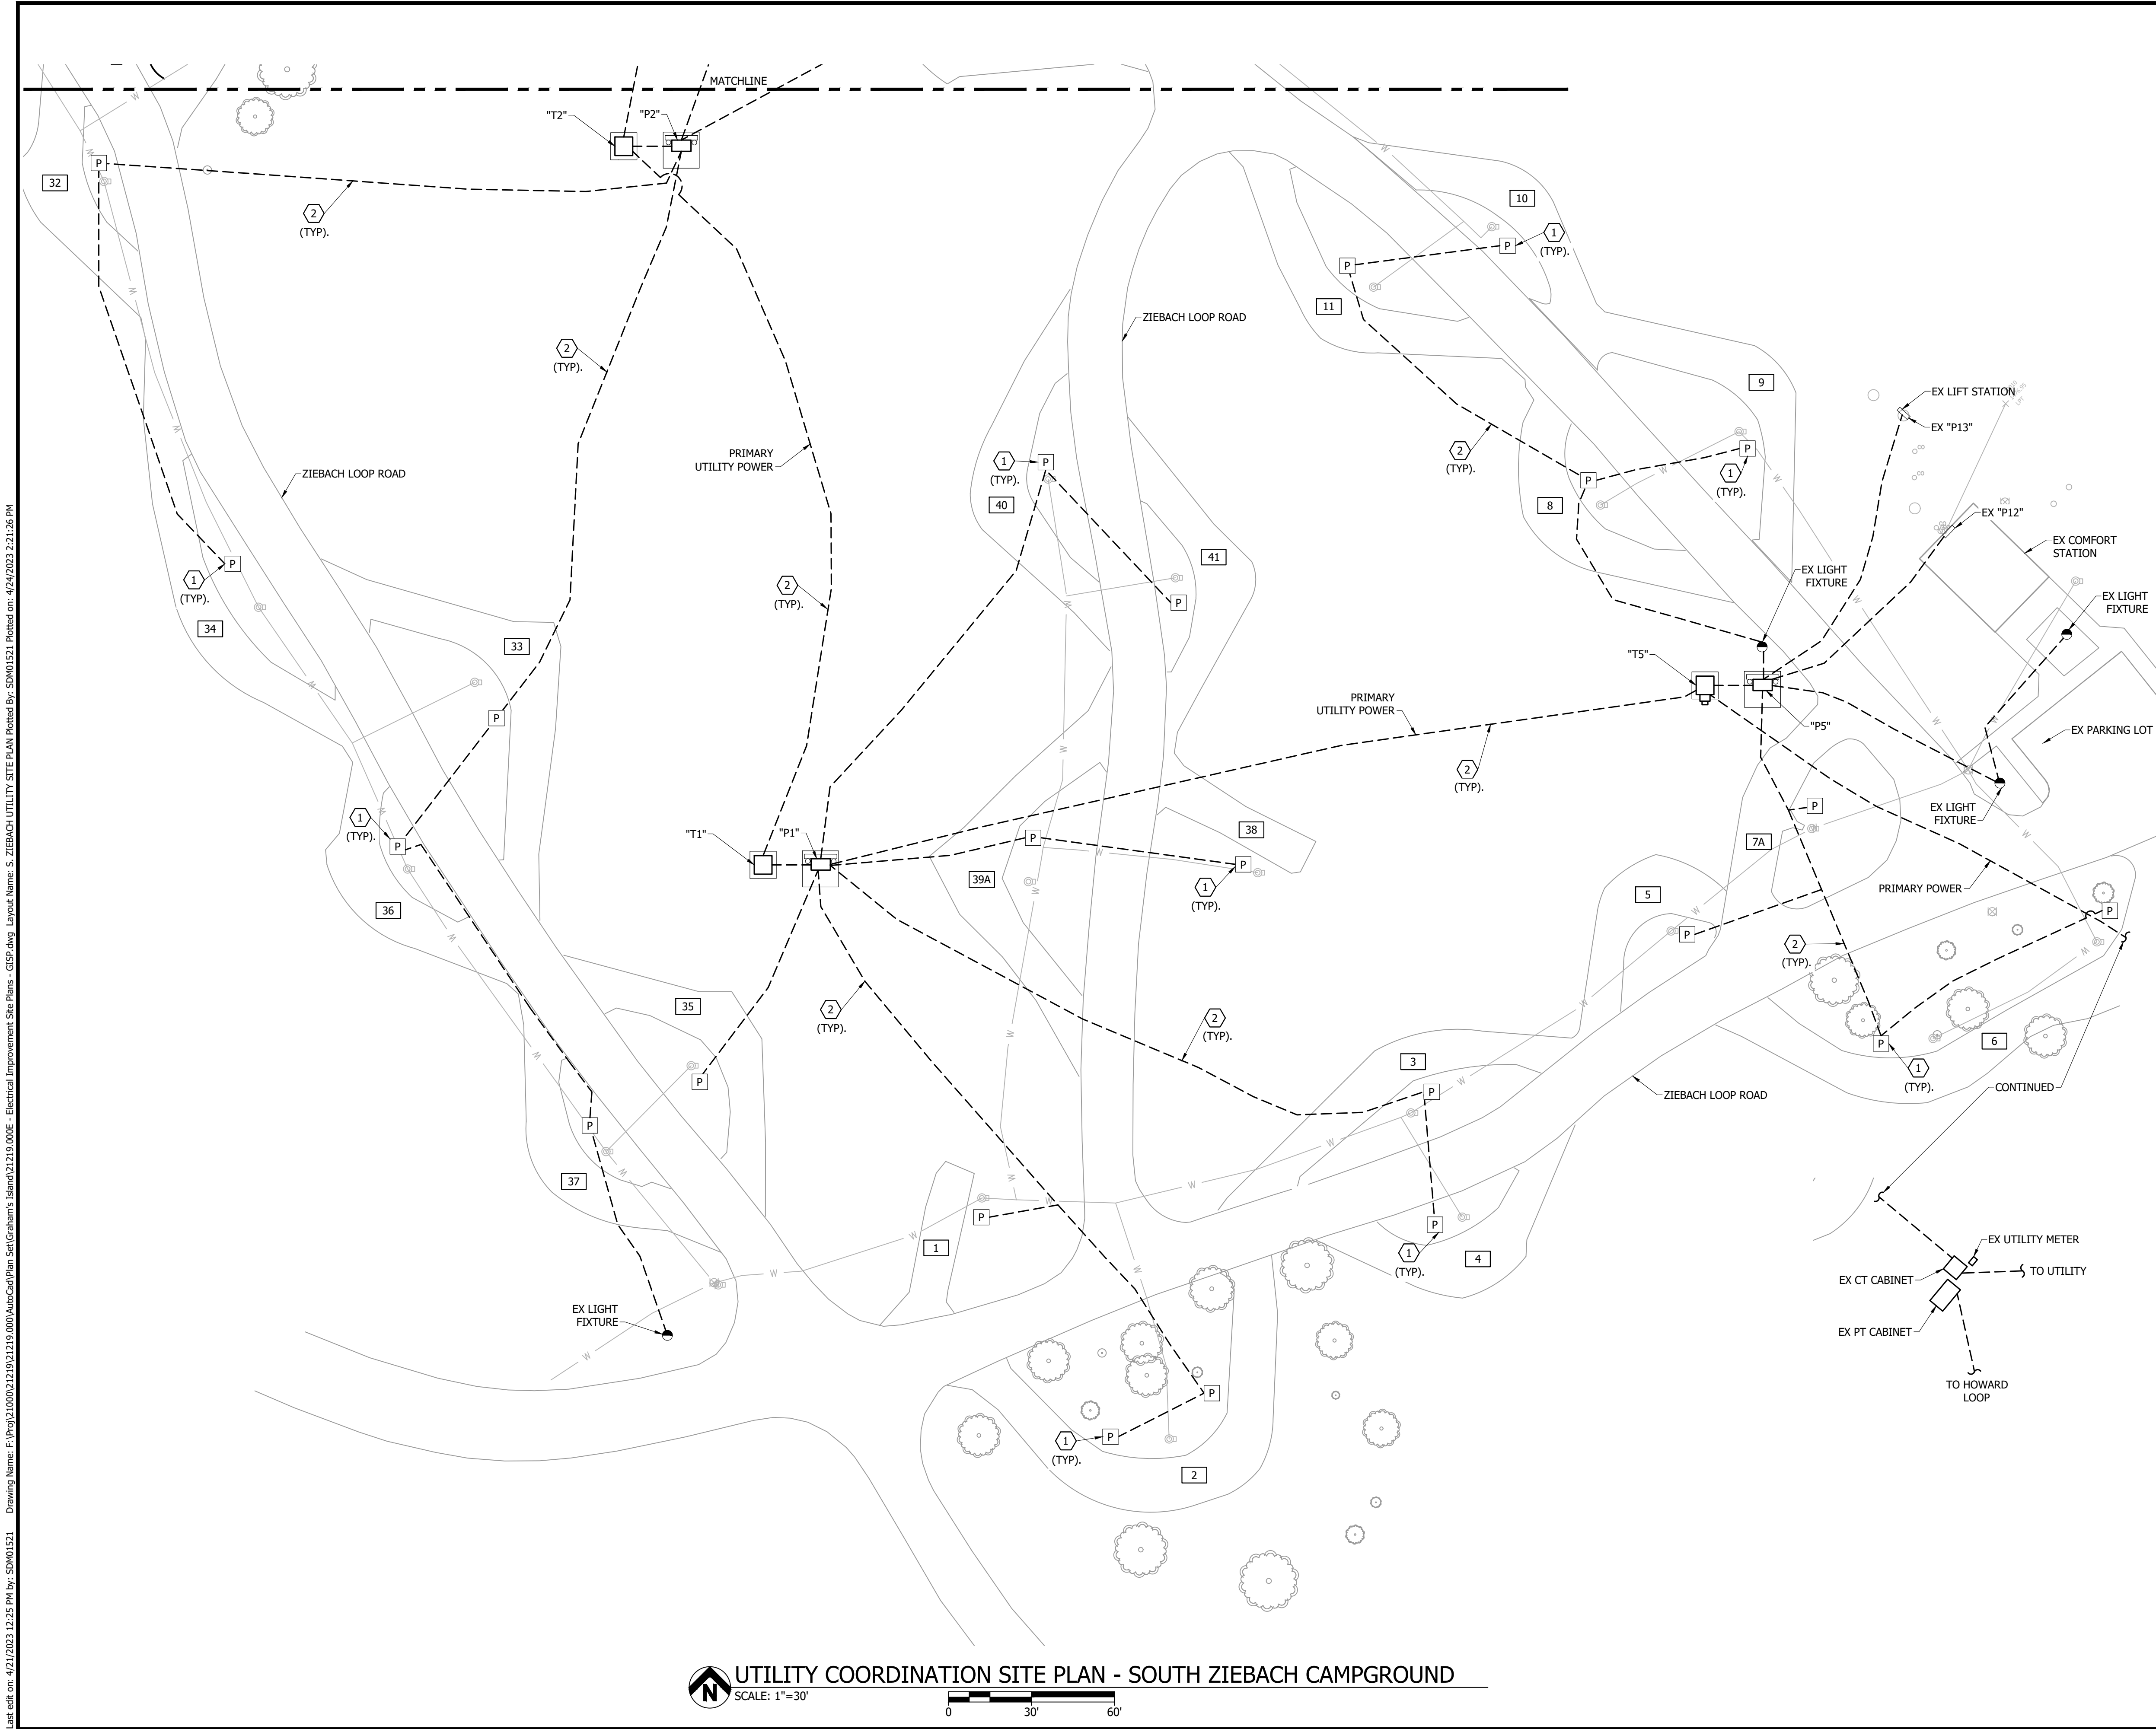
KEY PLAN:



UTILITY COORDINATION SITE PLAN  
NORTH ZIEBACH CAMPGROUND  
GRAHAM'S ISLAND STATE PARK  
NORTH DAKOTA PARKS & RECREATION DEPARTMENT  
ELECTRICAL UPGRADES  
BISMARCK, NORTH DAKOTA



DESIGNED BY:	ARH
DRAWN BY:	ARH/SDM
APPROVED BY:	MSV
DESIGN PROJ:	21219.000
CONST PROJ:	
SCALE:	AS NOTED
DATE:	04-24-2023
DRAWING NO:	<b>GI-UC-105</b>
SHEET NO:	7 of 32

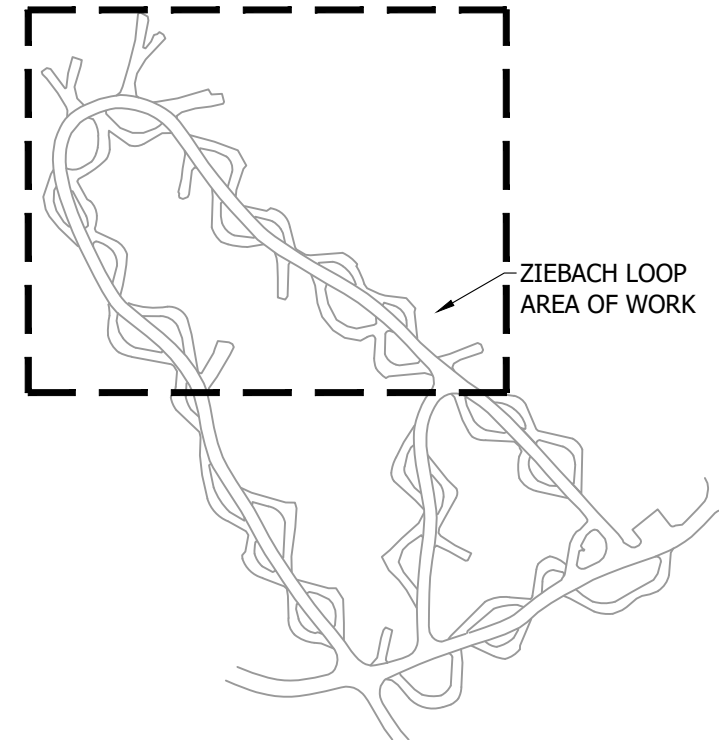

REFERENCE NOTES:

1

REFER TO ELECTRICAL SITE DETAIL SHEET GI-E-501 FOR ALL SITE DETAIL AND DIMENSIONS FOR ALL NEW PEDESTALS.

2

ALL NEW DIRECT BURY WIRE TO BE A MINIMUM DEPTH OF 24" BELOW FINISHED GRADE BY E/C. REFER TO ELECTRICAL IMPROVEMENT SITE PLANS - ZIEBACH LOOP FOR NEW ELECTRICAL IMPROVEMENTS.

DESCRIPTION

DATE

#

Bartlett & West

3456 E CENTURY AVENUE - BISMARCK, ND 58503

PHONE 701-258-1110 - FAX 701-258-1111

WWW.BARTLETTANDWEST.COM

UTILITY COORDINATION SITE PLAN

SOUTH ZIEBACH CAMPGROUND

GRAHAM'S ISLAND STATE PARK

NORTH DAKOTA PARKS & RECREATION DEPARTMENT

ELECTRICAL UPGRADES

BISMARCK, NORTH DAKOTA

GENERAL NOTES:

1.

ALL UTILITY COORDINATION TO BE COMPLETED BEFORE START OF CONSTRUCTION. THE SEQUENCE OF CONSTRUCTION SHALL TAKE PLACE AS DESCRIBED IN ONE OF THE BELOW OPTIONS.

1.1.

THE REMOVAL OF EXISTING ELECTRICAL PEDESTALS, DIRECT BURY WIRE AND INSTALLATION OF NEW PEDESTALS, DIRECT BURY WIRE SHALL BE DONE PRIOR TO INSTALLATION OF NEW ELECTRICAL WATER PIPE AND HYDRANTS.

1.2.

CONSTRUCTION OF BOTH ELECTRICAL DEMOLITION/IMPROVEMENT AND WATER IMPROVEMENT SHALL TAKE PLACE AT THE SAME TIME.

2.

E/C TO FIELD COORDINATE ALL WORK WITH OTHER TRADES.

KEY PLAN:

ZIEBACH LOOP AREA OF WORK

REGISTERED PROFESSIONAL ENGINEER

MICHAEL VAN DUYN

PE-10724

DATE: 04/24/2023

NORTH DAKOTA

DESIGNED BY:

ARH

DRAWN BY:

ARH/SDM

APPROVED BY:

MSV

DESIGN PROJ:

21219.000

CONST PROJ:

SCALE:

AS NOTED

DATE:

04-24-2023

DRAWING NO:


GI-UC-106

SHEET NO:

8 of 32

Last edit on: 4/21/2023 12:32 PM by: SDW01521 Drawing Name: F:\Proj\21000\21219\21219.000\AutoCad\Plan Set\Graham's Island\21219.000E - Electrical Demolition Site Plans - GISP.dwg Layout Name: NORTH HOWARD - DEMO SITE PLAN - GISP Plotted By: SDW01521 Plotted on: 4/24/2023 2:21:38 PM

BAR IS ONE INCH ON OFFICIAL DRAWINGS. 0 1" IF NOT ONE INCH, ADJUST SCALE ACCORDINGLY.

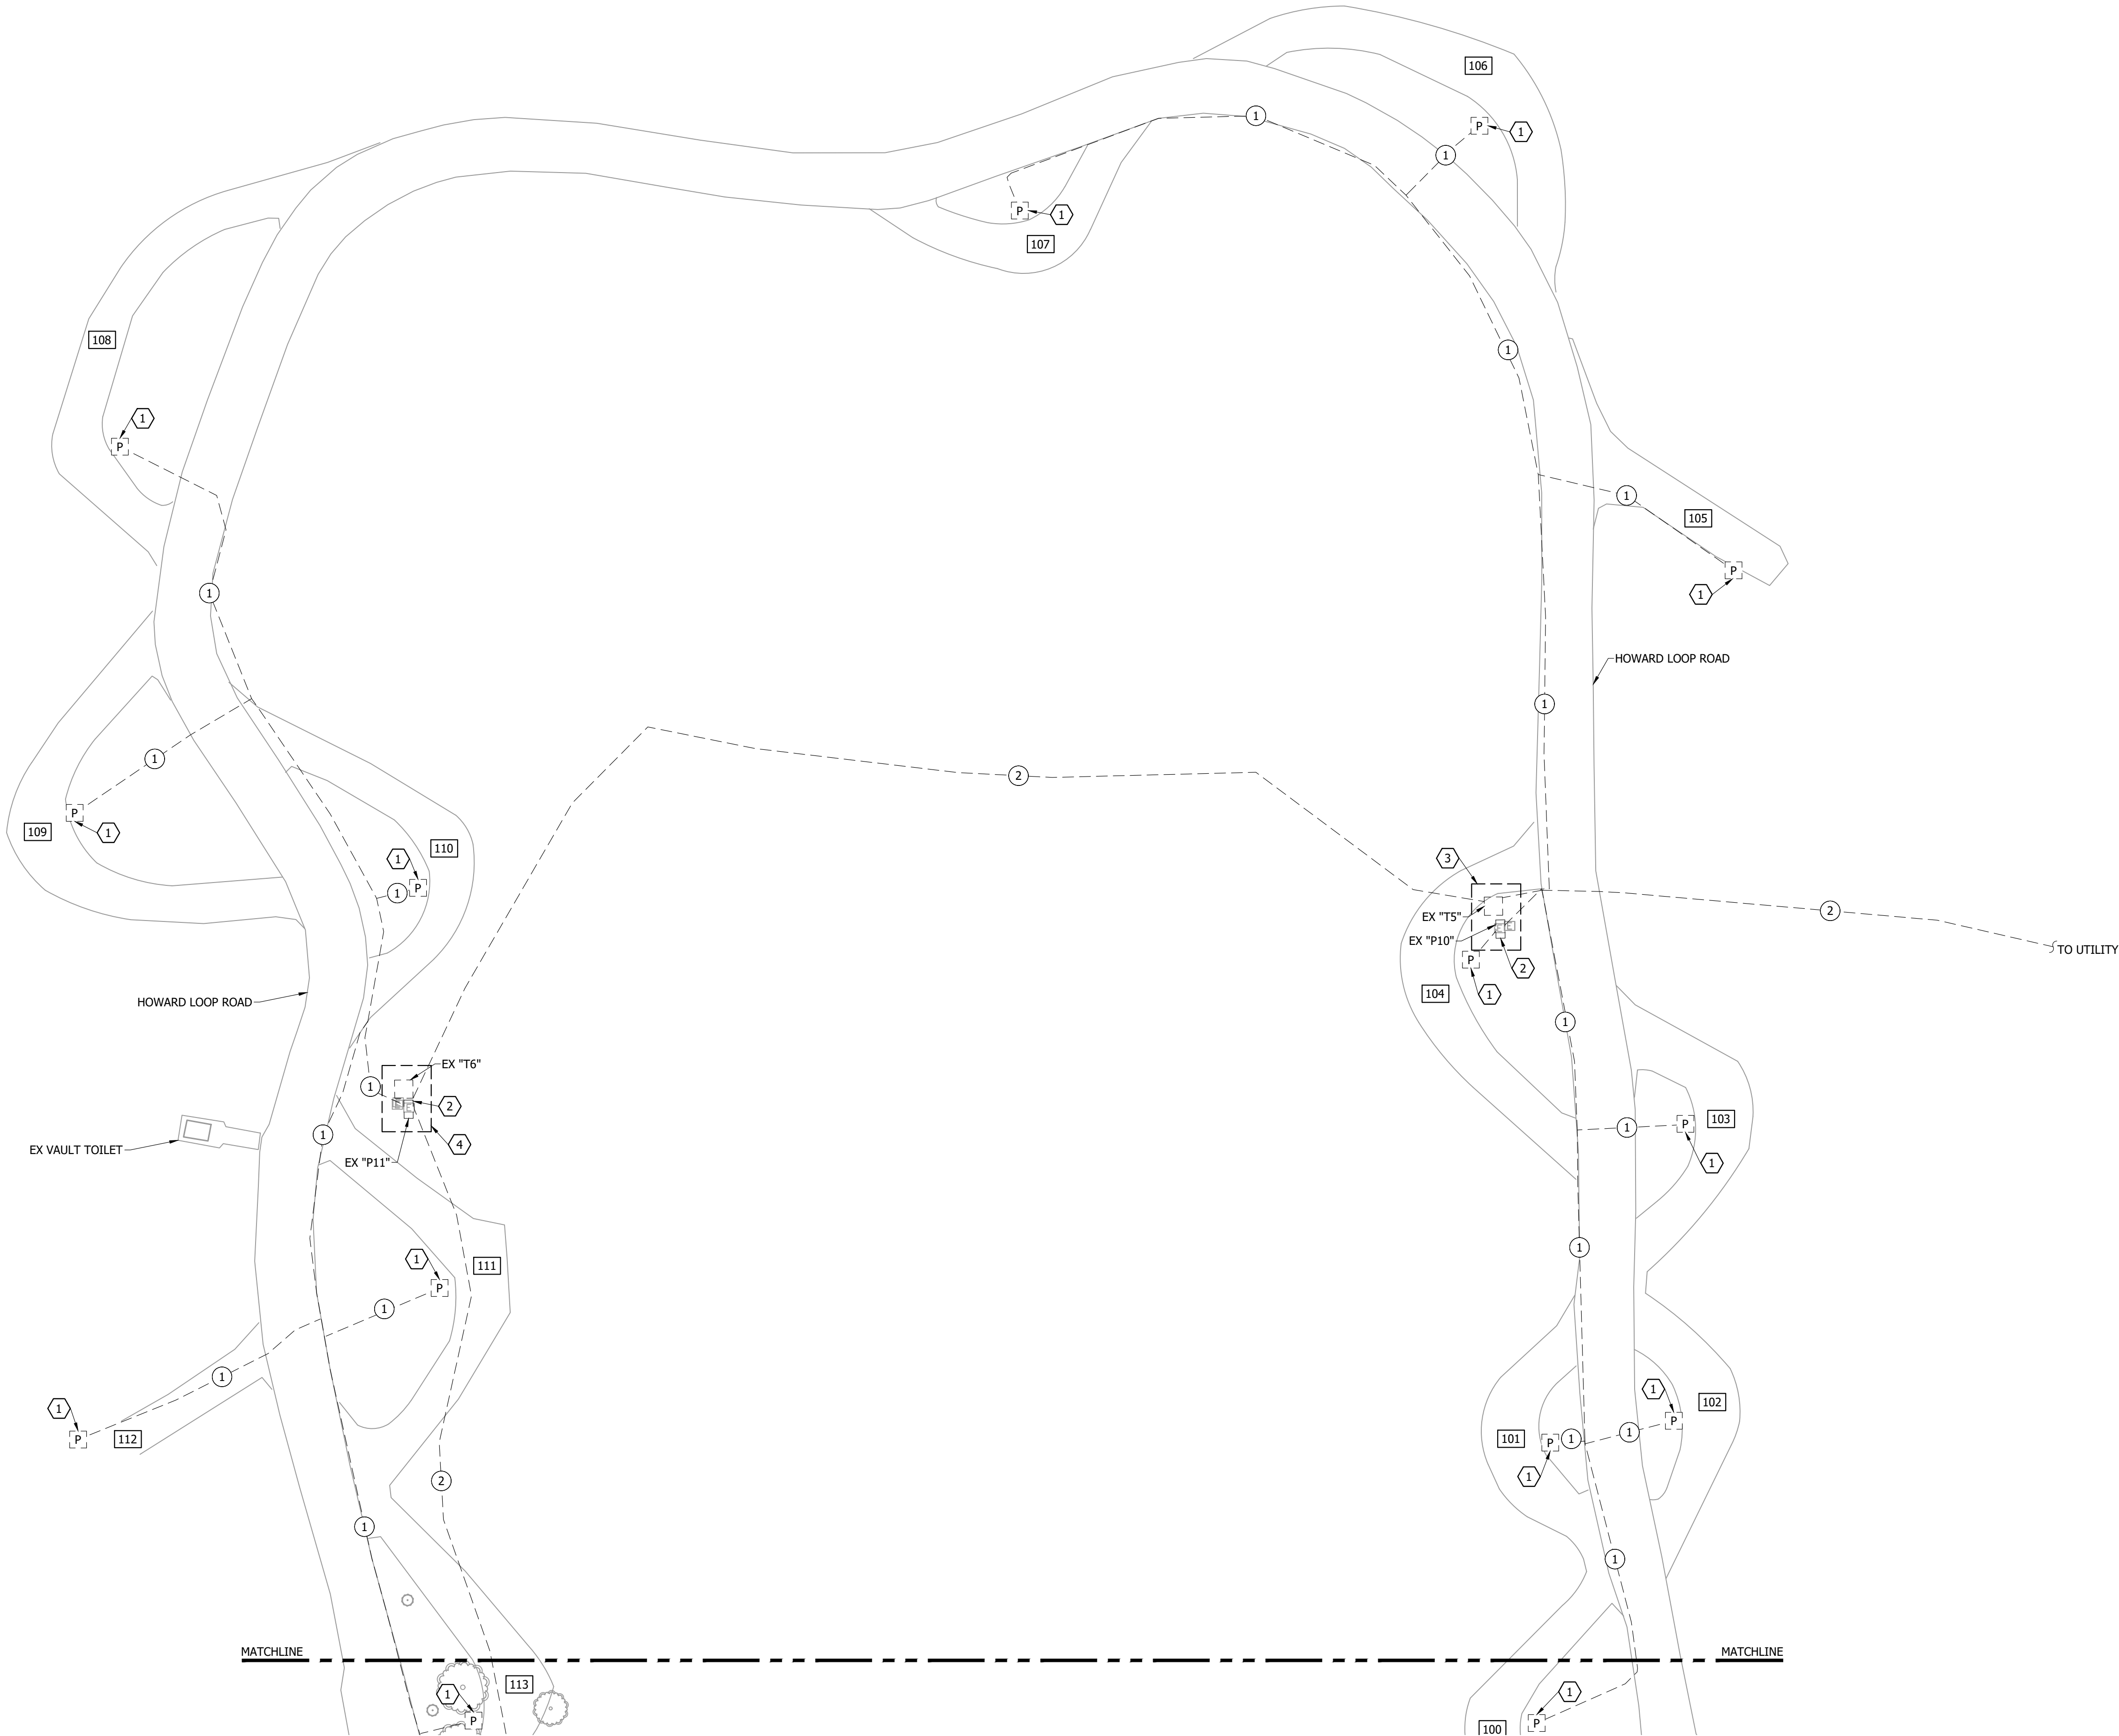

REFERENCE NOTES:

- EX RV POWER PEDESTAL, POWER CONNECTION AND ALL ASSOCIATED ABOVE GRADE WIRE AND CONDUIT TO BE REMOVED. EX BELOW GRADE DIRECT BURY WIRE TO BE CUT BACK AND REMOVED TO 1'-0" BELOW GRADE. EX BELOW GRADE DIRECT BURY WIRE BELOW 1'-0" TO BE DISCONNECTED, LABELED "ABANDONED", AND ABANDONED IN PLACE. REFER TO ELECTRICAL IMPROVEMENT SITE PLAN - HOWARD LOOP FOR NEW POWER PEDESTAL IMPROVEMENTS.
- EX PANELBOARD, POWER CONNECTION, UNISTRUT, AND ALL ASSOCIATED ABOVE GRADE WIRE AND CONDUIT TO BE REMOVED. EX BELOW GRADE DIRECT BURY WIRE TO BE CUT BACK AND REMOVED TO 1'-0" BELOW GRADE. EX BELOW GRADE DIRECT BURY WIRE BELOW 1'-0" TO BE DISCONNECTED, LABELED "ABANDONED", AND ABANDONED IN PLACE. REFER TO ELECTRICAL IMPROVEMENT SITE PLAN - HOWARD LOOP FOR NEW PANELBOARD IMPROVEMENTS.
- E/C TO REFER TO ELECTRICAL DETAILS 1/GI-E-502 AND 2/GI-E-603.
- E/C TO REFER TO ELECTRICAL DETAILS 2/GI-E-502 AND 2/GI-E-603.


GENERAL NOTES:

- THE EX CONDITIONS HAVE BEEN SHOWN BASED ON CASUAL ON-SITE INVESTIGATION WITH NO GUARANTEE TO THEIR ACCURACY, CONTRACTOR TO BE RESPONSIBLE TO FIELD VERIFY EX CONDITIONS.
- E/C TO FIELD COORDINATE ALL WORK WITH OTHER TRADES.
- E/C TO FIELD COORDINATE WITH NORTHERN PLAINS ELECTRIC CO-OP (NPEC) FOR ALL UTILITY COORDINATION.  
NPEC CONTACT: KEVIN LARSON  
PHONE: 701-303-0868  
EMAIL: scotti@mwec.com
- E/C TO BE RESPONSIBLE FOR A NEW UTILITY ELECTRICAL CONNECTION COSTS.


FEEDER SCHEDULE:

- EX UNDERGROUND DIRECT BURY BRANCH FEEDER TO REMAIN AND BE ABANDONED IN PLACE.
- EX UNDERGROUND DIRECT BURY MAIN FEEDER TO REMAIN AND BE ABANDONED IN PLACE.

KEY PLAN:

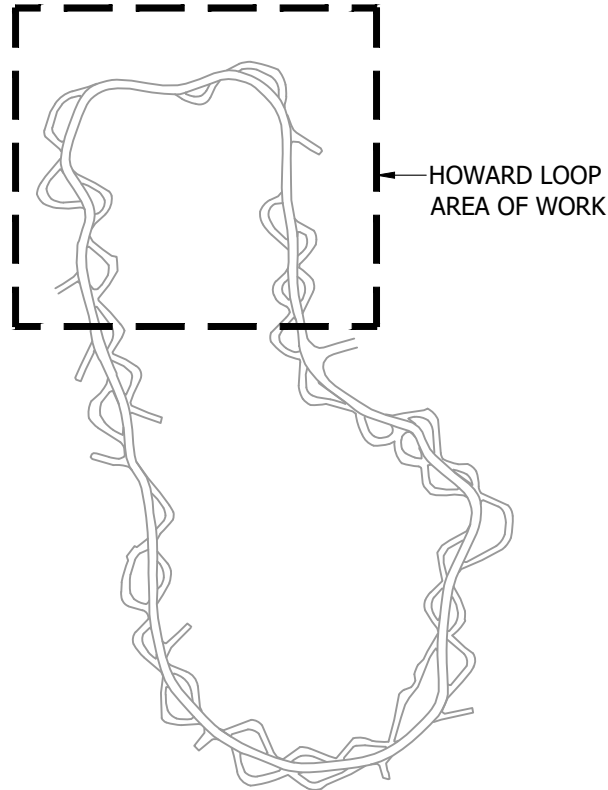


ELECTRICAL DEMOLITION SITE PLAN  
NORTH HOWARD CAMPGROUND  
GRAHAM'S ISLAND STATE PARK  
NORTH DAKOTA PARKS & RECREATION DEPARTMENT  
ELECTRICAL UPGRADES  
BISMARCK, NORTH DAKOTA

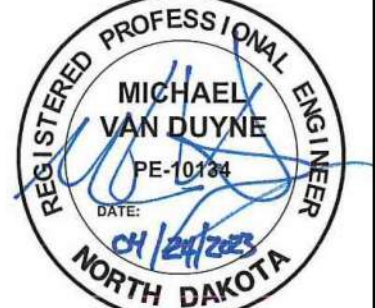


DESIGNED BY:	ARH
DRAWN BY:	SDM
APPROVED BY:	MSV
DESIGN PROJ:	21219.000
CONST PROJ:	
SCALE:	AS NOTED
DATE:	04-24-2023
DRAWING NO:	GI-E-101
SHEET NO:	9 of 32

Last edit on: 4/21/2023 12:32 PM by: SDM01521 Drawing Name: F:\Proj\21000\21219\21219.000\AutoCad\Plan Set\Graham's Island\21219.000E - Electrical Demolition Site Plans - GISP.dwg Layout Name: WEST HOWARD - DEMO SITE PLAN - GISP Plotted By: SDM01521 Plotted on: 4/24/2023 2:21:22 PM

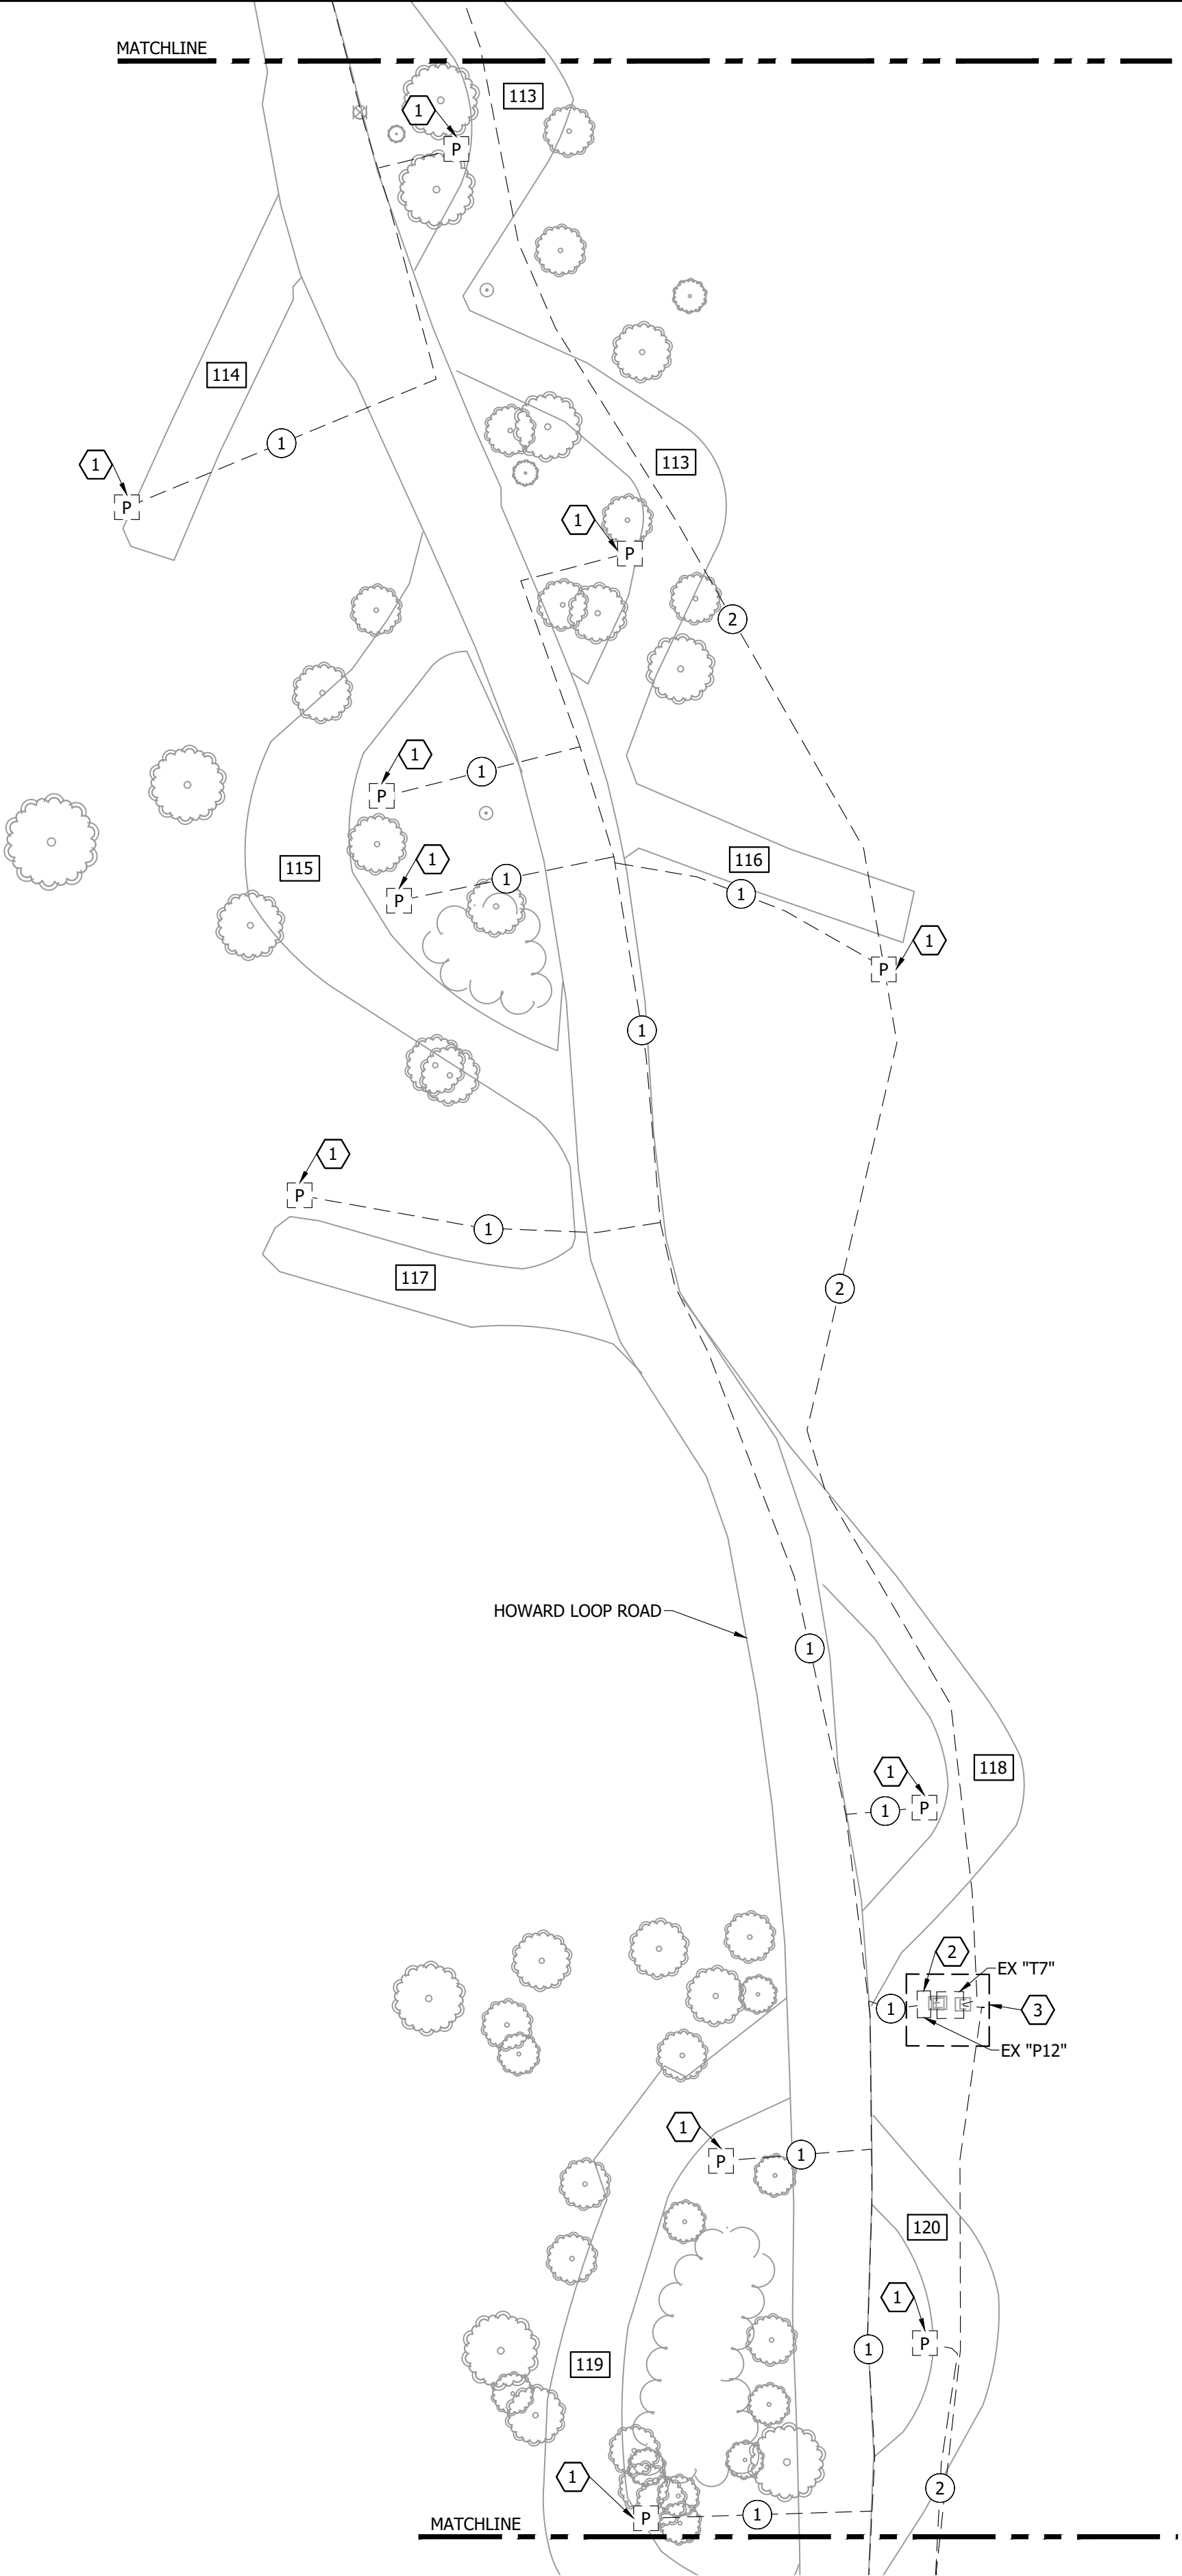

 **ELECTRICAL DEMOLITION SITE PLAN - WEST HOWARD CAMPGROUND**  
SCALE: 1"=30'

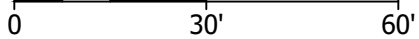

REFERENCE NOTES:

- ① EX RV POWER PEDESTAL, POWER CONNECTION AND ALL ASSOCIATED ABOVE GRADE WIRE AND CONDUIT TO BE REMOVED. EX BELOW GRADE DIRECT BURY WIRE TO BE CUT BACK AND REMOVED TO 1'-0" BELOW GRADE. EX BELOW GRADE DIRECT BURY WIRE BELOW 1'-0" TO BE DISCONNECTED, LABELED "ABANDONED", AND ABANDONED IN PLACE. REFER TO ELECTRICAL IMPROVEMENT SITE PLAN - HOWARD LOOP FOR NEW POWER PEDESTAL IMPROVEMENTS.
- ② EX PANELBOARD, POWER CONNECTION, UNISTRUT, AND ALL ASSOCIATED ABOVE GRADE WIRE AND CONDUIT TO BE REMOVED. EX BELOW GRADE DIRECT BURY WIRE TO BE CUT BACK AND REMOVED TO 1'-0" BELOW GRADE. EX BELOW GRADE DIRECT BURY WIRE BELOW 1'-0" TO BE DISCONNECTED, LABELED "ABANDONED", AND ABANDONED IN PLACE. REFER TO ELECTRICAL IMPROVEMENT SITE PLAN - HOWARD LOOP FOR NEW PANELBOARD IMPROVEMENTS.
- ③ E/C TO REFER TO ELECTRICAL DETAILS 3/GI-E-502 AND 2/GI-E-603.

**Bartlett & West**

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PHONE 701-258-1110 - FAX 701-258-1111  
WWW.BARTLETTWEST.COM


GENERAL NOTES:

1. THE EX CONDITIONS HAVE BEEN SHOWN BASED ON CASUAL ON-SITE INVESTIGATION WITH NO GUARANTEE TO THEIR ACCURACY, CONTRACTOR TO BE RESPONSIBLE TO FIELD VERIFY EX CONDITIONS.
2. E/C TO FIELD COORDINATE ALL WORK WITH OTHER TRADES.
3. E/C TO FIELD COORDINATE WITH NORTHERN PLAINS ELECTRIC CO-OP (NPEC) FOR ALL UTILITY COORDINATION.  
NPEC CONTACT: KEVIN LARSON  
PHONE: 701-303-0868  
EMAIL: scotti@mwec.com
4. E/C TO BE RESPONSIBLE FOR A NEW UTILITY ELECTRICAL CONNECTION COSTS.


FEEDER SCHEDULE:

- ① EX UNDERGROUND DIRECT BURY BRANCH FEEDER TO REMAIN AND BE ABANDONED IN PLACE.
- ② EX UNDERGROUND DIRECT BURY UTILITY MAIN FEEDER TO REMAIN AND BE ABANDONED IN PLACE.

KEY PLAN:

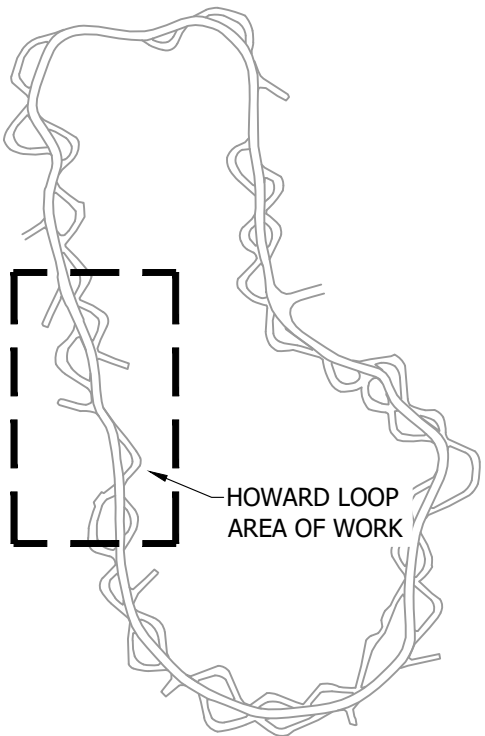


**ELECTRICAL DEMOLITION SITE PLAN**  
**WEST HOWARD CAMPGROUND**  
**GRAHAM'S ISLAND STATE PARK**  
**NORTH DAKOTA PARKS & RECREATION DEPARTMENT**  
**ELECTRICAL UPGRADES**  
**BISMARCK, NORTH DAKOTA**

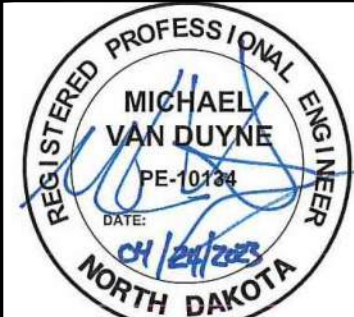


DESIGNED BY:	ARH
DRAWN BY:	SDM
APPROVED BY:	MSV
DESIGN PROJ:	21219.000
CONST PROJ:	
SCALE:	AS NOTED
DATE:	04-24-2023
DRAWING NO:	<b>GI-E-102</b>
SHEET NO:	10 of 32

Last edit on: 4/21/2023 12:32 PM by: SDM01521 Drawing Name: F:\Proj\21000\21219\21219.000\AutoCad\Plan Set\Graham's Island\21219.000E - Electrical Demolition Site Plans - GISP.dwg Layout Name: EAST HOWARD - DEMO SITE PLAN - GISP Plotted By: SDM01521 Plotted on: 4/24/2023 2:21:42 PM

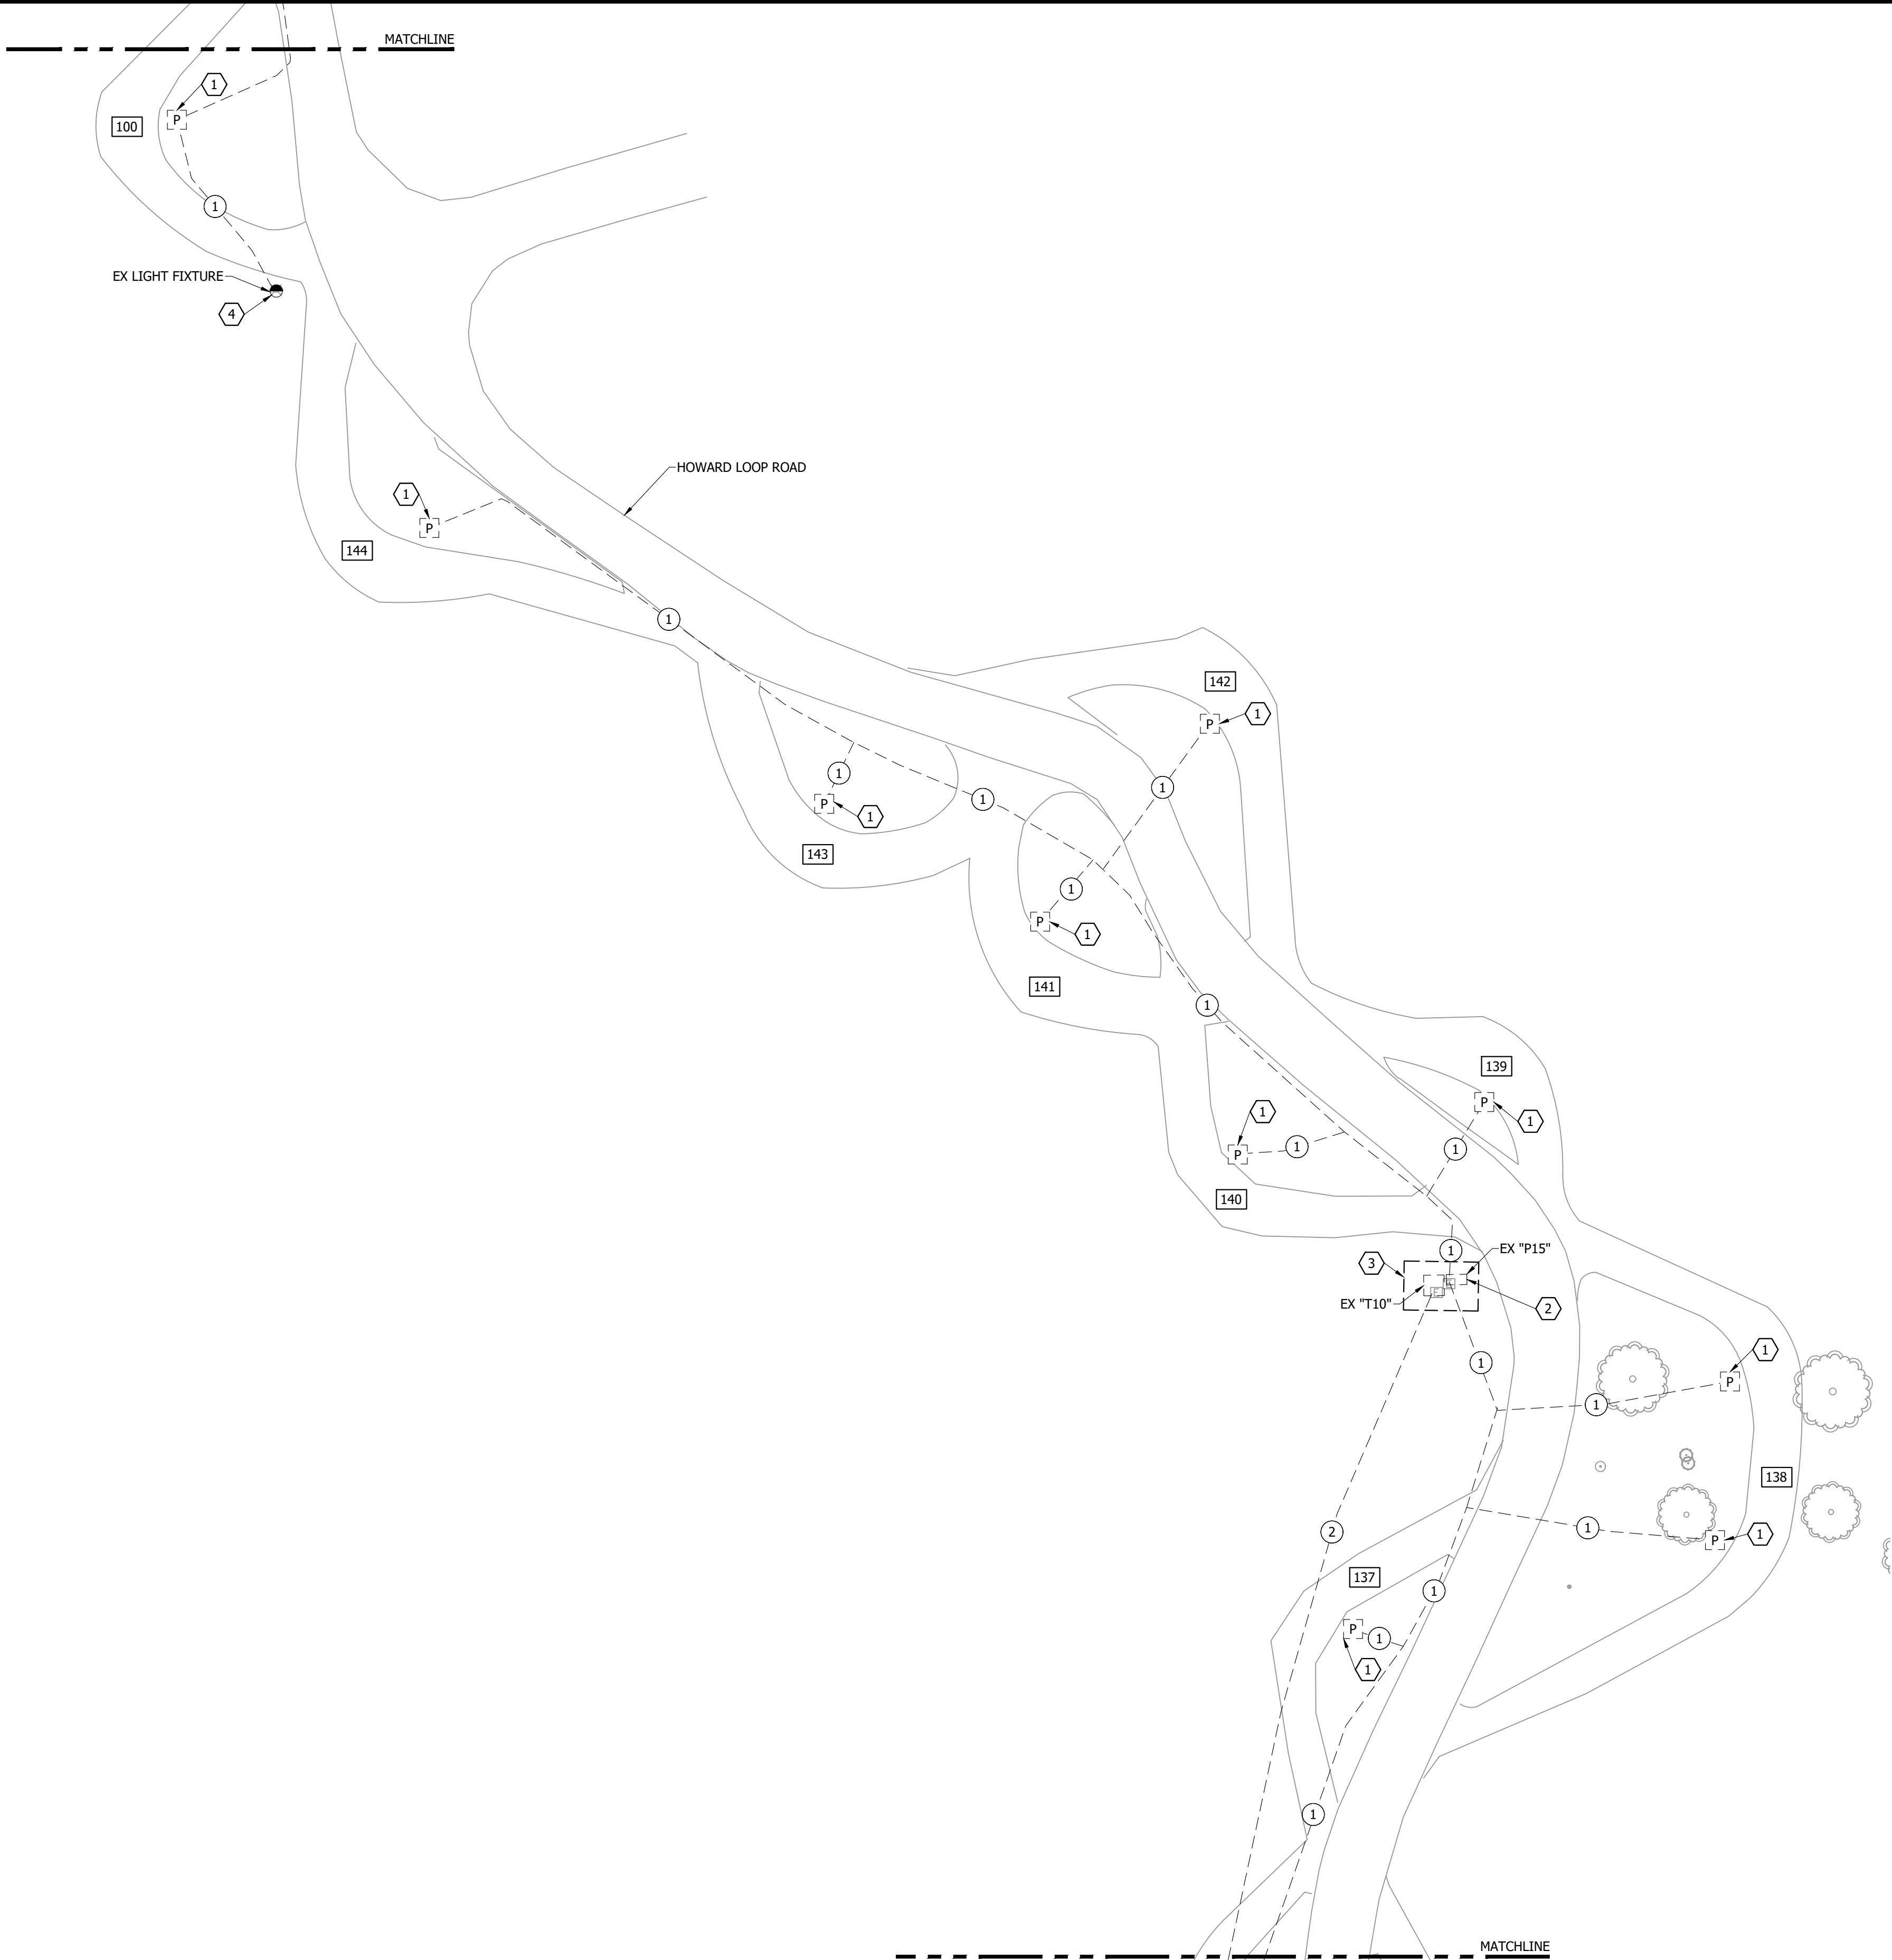

 **ELECTRICAL DEMOLITION SITE PLAN - EAST HOWARD CAMPGROUND**  
SCALE: 1"=30'

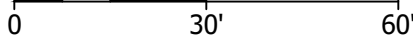

**REFERENCE NOTES:**

- EX RV POWER PEDESTAL, POWER CONNECTION AND ALL ASSOCIATED ABOVE GRADE WIRE AND CONDUIT TO BE REMOVED. EX BELOW GRADE DIRECT BURY WIRE TO BE CUT BACK AND REMOVED TO 1'-0" BELOW GRADE. EX BELOW GRADE DIRECT BURY WIRE BELOW 1'-0" TO BE DISCONNECTED, LABELED "ABANDONED", AND ABANDONED IN PLACE. REFER TO ELECTRICAL IMPROVEMENT SITE PLAN - HOWARD LOOP FOR NEW POWER PEDESTAL IMPROVEMENTS.
- EX PANELBOARD, POWER CONNECTION, UNISTRUT, AND ALL ASSOCIATED ABOVE GRADE WIRE AND CONDUIT TO BE REMOVED. EX BELOW GRADE DIRECT BURY WIRE TO BE CUT BACK AND REMOVED TO 1'-0" BELOW GRADE. EX BELOW GRADE DIRECT BURY WIRE BELOW 1'-0" TO BE DISCONNECTED, LABELED "ABANDONED", AND ABANDONED IN PLACE. REFER TO ELECTRICAL IMPROVEMENT SITE PLAN - HOWARD LOOP FOR NEW PANELBOARD IMPROVEMENTS.
- E/C TO REFER TO ELECTRICAL DETAILS 6/GI-E-502 AND 2/GI-E-603.
- EX POLE MOUNTED LIGHTING FIXTURE AND ASSOCIATED LIGHTING POLE TO REMAIN AND BE RECONNECTED. EX POWER CONNECTION AND ALL ASSOCIATED ABOVE GRADE WIRE AND CONDUIT TO BE REMOVED. EX BELOW GRADE DIRECT BURY WIRE TO BE CUT BACK AND REMOVED TO 1'-0" BELOW GRADE. EX BELOW GRADE DIRECT BURY WIRE BELOW 1'-0" TO BE DISCONNECTED, LABELED "ABANDONED", AND ABANDONED IN PLACE. REFER TO ELECTRICAL IMPROVEMENT SITE PLAN - HOWARD LOOP FOR LIGHTING FIXTURE POWER CONNECTION.


**GENERAL NOTES:**

- THE EX CONDITIONS HAVE BEEN SHOWN BASED ON CASUAL ON-SITE INVESTIGATION WITH NO GUARANTEE TO THEIR ACCURACY. CONTRACTOR TO BE RESPONSIBLE TO FIELD VERIFY EX CONDITIONS.
- E/C TO FIELD COORDINATE ALL WORK WITH OTHER TRADES.
- E/C TO FIELD COORDINATE WITH NORTHERN PLAINS ELECTRIC CO-OP (NPEC) FOR ALL UTILITY COORDINATION.  
NPEC CONTACT: KEVIN LARSON  
PHONE: 701-303-0868  
EMAIL: scotti@mwec.com
- E/C TO BE RESPONSIBLE FOR A NEW UTILITY ELECTRICAL CONNECTION COSTS.


**FEEDER SCHEDULE:**

- EX UNDERGROUND DIRECT BURY BRANCH FEEDER TO REMAIN AND BE ABANDONED IN PLACE.
- EX UNDERGROUND DIRECT BURY UTILITY MAIN FEEDER TO REMAIN AND BE ABANDONED IN PLACE.

**KEY PLAN:**

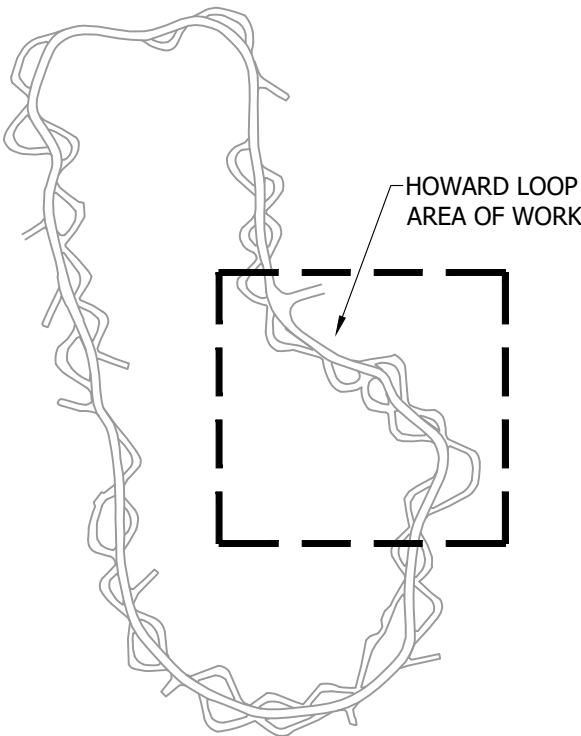


**ELECTRICAL DEMOLITION SITE PLAN  
EAST HOWARD CAMPGROUND  
GRAHAMS ISLAND STATE PARK  
NORTH DAKOTA PARKS & RECREATION DEPARTMENT  
ELECTRICAL UPGRADES  
BISMARCK, NORTH DAKOTA**

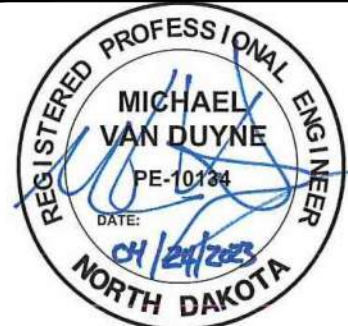

DESIGNED BY:	ARH
DRAWN BY:	SDM
APPROVED BY:	MSV
DESIGN PROJ:	21219.000
CONST PROJ:	
SCALE:	AS NOTED
DATE:	04-24-2023
DRAWING NO:	<b>GI-E-103</b>
SHEET NO:	

Last edit on: 4/21/2023 12:32 PM by: SDW01521 Drawing Name: F:\Proj\21000\21219\21219.000\AutoCad\Plan Set\Graham's Island\21219.000E - Electrical Demolition Site Plans - GISP.dwg Layout Name: SOUTH HOWARD - DEMO SITE PLAN - GISP Plotted by: SDW01521 Plotted on: 4/24/2023 2:21:03 PM

BAR IS ONE INCH ON OFFICIAL DRAWINGS. 0 1" IF NOT ONE INCH, ADJUST SCALE ACCORDINGLY.

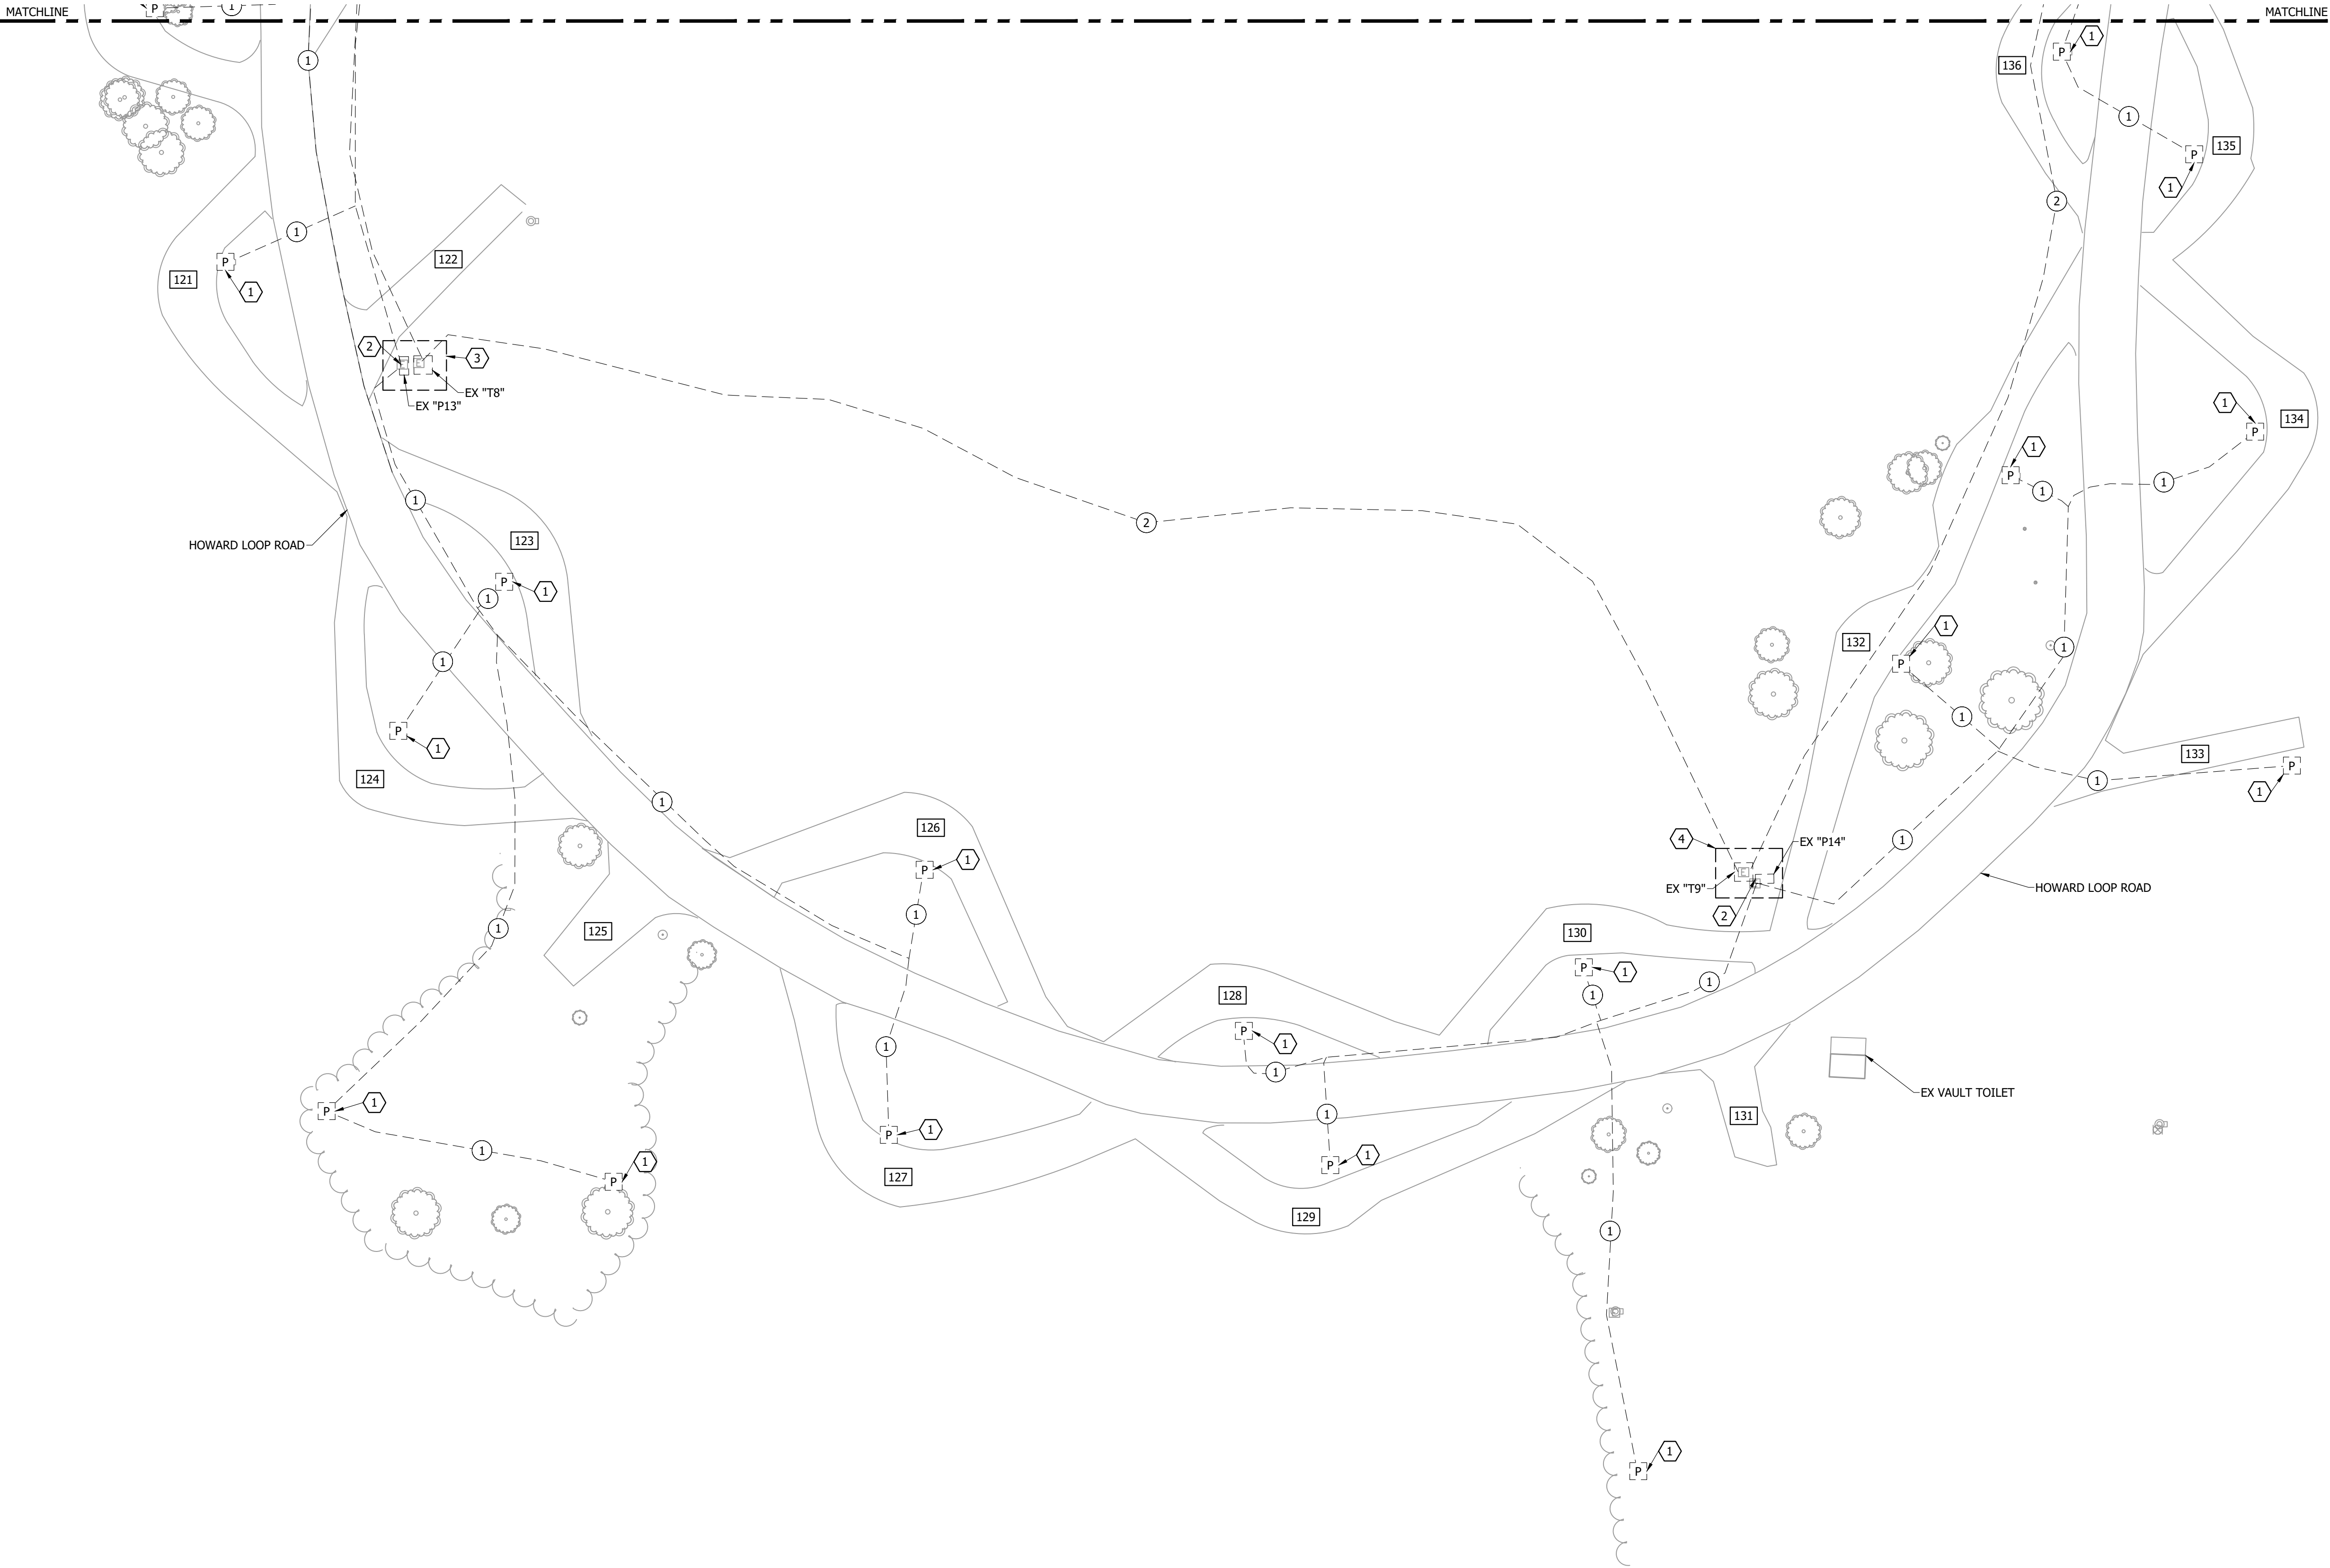

REFERENCE NOTES:

- 1 EX RV POWER PEDESTAL, POWER CONNECTION AND ALL ASSOCIATED ABOVE GRADE WIRE AND CONDUIT TO BE REMOVED. EX BELOW GRADE DIRECT BURY WIRE TO BE CUT BACK AND REMOVED TO 1'-0" BELOW GRADE. EX BELOW GRADE DIRECT BURY WIRE BELOW 1'-0" TO BE DISCONNECTED, LABELED "ABANDONED", AND ABANDONED IN PLACE. REFER TO ELECTRICAL IMPROVEMENT SITE PLAN - HOWARD LOOP FOR NEW POWER PEDESTAL IMPROVEMENTS.
- 2 EX PANELBOARD, POWER CONNECTION, UNISTRUT, AND ALL ASSOCIATED ABOVE GRADE WIRE AND CONDUIT TO BE REMOVED. EX BELOW GRADE DIRECT BURY WIRE TO BE CUT BACK AND REMOVED TO 1'-0" BELOW GRADE. EX BELOW GRADE DIRECT BURY WIRE BELOW 1'-0" TO BE DISCONNECTED, LABELED "ABANDONED", AND ABANDONED IN PLACE. REFER TO ELECTRICAL IMPROVEMENT SITE PLAN - HOWARD LOOP FOR NEW PANELBOARD IMPROVEMENTS.
- 3 E/C TO REFER TO ELECTRICAL DETAILS 4/GI-E-502 AND 2/GI-E-603.
- 4 E/C TO REFER TO ELECTRICAL DETAILS 5/GI-E-502 AND 2/GI-E-603.



GENERAL NOTES:

- 1. THE EX CONDITIONS HAVE BEEN SHOWN BASED ON CASUAL ON-SITE INVESTIGATION WITH NO GUARANTEE TO THEIR ACCURACY, CONTRACTOR TO BE RESPONSIBLE TO FIELD VERIFY EX CONDITIONS.
- 2. E/C TO FIELD COORDINATE ALL WORK WITH OTHER TRADES.
- 3. E/C TO FIELD COORDINATE WITH NORTHERN PLAINS ELECTRIC CO-OP (NPEC) FOR ALL UTILITY COORDINATION.  
NPEC CONTACT: KEVIN LARSON  
PHONE: 701-303-0868  
EMAIL: scotti@mwec.com
- 4. E/C TO BE RESPONSIBLE FOR A NEW UTILITY ELECTRICAL CONNECTION COSTS.

FEEDER SCHEDULE:


- 1 EX UNDERGROUND DIRECT BURY BRANCH FEEDER TO REMAIN AND BE ABANDONED IN PLACE.
- 2 EX UNDERGROUND DIRECT BURY UTILITY MAIN FEEDER TO REMAIN AND BE ABANDONED IN PLACE.

KEY PLAN:

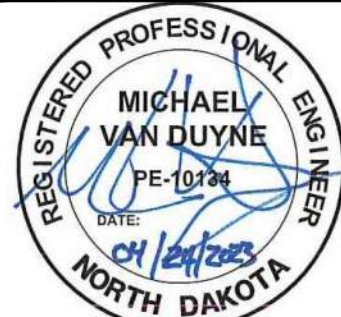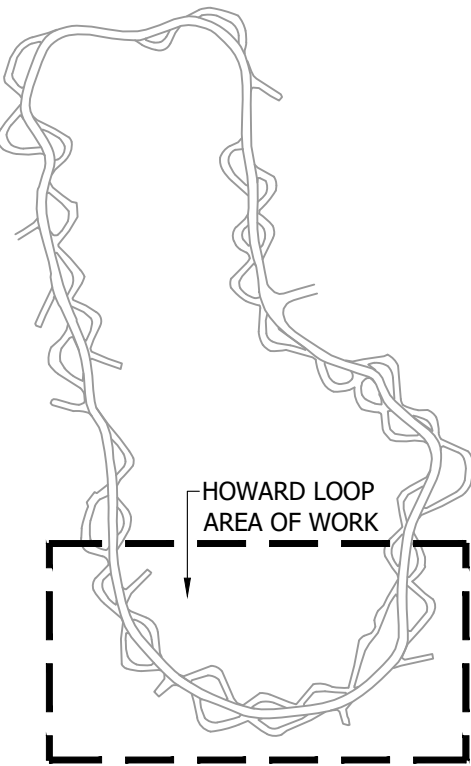

DESIGNED BY:	ARH
DRAWN BY:	SDM
APPROVED BY:	MSV
DESIGN PROJ:	21219.000
CONST PROJ:	
SCALE:	AS NOTED
DATE:	04-24-2023
DRAWING NO:	<b>GI-E-104</b>
SHEET NO:	12 of 32

Last edit on: 4/21/2023 12:32 PM by: SDW01521 Drawing Name: F:\Proj\21000\21219\01219.000\AutoCad\Plan Set\Graham's Island\21219.000E - Electrical Demolition Site Plans - GISP.dwg Layout Name: NORTH ZIEBACH - DEMO SITE PLAN - GISP Plotted by: SDW01521 Plotted on: 4/24/2023 2:21:30 PM

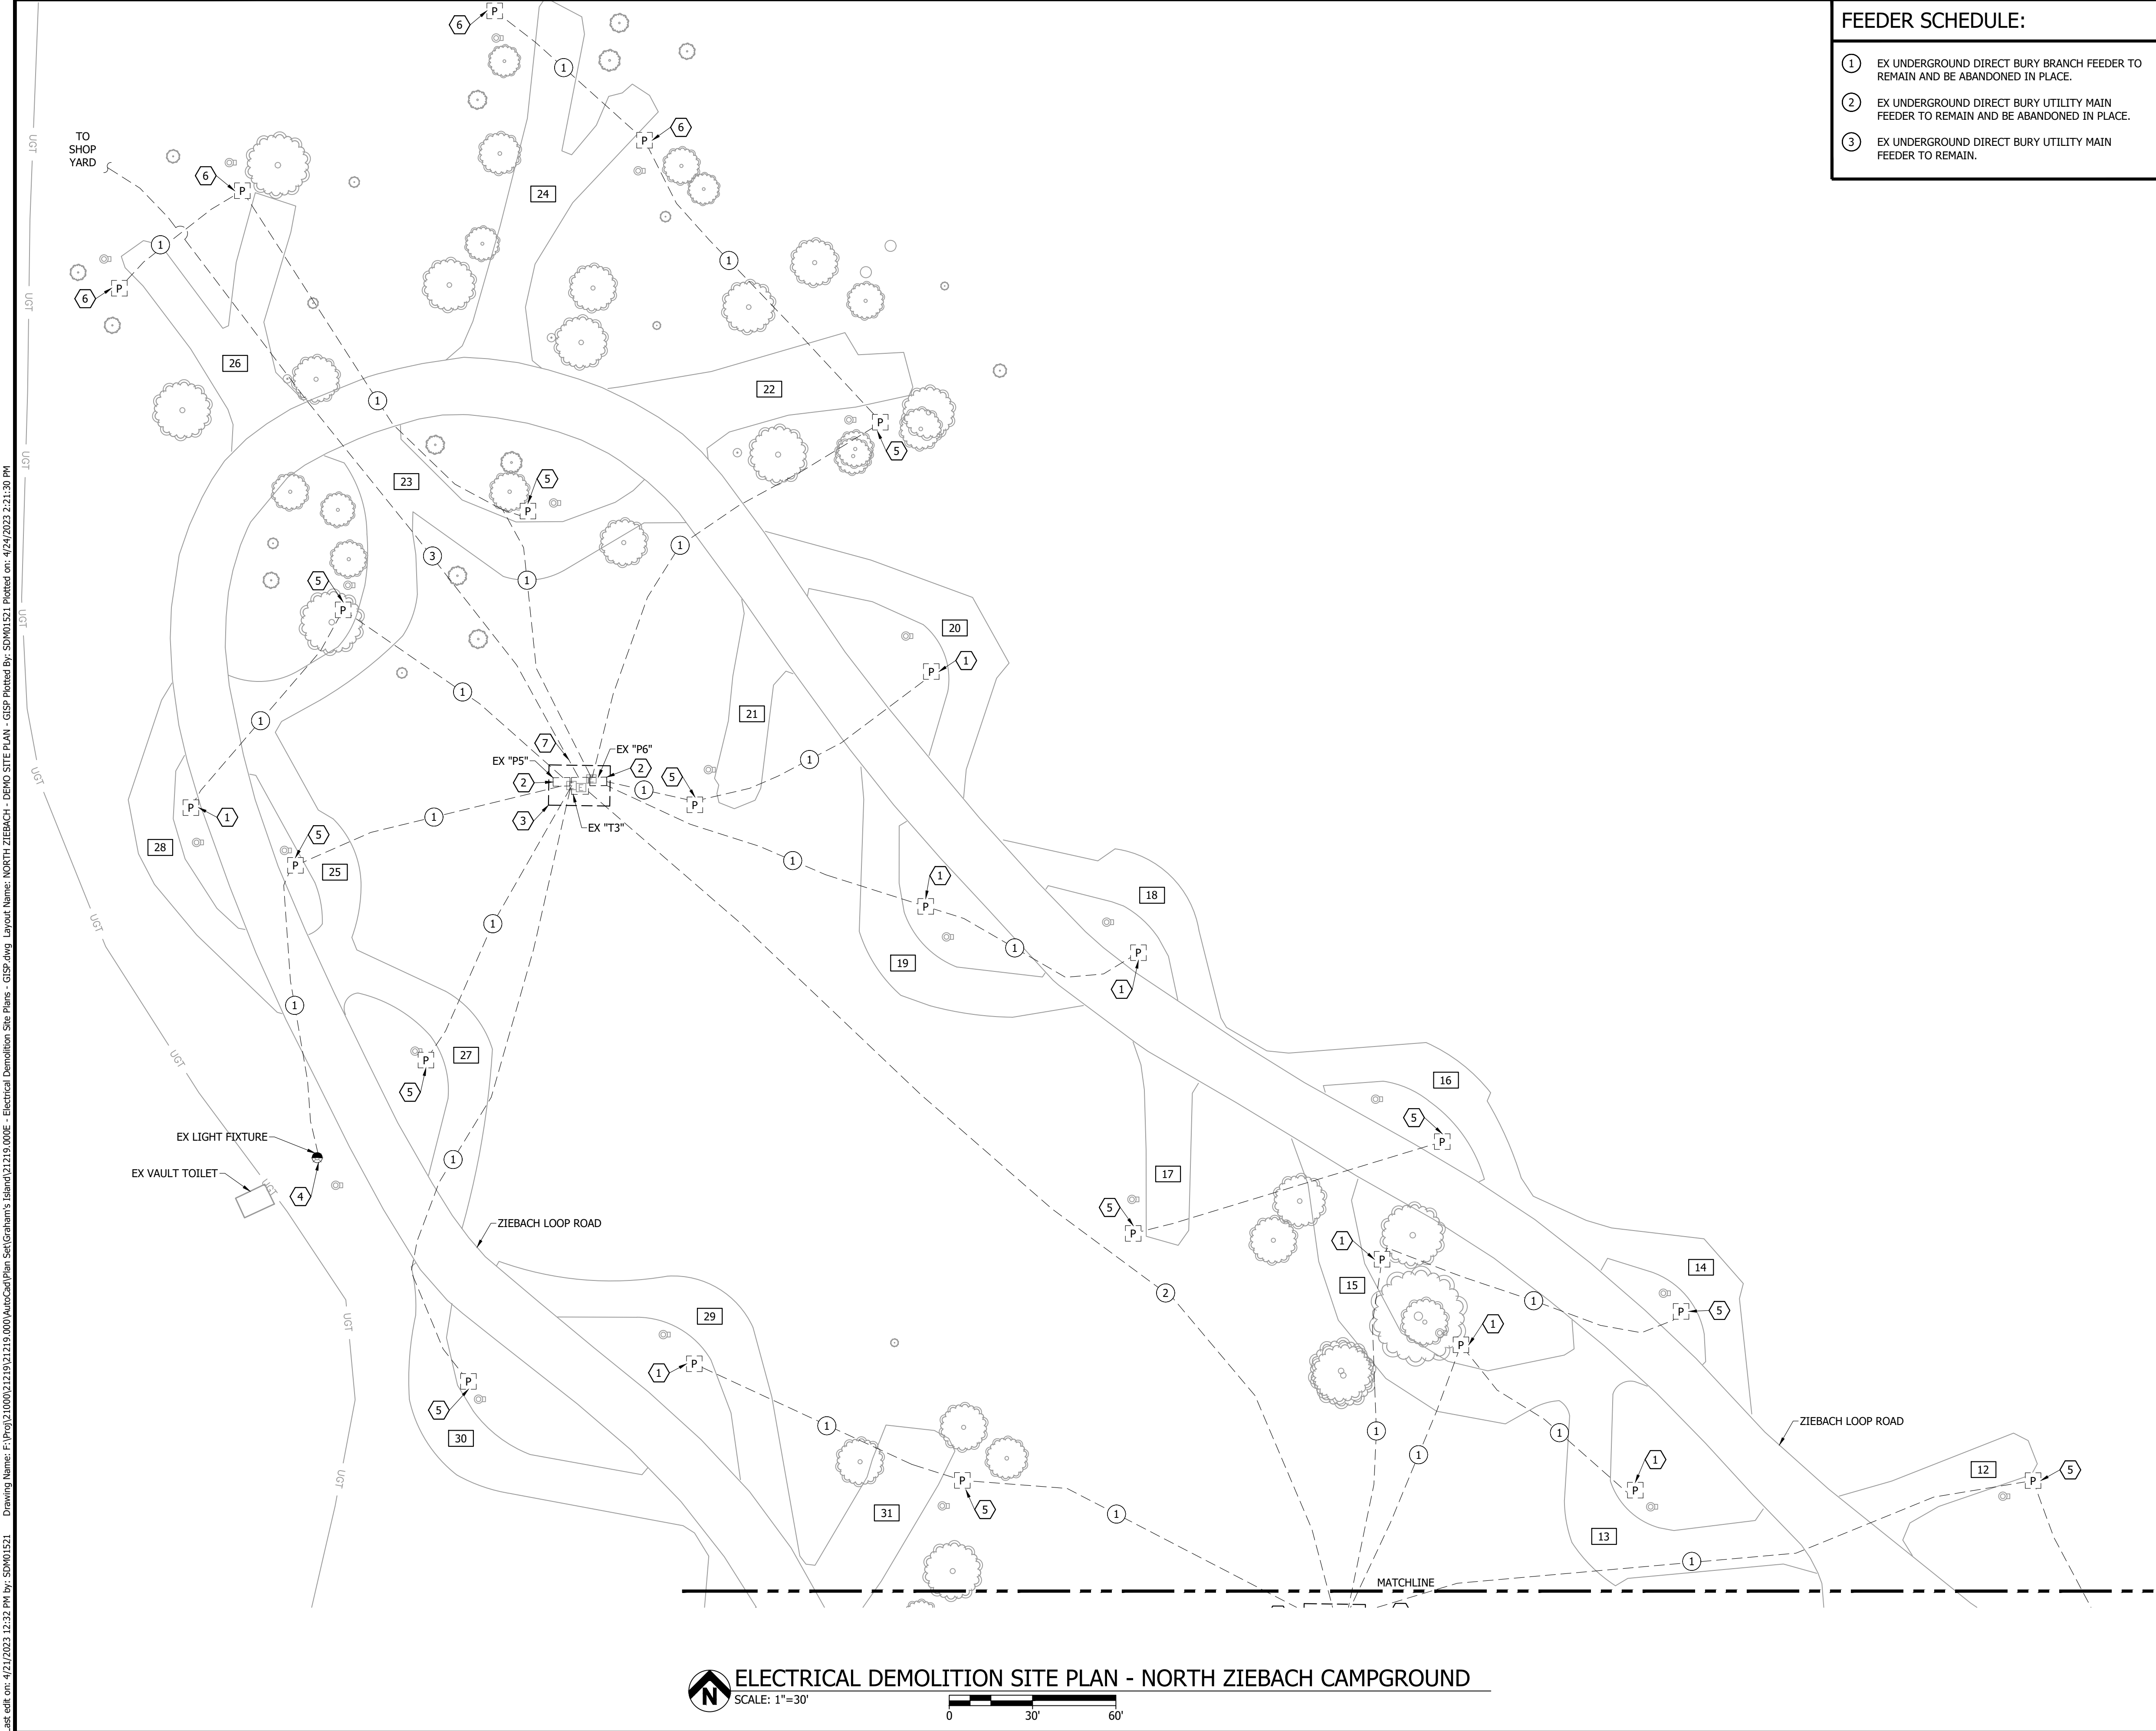

 **ELECTRICAL DEMOLITION SITE PLAN - NORTH ZIEBACH CAMPGROUND**  
SCALE: 1"=30'  
0 30' 60'

**FEEDER SCHEDULE:**

- ① EX UNDERGROUND DIRECT BURY BRANCH FEEDER TO REMAIN AND BE ABANDONED IN PLACE.
- ② EX UNDERGROUND DIRECT BURY UTILITY MAIN FEEDER TO REMAIN AND BE ABANDONED IN PLACE.
- ③ EX UNDERGROUND DIRECT BURY UTILITY MAIN FEEDER TO REMAIN.


**REFERENCE NOTES:**

- ① EX POWER PEDESTAL TO REMAIN. EX 50 AMP/2P CIRCUIT BREAKER AND RECEPTACLE, EX 30 AMP/1P CIRCUIT BREAKER AND RECEPTACLE TO REMAIN. EX 20 AMP/1P CIRCUIT BREAKER AND GFCI RECEPTACLE TO BE REMOVED. EX MAIN FEEDER POWER CONNECTION TO BE REMOVED. EX BELOW GRADE DIRECT BURY WIRE TO BE CUT BACK AND REMOVED TO 1'-0" BELOW GRADE. EX BELOW GRADE DIRECT BURY WIRE BELOW 1'-0" TO BE DISCONNECTED, LABELED "ABANDONED", AND ABANDONED IN PLACE. REFER TO ELECTRICAL IMPROVEMENT SITE PLAN - ZIEBACH LOOP FOR NEW POWER PEDESTAL IMPROVEMENTS.
- ② EX PANELBOARD, POWER CONNECTION, UNISTRUT, AND ALL ASSOCIATED ABOVE GRADE WIRE AND CONDUIT TO BE REMOVED. EX BELOW GRADE DIRECT BURY WIRE TO BE CUT BACK AND REMOVED TO 1'-0" BELOW GRADE. EX BELOW GRADE DIRECT BURY WIRE BELOW 1'-0" TO BE DISCONNECTED, LABELED "ABANDONED", AND ABANDONED IN PLACE. REFER TO ELECTRICAL IMPROVEMENT SITE PLAN - ZIEBACH LOOP FOR NEW PANELBOARD IMPROVEMENTS.
- ③ E/C TO REFER TO ELECTRICAL DETAILS 3/GI-E-503 AND 1/GI-E-603.
- ④ EX POLE MOUNTED LIGHTING FIXTURE AND ASSOCIATED LIGHTING POLE TO REMAIN AND BE RECONNECTED. EX POWER CONNECTION AND ALL ASSOCIATED ABOVE GRADE WIRE AND CONDUIT TO BE REMOVED. EX BELOW GRADE DIRECT BURY WIRE TO BE CUT BACK AND REMOVED TO 1'-0" BELOW GRADE. EX BELOW GRADE DIRECT BURY WIRE BELOW 1'-0" TO BE DISCONNECTED, LABELED "ABANDONED", AND ABANDONED IN PLACE. REFER TO ELECTRICAL IMPROVEMENT SITE PLAN - ZIEBACH LOOP FOR LIGHTING FIXTURE POWER CONNECTION.
- ⑤ EX POWER PEDESTAL TO BE REMOVED AND RELOCATED. EX 50 AMP/2P CIRCUIT BREAKER AND RECEPTACLE, EX 30 AMP/1P CIRCUIT BREAKER AND RECEPTACLE TO REMAIN. EX 20 AMP/1P CIRCUIT BREAKER AND GFCI RECEPTACLE TO BE REMOVED. EX MAIN FEEDER POWER CONNECTION TO BE REMOVED. EX BELOW GRADE DIRECT BURY WIRE TO BE CUT BACK AND REMOVED TO 1'-0" BELOW GRADE. EX BELOW GRADE DIRECT BURY WIRE BELOW 1'-0" TO BE DISCONNECTED, LABELED "ABANDONED", AND ABANDONED IN PLACE. REFER TO ELECTRICAL IMPROVEMENT SITE PLAN - ZIEBACH LOOP FOR NEW POWER PEDESTAL IMPROVEMENTS.
- ⑥ EX RV POWER PEDESTAL. POWER CONNECTION AND ALL ASSOCIATED ABOVE GRADE WIRE AND CONDUIT TO BE REMOVED. EX BELOW GRADE DIRECT BURY WIRE TO BE CUT BACK AND REMOVED TO 1'-0" BELOW GRADE. EX BELOW GRADE DIRECT BURY WIRE BELOW 1'-0" TO BE DISCONNECTED, LABELED "ABANDONED", AND ABANDONED IN PLACE. REFER TO ELECTRICAL IMPROVEMENT SITE PLAN - ZIEBACH LOOP FOR NEW POWER PEDESTAL IMPROVEMENTS.
- ⑦ UTILITY TO TEMPORARILY DISCONNECT MEDIUM VOLTAGE FEEDER TO EX SHOP YARD. REFER TO ELECTRICAL IMPROVEMENT SITE PLAN - ZIEBACH LOOP. FIELD COORDINATE WITH E/C. E/C TO REFER TO ELECTRICAL DETAILS 8/GI-E-503.


**GENERAL NOTES:**

- 1. THE EX CONDITIONS HAVE BEEN SHOWN BASED ON CASUAL ON-SITE INVESTIGATION WITH NO GUARANTEE TO THEIR ACCURACY. CONTRACTOR TO BE RESPONSIBLE TO FIELD VERIFY EX CONDITIONS.
- 2. E/C TO FIELD COORDINATE ALL WORK WITH OTHER TRADES.
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NPEC CONTACT: KEVIN LARSON  
PHONE: 701-303-0868  
EMAIL: scotti@mwec.com
- 4. E/C TO BE RESPONSIBLE FOR A NEW UTILITY ELECTRICAL CONNECTION COSTS.

**KEY PLAN:**

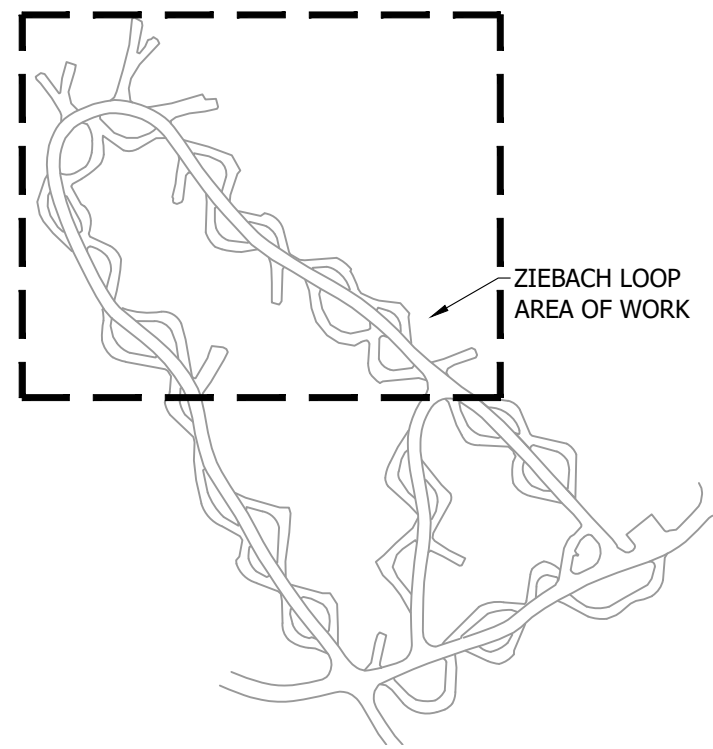

**ELECTRICAL DEMOLITION SITE PLAN  
NORTH ZIEBACH CAMPGROUND  
GRAHAM'S ISLAND STATE PARK  
NORTH DAKOTA PARKS & RECREATION DEPARTMENT  
ELECTRICAL UPGRADES  
BISMARCK, NORTH DAKOTA**

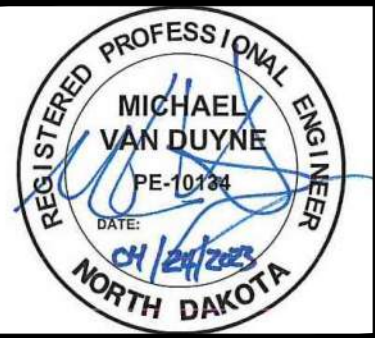


DESIGNED BY:	ARH
DRAWN BY:	SDM
APPROVED BY:	MSV
DESIGN PROJ:	21219.000
CONST PROJ:	
SCALE:	AS NOTED
DATE:	04-24-2023
DRAWING NO:	<b>GI-E-105</b>
SHEET NO:	13 of 32

**Bartlett & West**

3456 E CENTURY AVENUE - BISMARCK, ND 58503  
PHONE 701-258-1110 - FAX 701-258-1111  
WWW.BARTLETTWEST.COM

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Last edit on: 4/21/2023 12:32 PM by: SDW01521 Drawing Name: F:\Proj\21000\21219\21219\21219\000\AutoCad\Plan Set\Graham's Island\21219.000E - Electrical Demolition Site Plans - GISP.dwg Layout Name: SOUTH ZIEBACH - DEMO SITE PLAN - GISP Plotted By: SDW01521 Plotted on: 4/24/2023 2:21:26 PM

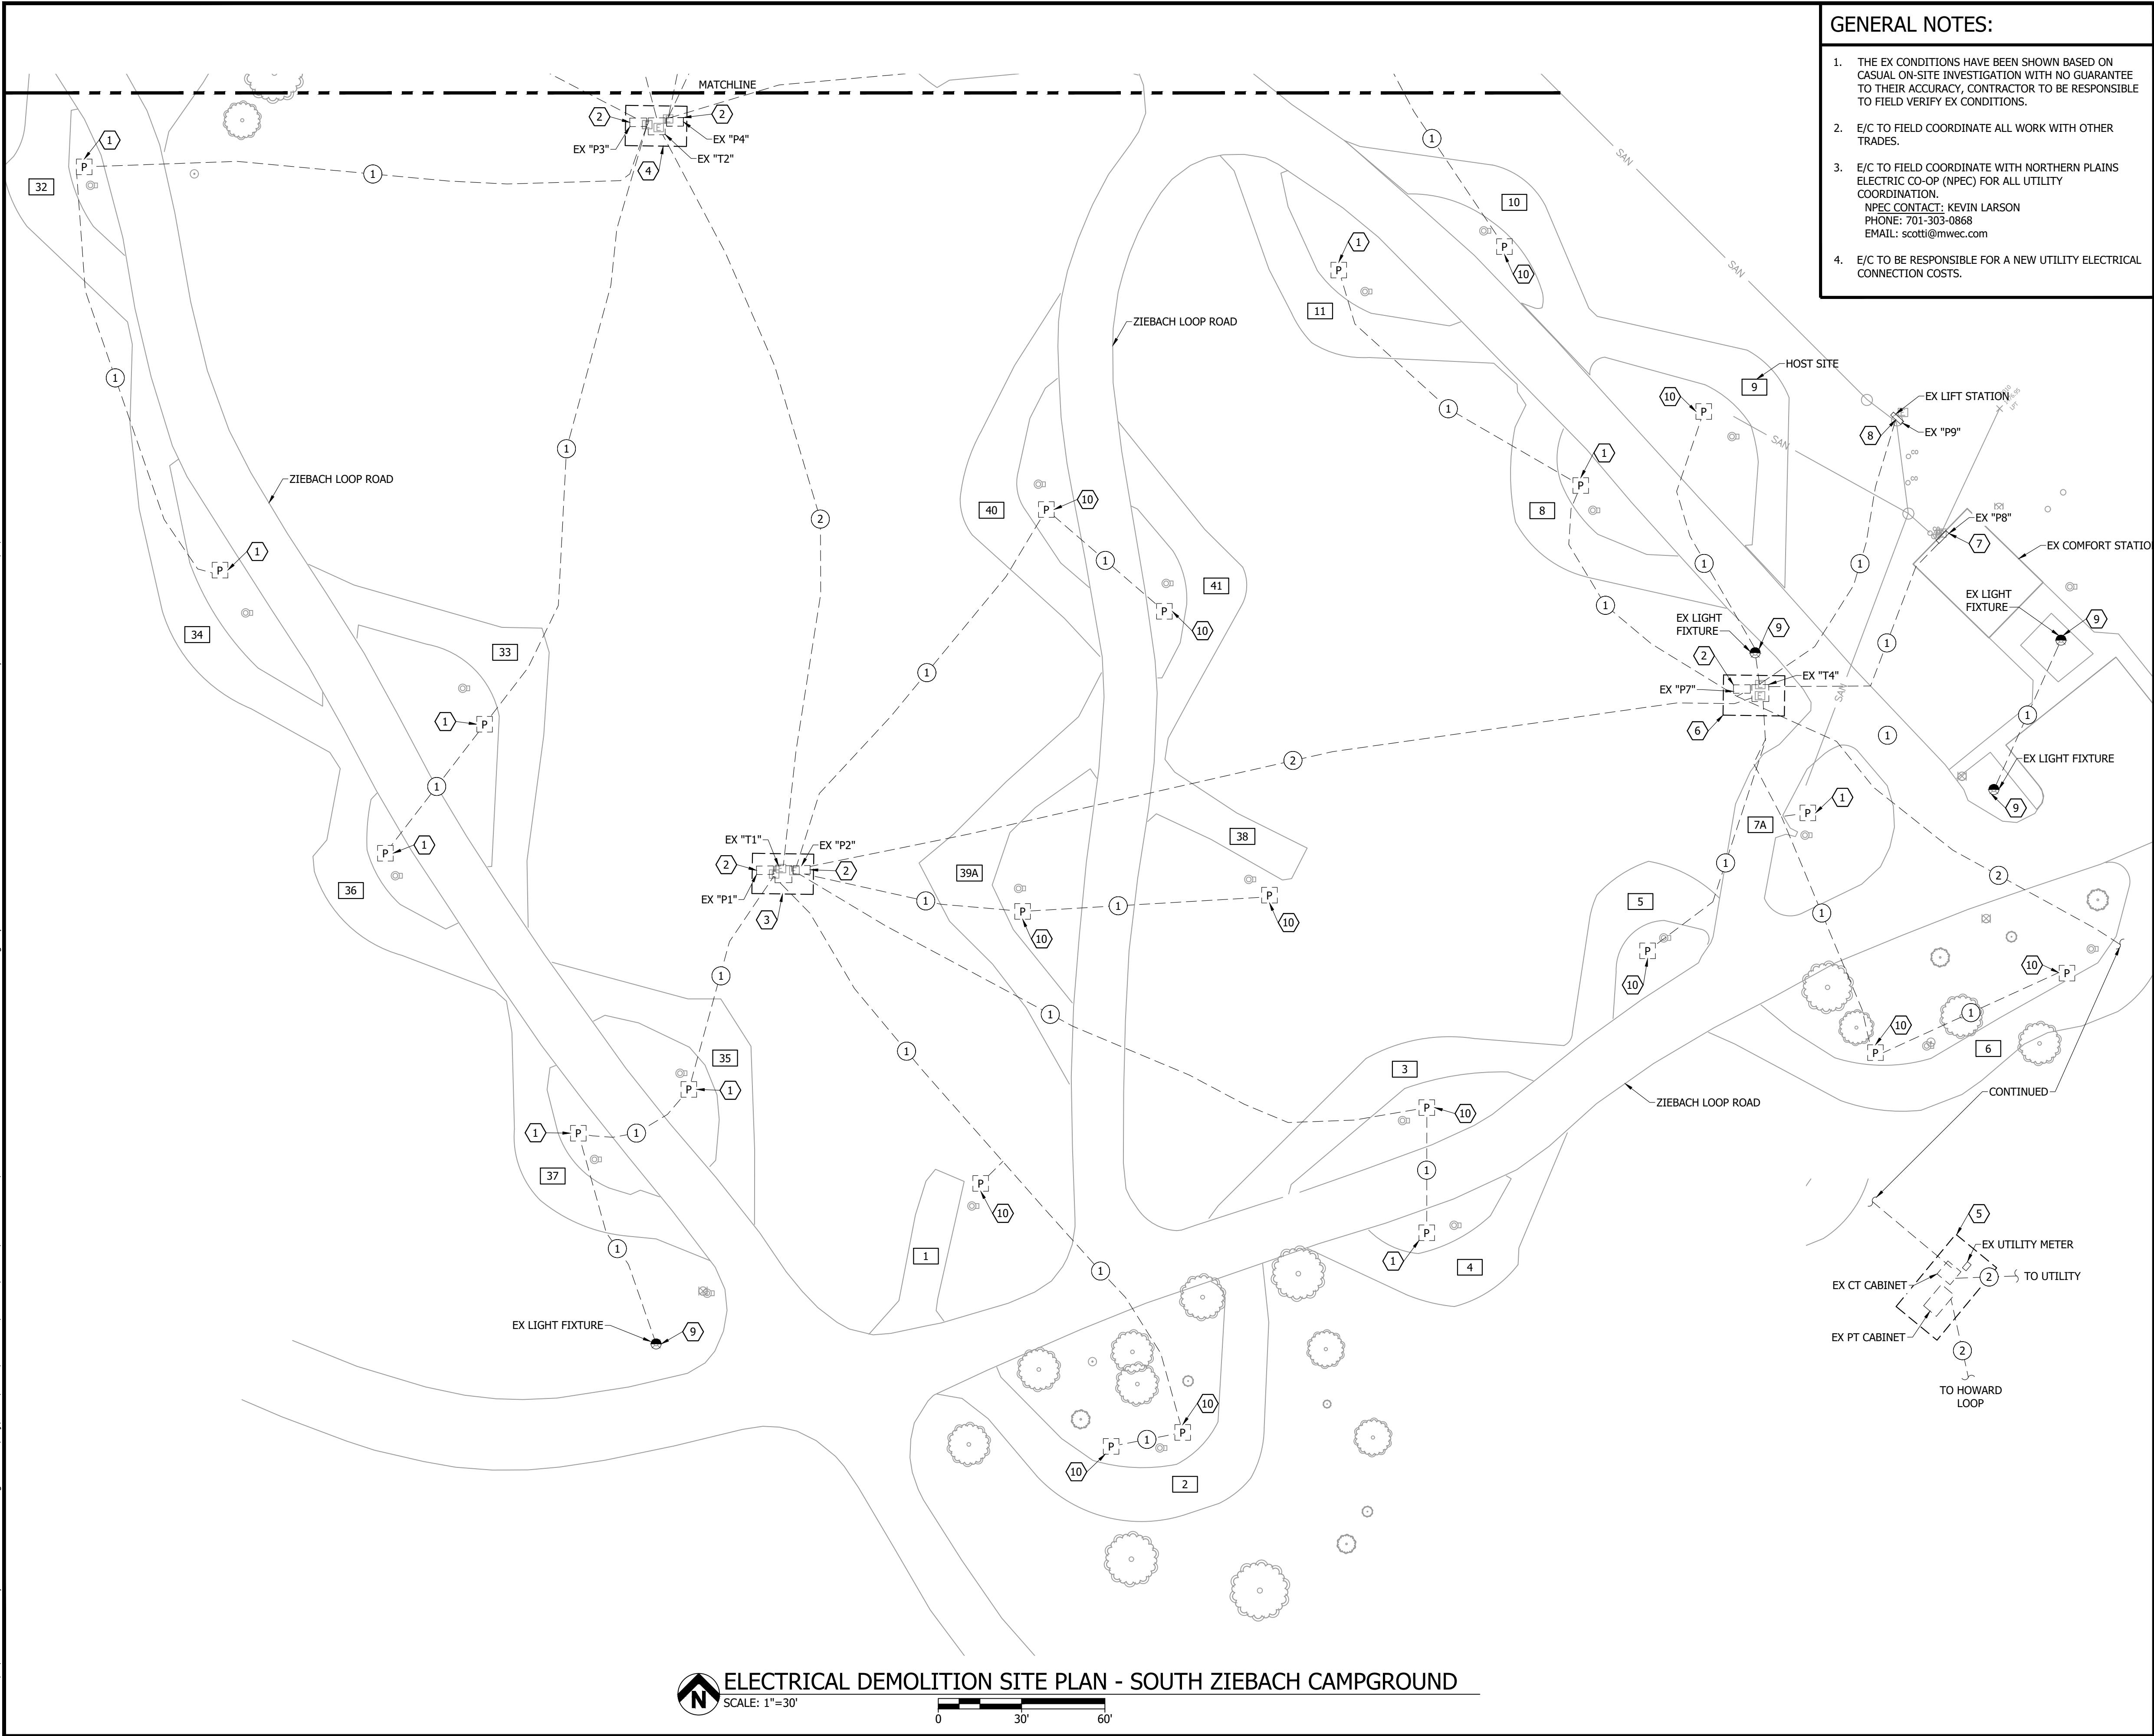

GENERAL NOTES:

1. THE EX CONDITIONS HAVE BEEN SHOWN BASED ON CASUAL ON-SITE INVESTIGATION WITH NO GUARANTEE TO THEIR ACCURACY, CONTRACTOR TO BE RESPONSIBLE TO FIELD VERIFY EX CONDITIONS.
2. E/C TO FIELD COORDINATE ALL WORK WITH OTHER TRADES.
3. E/C TO FIELD COORDINATE WITH NORTHERN PLAINS ELECTRIC CO-OP (NPEC) FOR ALL UTILITY COORDINATION.  
NPEC CONTACT: KEVIN LARSON  
PHONE: 701-303-0868  
EMAIL: scotti@mwec.com
4. E/C TO BE RESPONSIBLE FOR A NEW UTILITY ELECTRICAL CONNECTION COSTS.


REFERENCE NOTES:

- 1 EX POWER PEDESTAL TO REMAIN. EX 50 AMP/2P CIRCUIT BREAKER AND RECEPTACLE, EX 30 AMP/1P CIRCUIT BREAKER AND RECEPTACLE TO REMAIN. EX 20 AMP/1P CIRCUIT BREAKER AND GFCI RECEPTACLE TO BE REMOVED. EX MAIN FEEDER POWER CONNECTION TO BE REMOVED. EX BELOW GRADE DIRECT BURY WIRE TO BE CUT BACK AND REMOVED TO 1'-0" BELOW GRADE. EX BELOW GRADE DIRECT BURY WIRE BELOW 1'-0" TO BE DISCONNECTED, LABELED "ABANDONED", AND ABANDONED IN PLACE. REFER TO ELECTRICAL IMPROVEMENT SITE PLAN - ZIEBACH LOOP FOR NEW POWER PEDESTAL IMPROVEMENTS.
- 2 EX PANELBOARD, POWER CONNECTION, UNISTRUT, AND ALL ASSOCIATED ABOVE GRADE WIRE AND CONDUIT TO BE REMOVED. EX BELOW GRADE DIRECT BURY WIRE TO BE CUT BACK AND REMOVED TO 1'-0" BELOW GRADE. EX BELOW GRADE DIRECT BURY WIRE BELOW 1'-0" TO BE DISCONNECTED, LABELED "ABANDONED", AND ABANDONED IN PLACE. REFER TO ELECTRICAL IMPROVEMENT SITE PLAN - ZIEBACH LOOP FOR NEW PANELBOARD IMPROVEMENTS.
- 3 E/C TO REFER TO ELECTRICAL DETAILS 1/GI-E-503 AND 1/GI-E-603.
- 4 E/C TO REFER TO ELECTRICAL DETAILS 2/GI-E-503 AND 1/GI-E-603.
- 5 E/C TO REFER TO ELECTRICAL DETAILS 4/GI-E-503 AND 1/GI-E-603.
- 6 E/C TO REFER TO ELECTRICAL DETAILS 5/GI-E-503 AND 1/GI-E-603.
- 7 EX PANELBOARD TO REMAIN. EX POWER CONNECTION AND ALL ASSOCIATED ABOVE GRADE WIRE AND CONDUIT TO REMAIN. EX BELOW GRADE DIRECT BURY WIRE TO BE CUT BACK AND REMOVED TO 1'-0" BELOW GRADE. EX BELOW GRADE DIRECT BURY WIRE BELOW 1'-0" TO BE DISCONNECTED, LABELED "ABANDONED", AND ABANDONED IN PLACE. REFER TO ELECTRICAL IMPROVEMENT SITE PLAN - ZIEBACH LOOP FOR NEW PANELBOARD IMPROVEMENTS. E/C TO REFER TO ELECTRICAL DETAILS 6/GI-E-503 AND 1/GI-E-603.
- 8 EX PANELBOARD AND UNISTRUT TO REMAIN. EX POWER CONNECTION AND ALL ASSOCIATED ABOVE GRADE WIRE AND CONDUIT TO REMAIN. EX BELOW GRADE DIRECT BURY WIRE TO BE CUT BACK AND REMOVED TO 1'-0" BELOW GRADE. EX BELOW GRADE DIRECT BURY WIRE BELOW 1'-0" TO BE DISCONNECTED, LABELED "ABANDONED", AND ABANDONED IN PLACE. REFER TO ELECTRICAL IMPROVEMENT SITE PLAN - ZIEBACH LOOP FOR NEW PANELBOARD IMPROVEMENTS. E/C TO REFER TO ELECTRICAL DETAILS 7/GI-E-503 AND 1/GI-E-603.
- 9 EX POLE MOUNTED LIGHTING FIXTURE AND ASSOCIATED LIGHTING POLE TO REMAIN AND BE RECONNECTED. EX POWER CONNECTION AND ALL ASSOCIATED ABOVE GRADE WIRE AND CONDUIT TO BE REMOVED. EX BELOW GRADE DIRECT BURY WIRE TO BE CUT BACK AND REMOVED TO 1'-0" BELOW GRADE. EX BELOW GRADE DIRECT BURY WIRE BELOW 1'-0" TO BE DISCONNECTED, LABELED "ABANDONED", AND ABANDONED IN PLACE. REFER TO ELECTRICAL IMPROVEMENT SITE PLAN - ZIEBACH LOOP FOR LIGHTING FIXTURE POWER CONNECTION.
- 10 EX POWER PEDESTAL TO BE REMOVED AND RELOCATED. EX 50 AMP/2P CIRCUIT BREAKER AND RECEPTACLE, EX 30 AMP/1P CIRCUIT BREAKER AND RECEPTACLE TO REMAIN. EX 20 AMP/1P CIRCUIT BREAKER AND GFCI RECEPTACLE TO BE REMOVED. EX MAIN FEEDER POWER CONNECTION TO BE REMOVED. EX BELOW GRADE DIRECT BURY WIRE TO BE CUT BACK AND REMOVED TO 1'-0" BELOW GRADE. EX BELOW GRADE DIRECT BURY WIRE BELOW 1'-0" TO BE DISCONNECTED, LABELED "ABANDONED", AND ABANDONED IN PLACE. REFER TO ELECTRICAL IMPROVEMENT SITE PLAN - ZIEBACH LOOP FOR NEW POWER PEDESTAL IMPROVEMENTS.

FEEDER SCHEDULE:

- 1 EX UNDERGROUND DIRECT BURY BRANCH FEEDER TO REMAIN AND BE ABANDONED IN PLACE.
- 2 EX UNDERGROUND DIRECT BURY UTILITY MAIN FEEDER TO REMAIN AND BE ABANDONED IN PLACE.


KEY PLAN:

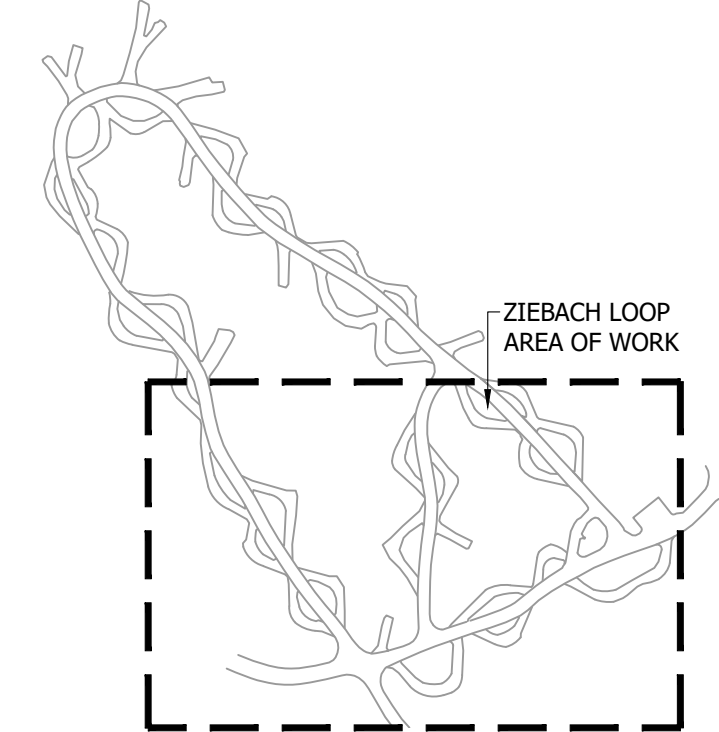

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WWW.BARTLETTWEST.COM

**ELECTRICAL DEMOLITION SITE PLAN**  
**SOUTH ZIEBACH CAMPGROUND**  
**GRAHAM'S ISLAND STATE PARK**  
**NORTH DAKOTA PARKS & RECREATION DEPARTMENT**  
**ELECTRICAL UPGRADES**  
**BISMARCK, NORTH DAKOTA**

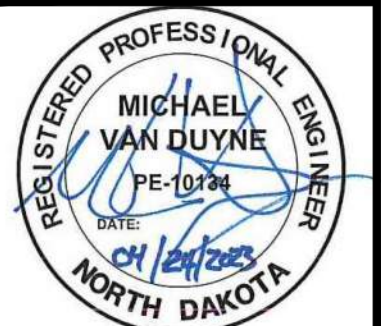

DESIGNED BY:	ARH
DRAWN BY:	SDM
APPROVED BY:	MSV
DESIGN PROJ:	21219.000
CONST PROJ:	
SCALE:	AS NOTED
DATE:	04-24-2023
DRAWING NO:	<b>GI-E-106</b>
SHEET NO:	14 of 32

Last edit on: 4/21/2023 12:25 PM by: SDW01521 Drawing Name: F:\Proj\21000\21219\21219.000\AutoCad\Plan Set\Graham's Island\21219.000E - Electrical Improvement Site Plans - GISP.dwg Layout Name: N. HOWARD IMPRV. SITE PLAN Plotted on: 4/24/2023 2:21:06 PM

BAR IS ONE INCH ON OFFICIAL DRAWINGS. 0 1" IF NOT ONE INCH, ADJUST SCALE ACCORDINGLY.

FEEDER SCHEDULE:

- EX UNDERGROUND DIRECT BURY MAIN FEEDER TO REMAIN.
- NEW UNDERGROUND DIRECT BURY BRANCH FEEDER TRENCH. REFER TO ELECTRICAL WIRING DETAIL 5/GI-E-504 FOR CIRCUITING AND FEEDER SCHEDULE.
- NEW UTILITY FEEDERS. REFER TO ELECTRICAL IMPROVEMENT RISER DIAGRAM 4/GI-E-603.
- NEW UNDERGROUND DIRECT BURY BRANCH FEEDER TRENCH. REFER TO ELECTRICAL WIRING DETAIL 6/GI-E-505 FOR CIRCUITING AND FEEDER SCHEDULE.


REFERENCE NOTES:

- E/C TO PROVIDE NEW UTILITY TRANSFORMER CONCRETE EQUIPMENT PAD. E/C TO FIELD VERIFY EXACT LOCATION AND COORDINATE ALL REQUIREMENTS WITH ELECTRIC UTILITY.
- NEW UTILITY TRANSFORMER PROVIDED BY ELECTRIC UTILITY. E/C TO COORDINATE EXACT CONNECTION REQUIREMENTS WITH ELECTRIC UTILITY.
- REFER TO ELECTRICAL IMPROVEMENT RISER DIAGRAM DETAIL 4/GI-E-603.
- NEW 600 AMP, 120/240 VOLT, 1 PHASE, 3 WIRE PANELBOARD. REFER TO PANELBOARD SCHEDULE ON SHEET GI-E-601.
- E/C HAS THE OPTION TO BORE UNDER THE STAND (RV GRAVEL PAD) OR TRENCH THROUGH THE STAND. E/C TO RECLAIM TO EX CONDITIONS. E/C TO REPLACE ALL THE DISTURBED STAND AND GRASS AREAS WITH MATCHING MATERIALS, BACKFILLING, AND SEEDING REQUIREMENTS THAT MEET NORTH DAKOTA PARKS AND RECREATION DEPARTMENT'S STANDARDS. MIXED GRAVEL/SAND/DIRT REPLACEMENT FILL MATERIAL WILL NOT BE ACCEPTED. E/C WILL BE REQUIRED TO SORT EX MATERIAL IF REUSED. E/C TO FIELD COORDINATE ALL REQUIREMENTS.
- E/C TO ROUTE UNDERGROUND FEEDER PARALLEL WITH EX LOOP ROAD. E/C SHALL NOT DISTURB EX ROAD MATERIAL AND BE RESPONSIBLE TO REPAIR ANY DAMAGED ROAD MATERIAL.
- E/C HAS THE OPTION TO BORE UNDER THE ROAD OR TRENCH THROUGH THE ROAD. E/C TO RECLAIM TO EX CONDITIONS. E/C TO REPLACE ALL THE DISTURBED ASPHALT ROADWAY, GRAVEL, AND GRASS AREAS WITH MATCHING MATERIALS, BACKFILLING, AND SEEDING REQUIREMENTS THAT MEET NORTH DAKOTA PARKS AND RECREATION DEPARTMENT'S STANDARDS. MIXED GRAVEL/SAND/DIRT REPLACEMENT FILL MATERIAL WILL NOT BE ACCEPTED. E/C WILL BE REQUIRED TO SORT EX MATERIAL IF REUSED. E/C TO FIELD COORDINATE ALL REQUIREMENTS.
- E/C TO REFER TO 1/GI-E-501 FOR NEW SINGLE BACK-IN PEDESTAL LOCATION.
- ALTERNATE BID 1: E/C TO PROVIDE NEW METER. E/C TO FIELD COORDINATE WITH OWNER ON ALL REQUIREMENTS.


GENERAL NOTES:

- E/C TO PROVIDE ALL NEW PEDESTAL UNDERGROUND DIRECT BURY BRANCH FEEDERS WITHIN THE SAME TRENCH. FIELD COORDINATE EXACT LOCATION.
- E/C SHALL NOT REMOVE OR DISTURB ANY TREES OR SHRUBS WITHOUT OWNER APPROVAL. FIELD COORDINATE WITH OWNER.
- THE EX CONDITIONS HAVE BEEN SHOWN BASED ON CASUAL ON-SITE INVESTIGATION WITH NO GUARANTEE TO THEIR ACCURACY. CONTRACTOR TO BE RESPONSIBLE TO FIELD VERIFY EX CONDITIONS.
- E/C TO FIELD COORDINATE ALL WORK WITH OTHER TRADES.
- E/C TO FIELD COORDINATE WITH NORTHERN PLAINS ELECTRIC CO-OP (NPEC) FOR ALL UTILITY COORDINATION.  
NPEC CONTACT: KEVIN LARSON  
PHONE: 701-303-0868  
EMAIL: scotti@mwec.com
- E/C TO BE RESPONSIBLE FOR A NEW UTILITY ELECTRICAL CONNECTION COSTS.
- E/C TO REPLACE ALL THE DISTURBED STAND AND GRASS AREAS WITH MATCHING VEGETATION, MATERIALS, BACKFILLING, AND SEEDING REQUIREMENTS THAT MEET NORTH DAKOTA PARKS AND RECREATION DEPARTMENT'S STANDARDS. E/C TO COORDINATE ALL REQUIREMENTS WITH NORTH DAKOTA PARKS AND RECREATION DEPARTMENT.
- E/C TO REFER TO 4/GI-E-501 FOR ALL NEW PULL-THROUGH PEDESTAL LOCATIONS, UNLESS NOTED OTHERWISE.


KEY PLAN:

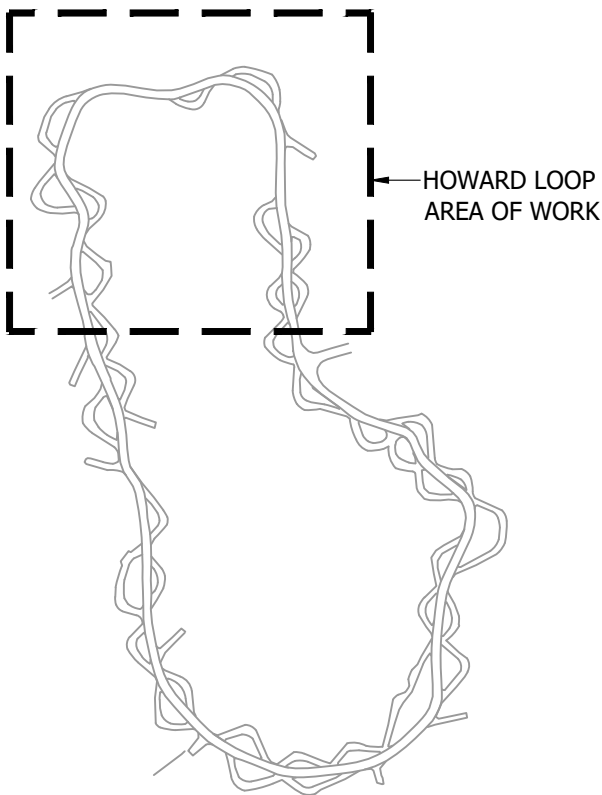

ELECTRICAL IMPROVEMENT SITE PLAN  
NORTH HOWARD CAMPGROUND  
GRAHAM'S ISLAND STATE PARK  
NORTH DAKOTA PARKS & RECREATION DEPARTMENT  
ELECTRICAL UPGRADES  
BISMARCK, NORTH DAKOTA

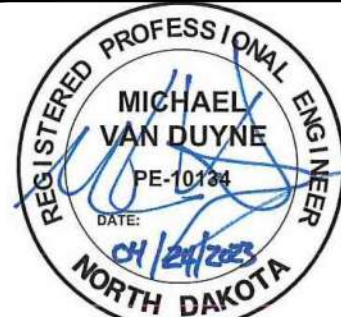

DESIGNED BY:	ARH
DRAWN BY:	SDM
APPROVED BY:	MSV
DESIGN PROJ:	21219.000
CONST PROJ:	
SCALE:	AS NOTED
DATE:	04-24-2023
DRAWING NO:	
<b>GI-E-111</b>	
SHEET NO:	15 of 32

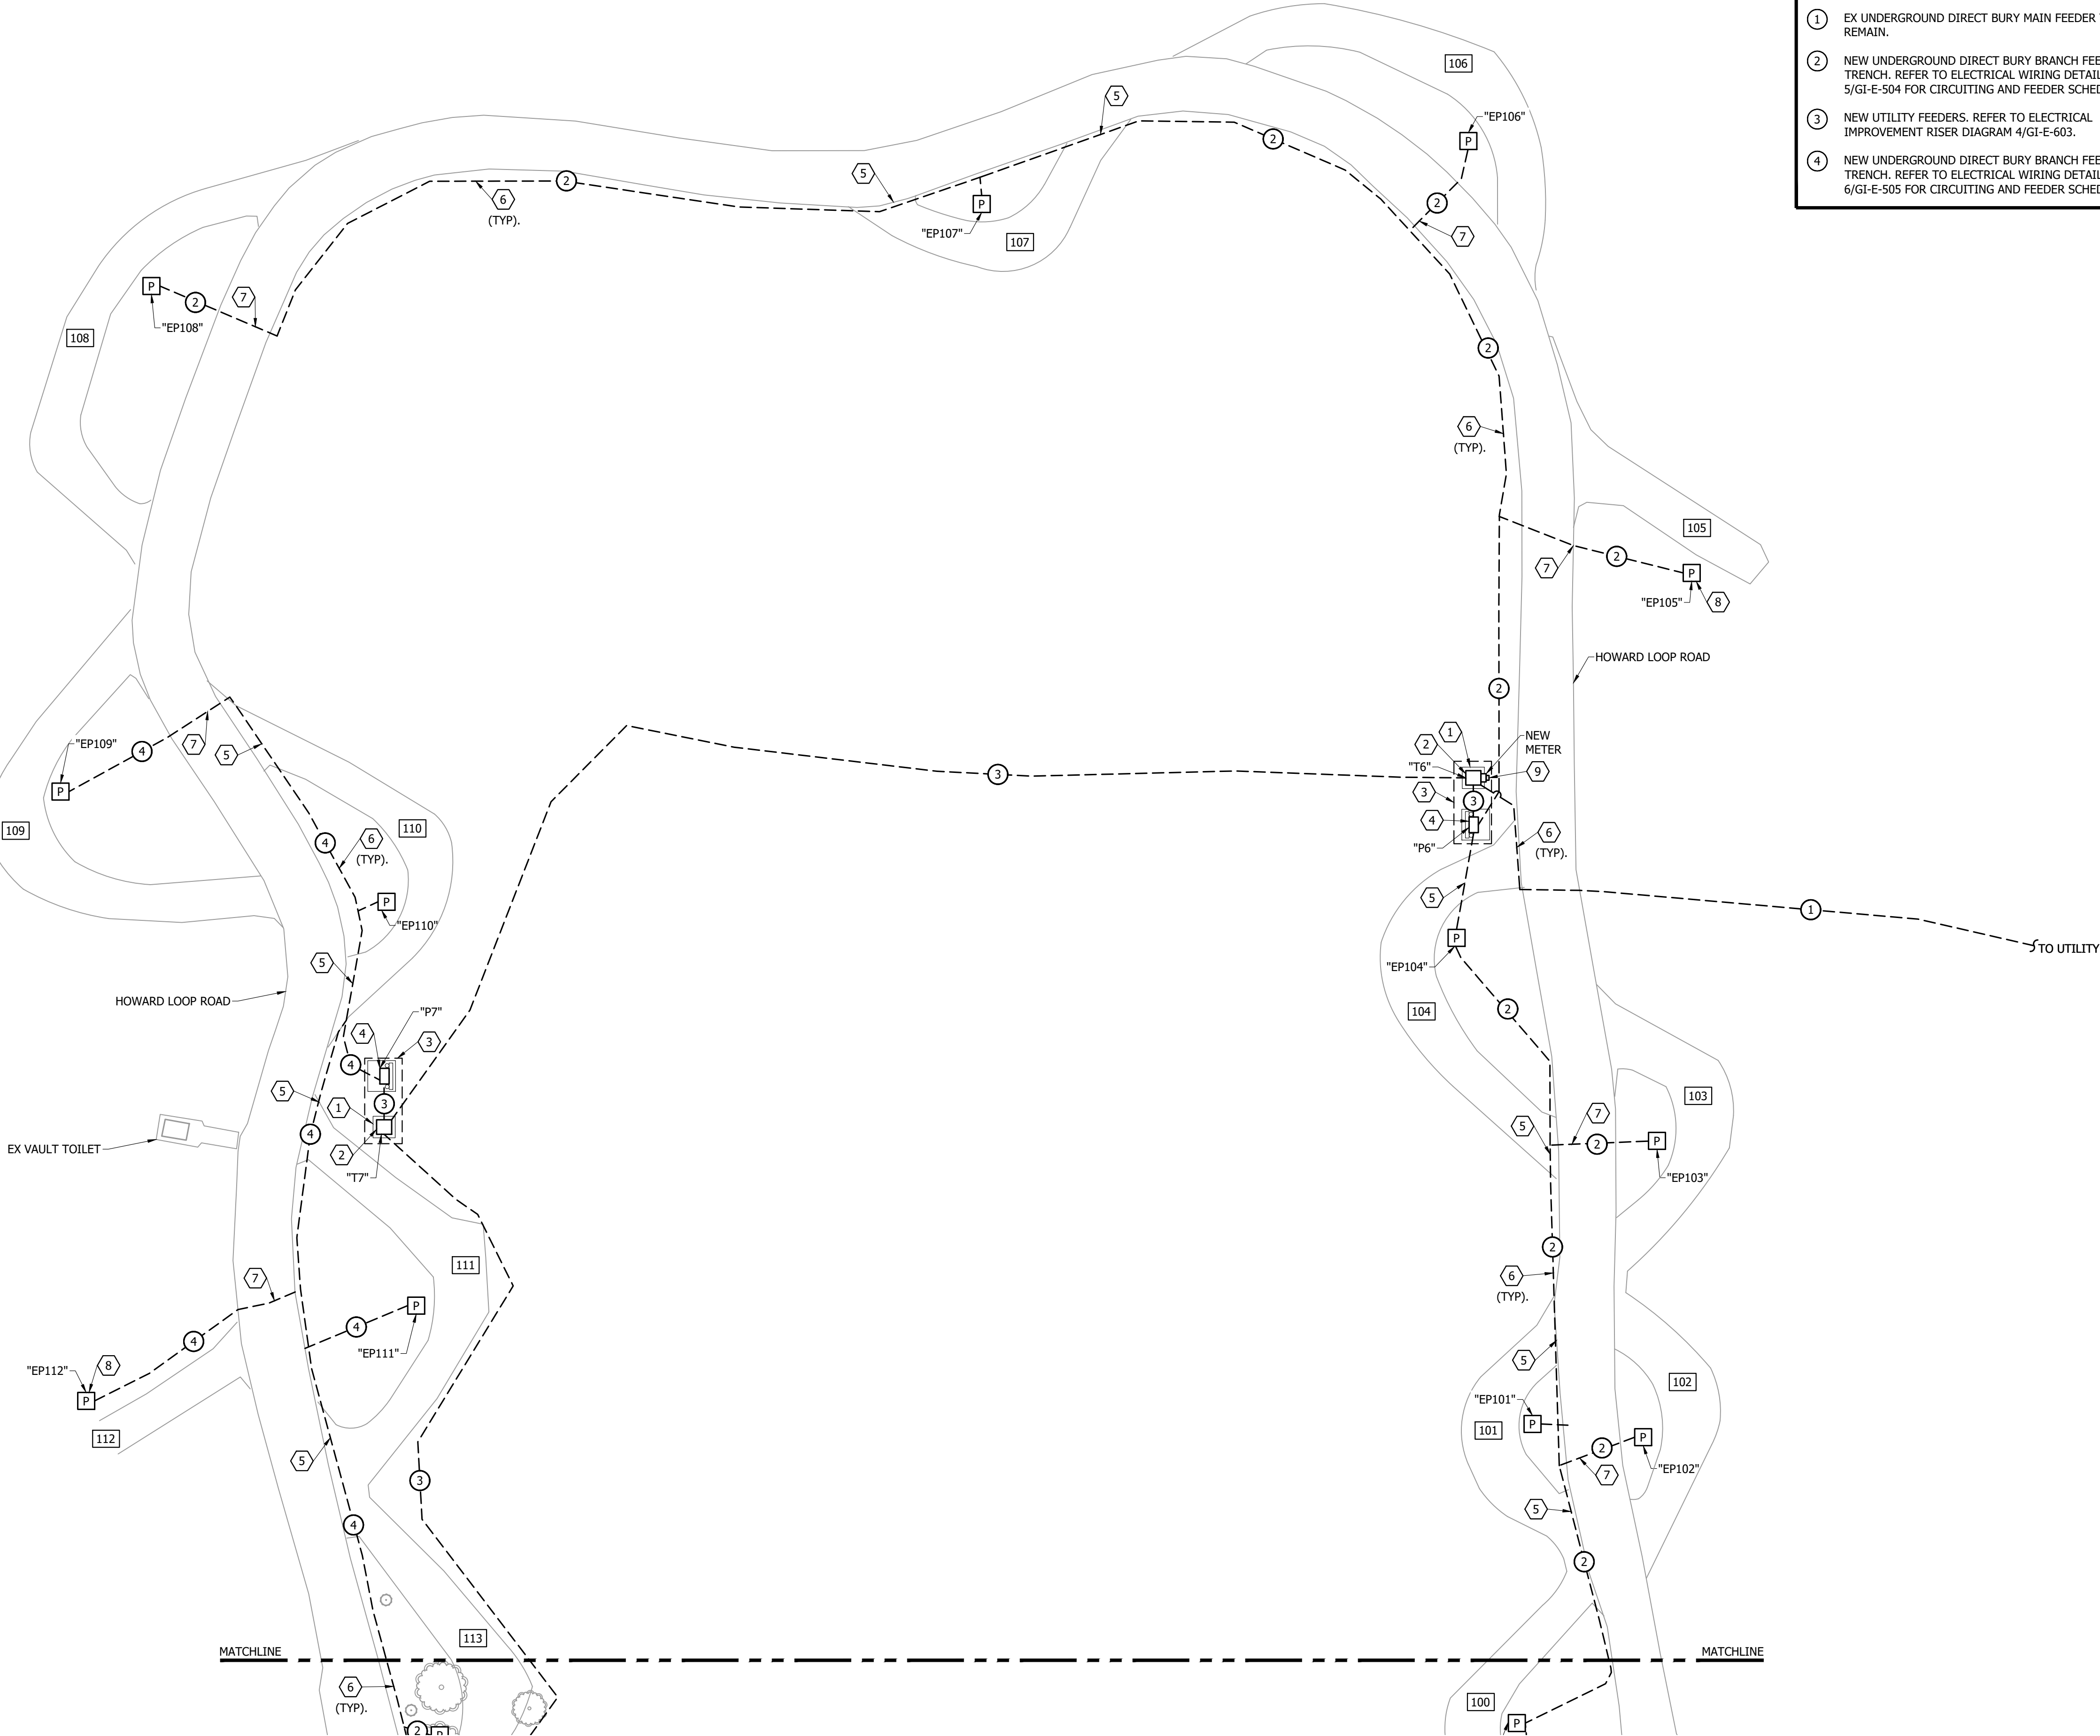

ELECTRICAL IMPROVEMENT SITE PLAN - NORTH HOWARD CAMPGROUND  
SCALE: 1"=30'




- ① NEW UNDERGROUND DIRECT BURY BRANCH FEEDER TRENCH. REFER TO ELECTRICAL WIRING DETAIL 7/GI-E-505 FOR CIRCUITING AND FEEDER SCHEDULE.
- ② NEW UNDERGROUND DIRECT BURY BRANCH FEEDER TRENCH. REFER TO ELECTRICAL WIRING DETAIL 6/GI-E-504 FOR CIRCUITING AND FEEDER SCHEDULE.
- ③ NEW UTILITY FEEDERS. REFER TO ELECTRICAL IMPROVEMENT RISER DIAGRAM 4/GI-E-603.

- 1) E/C TO PROVIDE NEW UTILITY TRANSFORMER CONCRETE EQUIPMENT PAD. E/C TO FIELD VERIFY EXACT LOCATION AND COORDINATE ALL REQUIREMENTS WITH ELECTRIC UTILITY.
- 2) NEW UTILITY TRANSFORMER PROVIDED BY ELECTRIC UTILITY. E/C TO COORDINATE EXACT CONNECTION REQUIREMENTS WITH ELECTRIC UTILITY.
- 3) REFER TO ELECTRICAL IMPROVEMENT RISER DIAGRAM DETAIL 4/GI-E-603.
- 4) NEW 600 AMP, 120/240 VOLT, 1 PHASE, 3 WIRE PANELBOARD. REFER TO PANELBOARD SCHEDULE ON SHEET GI-E-601.
- 5) E/C HAS THE OPTION TO BORE UNDER THE STAND (RV GRAVEL PAD) OR TRENCH THROUGH THE STAND. E/C TO RECLAIM TO EX CONDITIONS. E/C TO REPLACE ALL THE DISTURBED STAND AND GRASS AREAS WITH MATCHING MATERIALS, BACKFILLING, AND SEEDING REQUIREMENTS THAT MEET NORTH DAKOTA PARKS AND RECREATION DEPARTMENT'S STANDARDS. MIXED GRAVEL/SAND/DIRT REPLACEMENT FILL MATERIAL WILL NOT BE ACCEPTED. E/C WILL BE REQUIRED TO SORT EX MATERIAL IF REUSED. E/C TO FIELD COORDINATE ALL REQUIREMENTS.
- 6) E/C TO ROUTE UNDERGROUND FEEDER PARALLEL WITH EX LOOP ROAD. E/C SHALL NOT DISTURB EX ROAD MATERIAL AND BE RESPONSIBLE TO REPAIR ANY DAMAGED ROAD MATERIAL.
- 7) E/C HAS THE OPTION TO BORE UNDER THE ROAD OR TRENCH THROUGH THE ROAD. E/C TO RECLAIM TO EX CONDITIONS. E/C TO REPLACE ALL THE DISTURBED ROADWAY ASPHALT, GRAVEL, AND GRASS AREAS WITH MATCHING MATERIALS, BACKFILLING, AND SEEDING REQUIREMENTS THAT MEETING NORTH DAKOTA PARKS AND RECREATION DEPARTMENT'S STANDARDS. MIXED GRAVEL/SAND/DIRT REPLACEMENT FILL MATERIAL WILL NOT BE ACCEPTED. E/C WILL BE REQUIRED TO SORT EX MATERIAL IF REUSED. E/C TO FIELD COORDINATE ALL REQUIREMENTS.
- 8) E/C TO REFER TO 1/GI-E-501 FOR NEW SINGLE BACK-IN PEDESTAL LOCATION.

1. E/C TO PROVIDE ALL NEW PEDESTAL UNDERGROUND DIRECT BURY BRANCH FEEDERS WITHIN THE SAME TRENCH. FIELD COORDINATE EXACT LOCATION.
2. E/C SHALL NOT REMOVE OR DISTURB ANY TREES OR SHRUBS WITHOUT OWNER APPROVAL. FIELD COORDINATE WITH OWNER.
3. THE EX CONDITIONS HAVE BEEN SHOWN BASED ON CASUAL ON-SITE INVESTIGATION WITH NO GUARANTEE TO THEIR ACCURACY, CONTRACTOR TO BE RESPONSIBLE TO FIELD VERIFY EX CONDITIONS.
4. E/C TO FIELD COORDINATE ALL WORK WITH OTHER TRADES.
5. E/C TO FIELD COORDINATE WITH NORTHERN PLAINS ELECTRIC CO-OP (NPEC) FOR ALL UTILITY COORDINATION.  
NPEC CONTACT: KEVIN LARSON  
PHONE: 701-303-0868  
EMAIL: scotti@mwec.com
6. E/C TO BE RESPONSIBLE FOR A NEW UTILITY ELECTRICAL CONNECTION COSTS.
7. E/C TO REPLACE ALL THE DISTURBED STAND AND GRASS AREAS WITH MATCHING VEGETATION, MATERIALS, BACKFILLING, AND SEEDING REQUIREMENTS THAT MEET NORTH DAKOTA PARKS AND RECREATION DEPARTMENT'S STANDARDS. MIXED GRAVEL/SAND/DIRT REPLACEMENT FILL MATERIAL WILL NOT BE ACCEPTED. E/C WILL BE REQUIRED TO SORT EX MATERIAL IF REUSED. E/C TO COORDINATE ALL REQUIREMENTS WITH NORTH DAKOTA PARKS AND RECREATION DEPARTMENT.
8. E/C TO REFER TO 4/GI-E-501 FOR ALL NEW PULL-THROUGH PEDESTAL LOCATIONS, UNLESS NOTED OTHERWISE.




A diagram showing a large, irregular loop of a road, labeled "HOWARD LOOP AREA OF WORK". The loop is drawn with a solid line. A dashed rectangular box is drawn on the left side of the loop, indicating a specific section of the road. An arrow points from the text label to the dashed box.

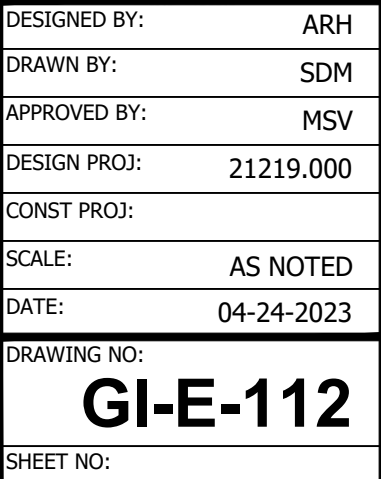


3456 E CENTURY AVENUE - BISMARCK, ND 58503  
PHONE 701-258-1110 - FAX 701-258-1111  
[www.bartlettwest.com](http://www.bartlettwest.com)

**ELECTRICAL IMPROVEMENT SITE PLAN  
WEST HOWARD CAMPGROUND  
GRAHAMS ISLAND STATE PARK  
NORTH DAKOTA PARKS & RECREATION DEPARTMENT  
ELECTRICAL UPGRADES  
BISMARCK, NORTH DAKOTA**

Last edit on: 4/21/2023 12:25 PM by: SDM01521 Drawing Name: F:\proj\21000\21219\01219.000\AutoCad\Plan Set\Graham's Island\21219.000E - Electrical Improvement Site Plans - GISP.dwg Layout Name: E. HOWARD IMPRV. SITE PLAN Plotted on: 4/24/2023 2:21:52 PM

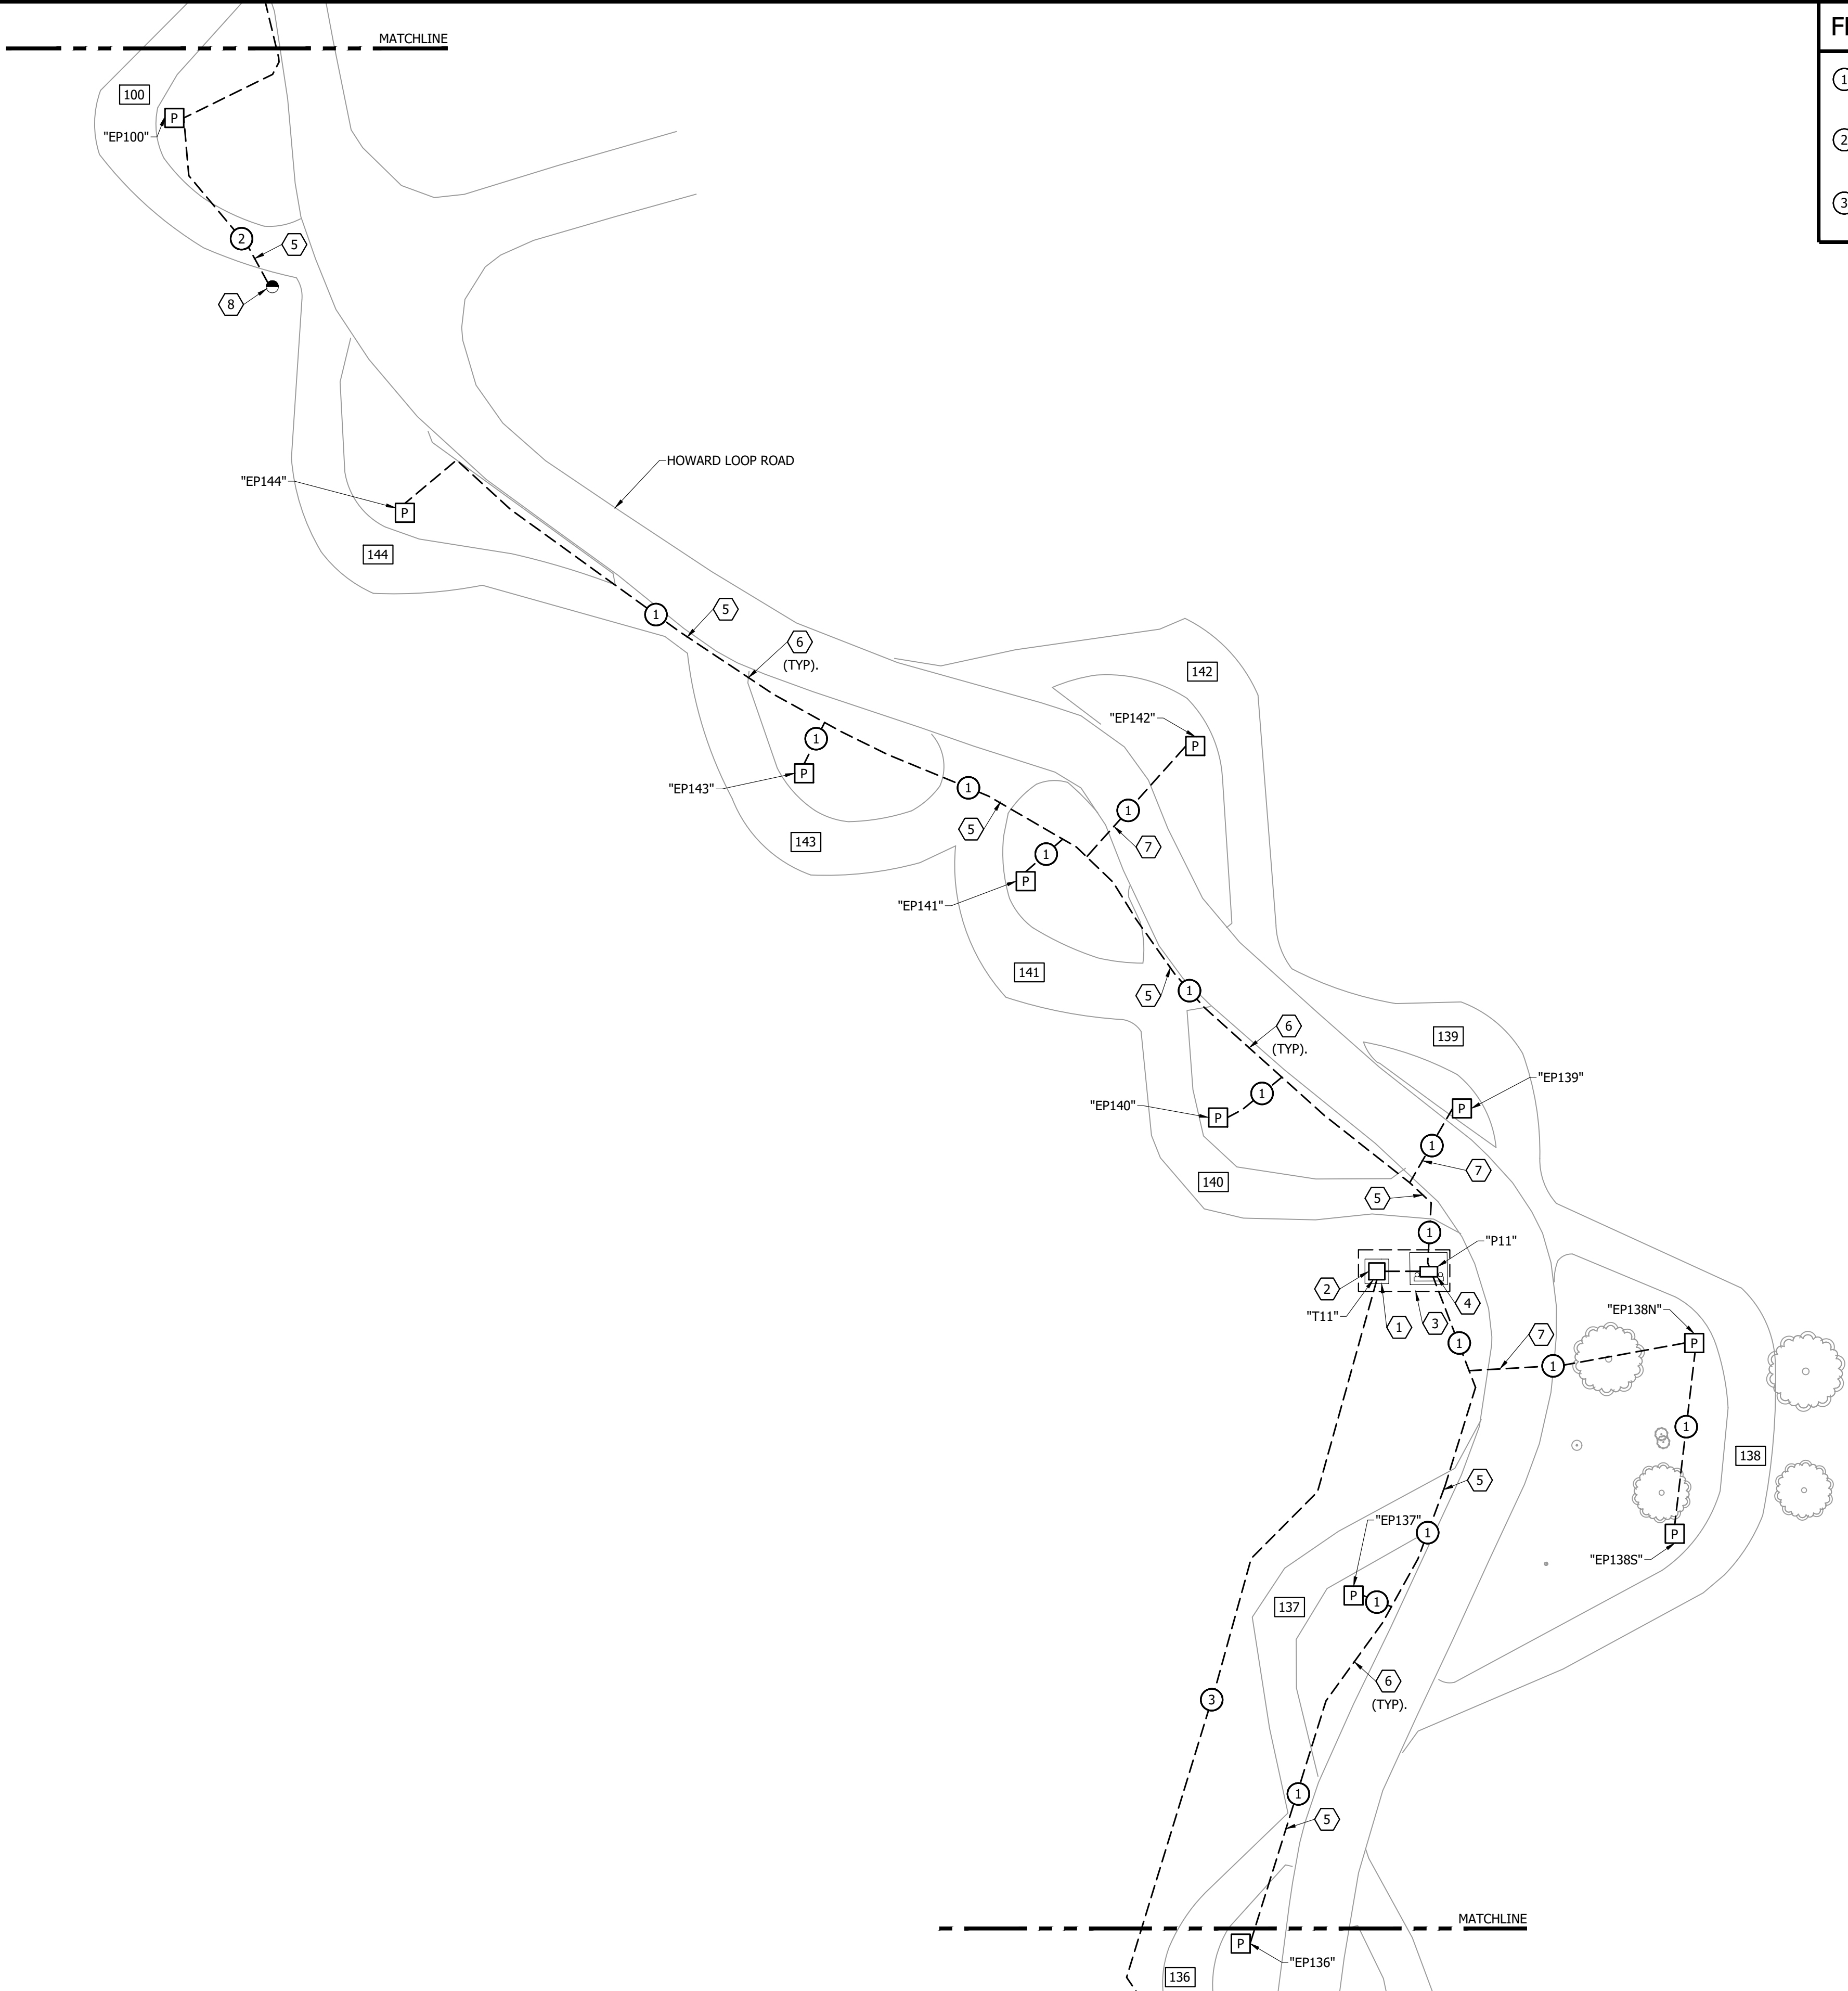

 **ELECTRICAL IMPROVEMENT SITE PLAN - EAST HOWARD CAMPGROUND**  
SCALE: 1"=30'

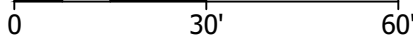

**FEEDER SCHEDULE:**

- 1 NEW UNDERGROUND DIRECT BURY BRANCH FEEDER TRENCH. REFER TO ELECTRICAL WIRING DETAIL 10/GI-E-507 FOR CIRCUITING AND FEEDER SCHEDULE.
- 2 NEW UNDERGROUND DIRECT BURY BRANCH FEEDER TRENCH. REFER TO ELECTRICAL WIRING DETAIL 5/GI-E-504 FOR CIRCUITING AND FEEDER SCHEDULE.
- 3 NEW UTILITY FEEDERS. REFER TO ELECTRICAL IMPROVEMENT RISER DIAGRAM 4/GI-E-603.


**REFERENCE NOTES:**

- 1 E/C TO PROVIDE NEW UTILITY TRANSFORMER CONCRETE EQUIPMENT PAD. E/C TO FIELD VERIFY EXACT LOCATION AND COORDINATE ALL REQUIREMENTS WITH ELECTRIC UTILITY.
- 2 NEW UTILITY TRANSFORMER PROVIDED BY ELECTRIC UTILITY. E/C TO COORDINATE EXACT CONNECTION REQUIREMENTS WITH ELECTRIC UTILITY.
- 3 REFER TO ELECTRICAL IMPROVEMENT RISER DIAGRAM DETAIL 4/GI-E-603.
- 4 NEW 600 AMP, 120/240 VOLT, 1 PHASE, 3 WIRE PANELBOARD. REFER TO PANELBOARD SCHEDULE ON SHEET GI-E-601.
- 5 E/C HAS THE OPTION TO BORE UNDER THE STAND (RV GRAVEL PAD) OR TRENCH THROUGH THE STAND. E/C TO RECLAIM TO EX CONDITIONS. E/C TO REPLACE ALL THE DISTURBED STAND AND GRASS AREAS WITH MATCHING MATERIALS, BACKFILLING, AND SEEDING REQUIREMENTS THAT MEET NORTH DAKOTA PARKS AND RECREATION DEPARTMENT'S STANDARDS. MIXED GRAVEL/SAND/DIRT REPLACEMENT FILL MATERIAL WILL NOT BE ACCEPTED. E/C WILL BE REQUIRED TO SORT EX MATERIAL IF REUSED. E/C TO FIELD COORDINATE ALL REQUIREMENTS.
- 6 E/C TO ROUTE UNDERGROUND FEEDER PARALLEL WITH EX LOOP ROAD. E/C SHALL NOT DISTURB EX ROAD MATERIAL AND BE RESPONSIBLE TO REPAIR ANY DAMAGED ROAD MATERIAL.
- 7 E/C HAS THE OPTION TO BORE UNDER THE ROAD OR TRENCH THROUGH THE ROAD. E/C TO RECLAIM TO EX CONDITIONS. E/C TO REPLACE ALL THE DISTURBED ASPHALT ROADWAY, GRAVEL, AND GRASS AREAS WITH MATCHING MATERIALS, BACKFILLING, AND SEEDING REQUIREMENTS THAT MEET NORTH DAKOTA PARKS AND RECREATION DEPARTMENT'S STANDARDS. MIXED GRAVEL/SAND/DIRT REPLACEMENT FILL MATERIAL WILL NOT BE ACCEPTED. E/C WILL BE REQUIRED TO SORT EX MATERIAL IF REUSED. E/C TO FIELD COORDINATE ALL REQUIREMENTS.
- 8 E/C TO CONNECT NEW FEEDER WIRE AND CONDUIT TO EX POLE MOUNTED LIGHTING FIXTURE. ALL EXPOSED FEEDER WIRE TO BE IN RIGID CONDUIT PAINTED TO MATCH EX POLE FINISH. FIELD VERIFY EXACT REQUIREMENTS.

**GENERAL NOTES:**

1. E/C TO PROVIDE ALL NEW PEDESTAL UNDERGROUND DIRECT BURY BRANCH FEEDERS WITHIN THE SAME TRENCH. FIELD COORDINATE EXACT LOCATION.
2. E/C SHALL NOT REMOVE OR DISTURB ANY TREES OR SHRUBS WITHOUT OWNER APPROVAL. FIELD COORDINATE WITH OWNER.
3. THE EX CONDITIONS HAVE BEEN SHOWN BASED ON CASUAL ON-SITE INVESTIGATION WITH NO GUARANTEE TO THEIR ACCURACY, CONTRACTOR TO BE RESPONSIBLE TO FIELD VERIFY EX CONDITIONS.
4. E/C TO FIELD COORDINATE ALL WORK WITH OTHER TRADES.
5. E/C TO FIELD COORDINATE WITH NORTHERN PLAINS ELECTRIC CO-OP (NPEC) FOR ALL UTILITY COORDINATION.  
NPEC CONTACT: KEVIN LARSON  
PHONE: 701-303-0868  
EMAIL: scotti@mwec.com
6. E/C TO BE RESPONSIBLE FOR A NEW UTILITY ELECTRICAL CONNECTION COSTS.
7. E/C TO REPLACE ALL THE DISTURBED STAND AND GRASS AREAS WITH MATCHING VEGETATION, MATERIALS, BACKFILLING, AND SEEDING REQUIREMENTS THAT MEET NORTH DAKOTA PARKS AND RECREATION DEPARTMENT'S STANDARDS. MIXED GRAVEL/SAND/DIRT REPLACEMENT FILL MATERIAL WILL NOT BE ACCEPTED. E/C WILL BE REQUIRED TO SORT EX MATERIAL IF REUSED. E/C TO COORDINATE ALL REQUIREMENTS WITH NORTH DAKOTA PARKS AND RECREATION DEPARTMENT.
8. E/C TO REFER TO 4/GI-E-501 FOR ALL NEW PULL-THROUGH PEDESTAL LOCATIONS, UNLESS NOTED OTHERWISE.

**KEY PLAN:**

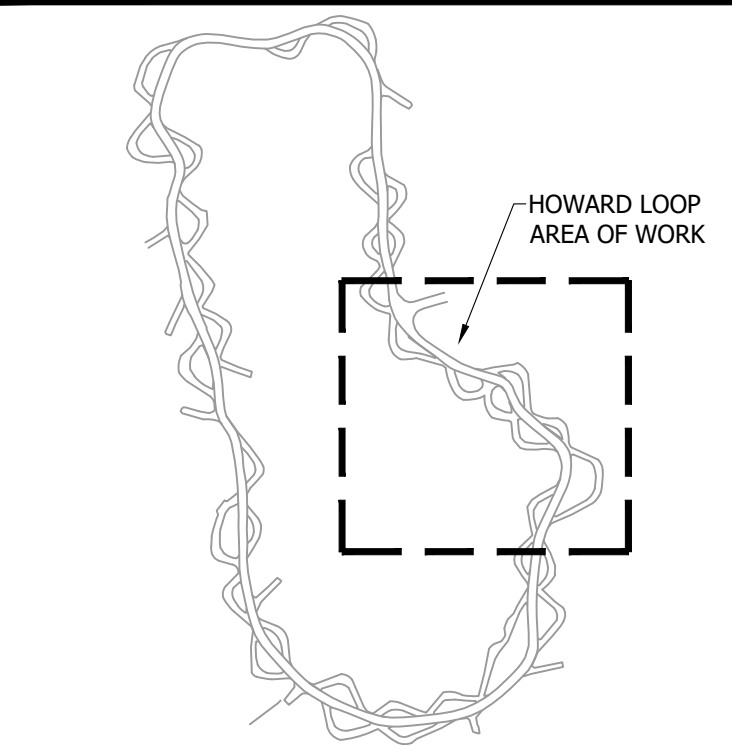


BY	
DESCRIPTION	
DATE	
#	

**Bartlett & West**

3456 E CENTURY AVENUE - BISMARCK, ND 58503  
PHONE 701-258-1110 - FAX 701-258-1111  
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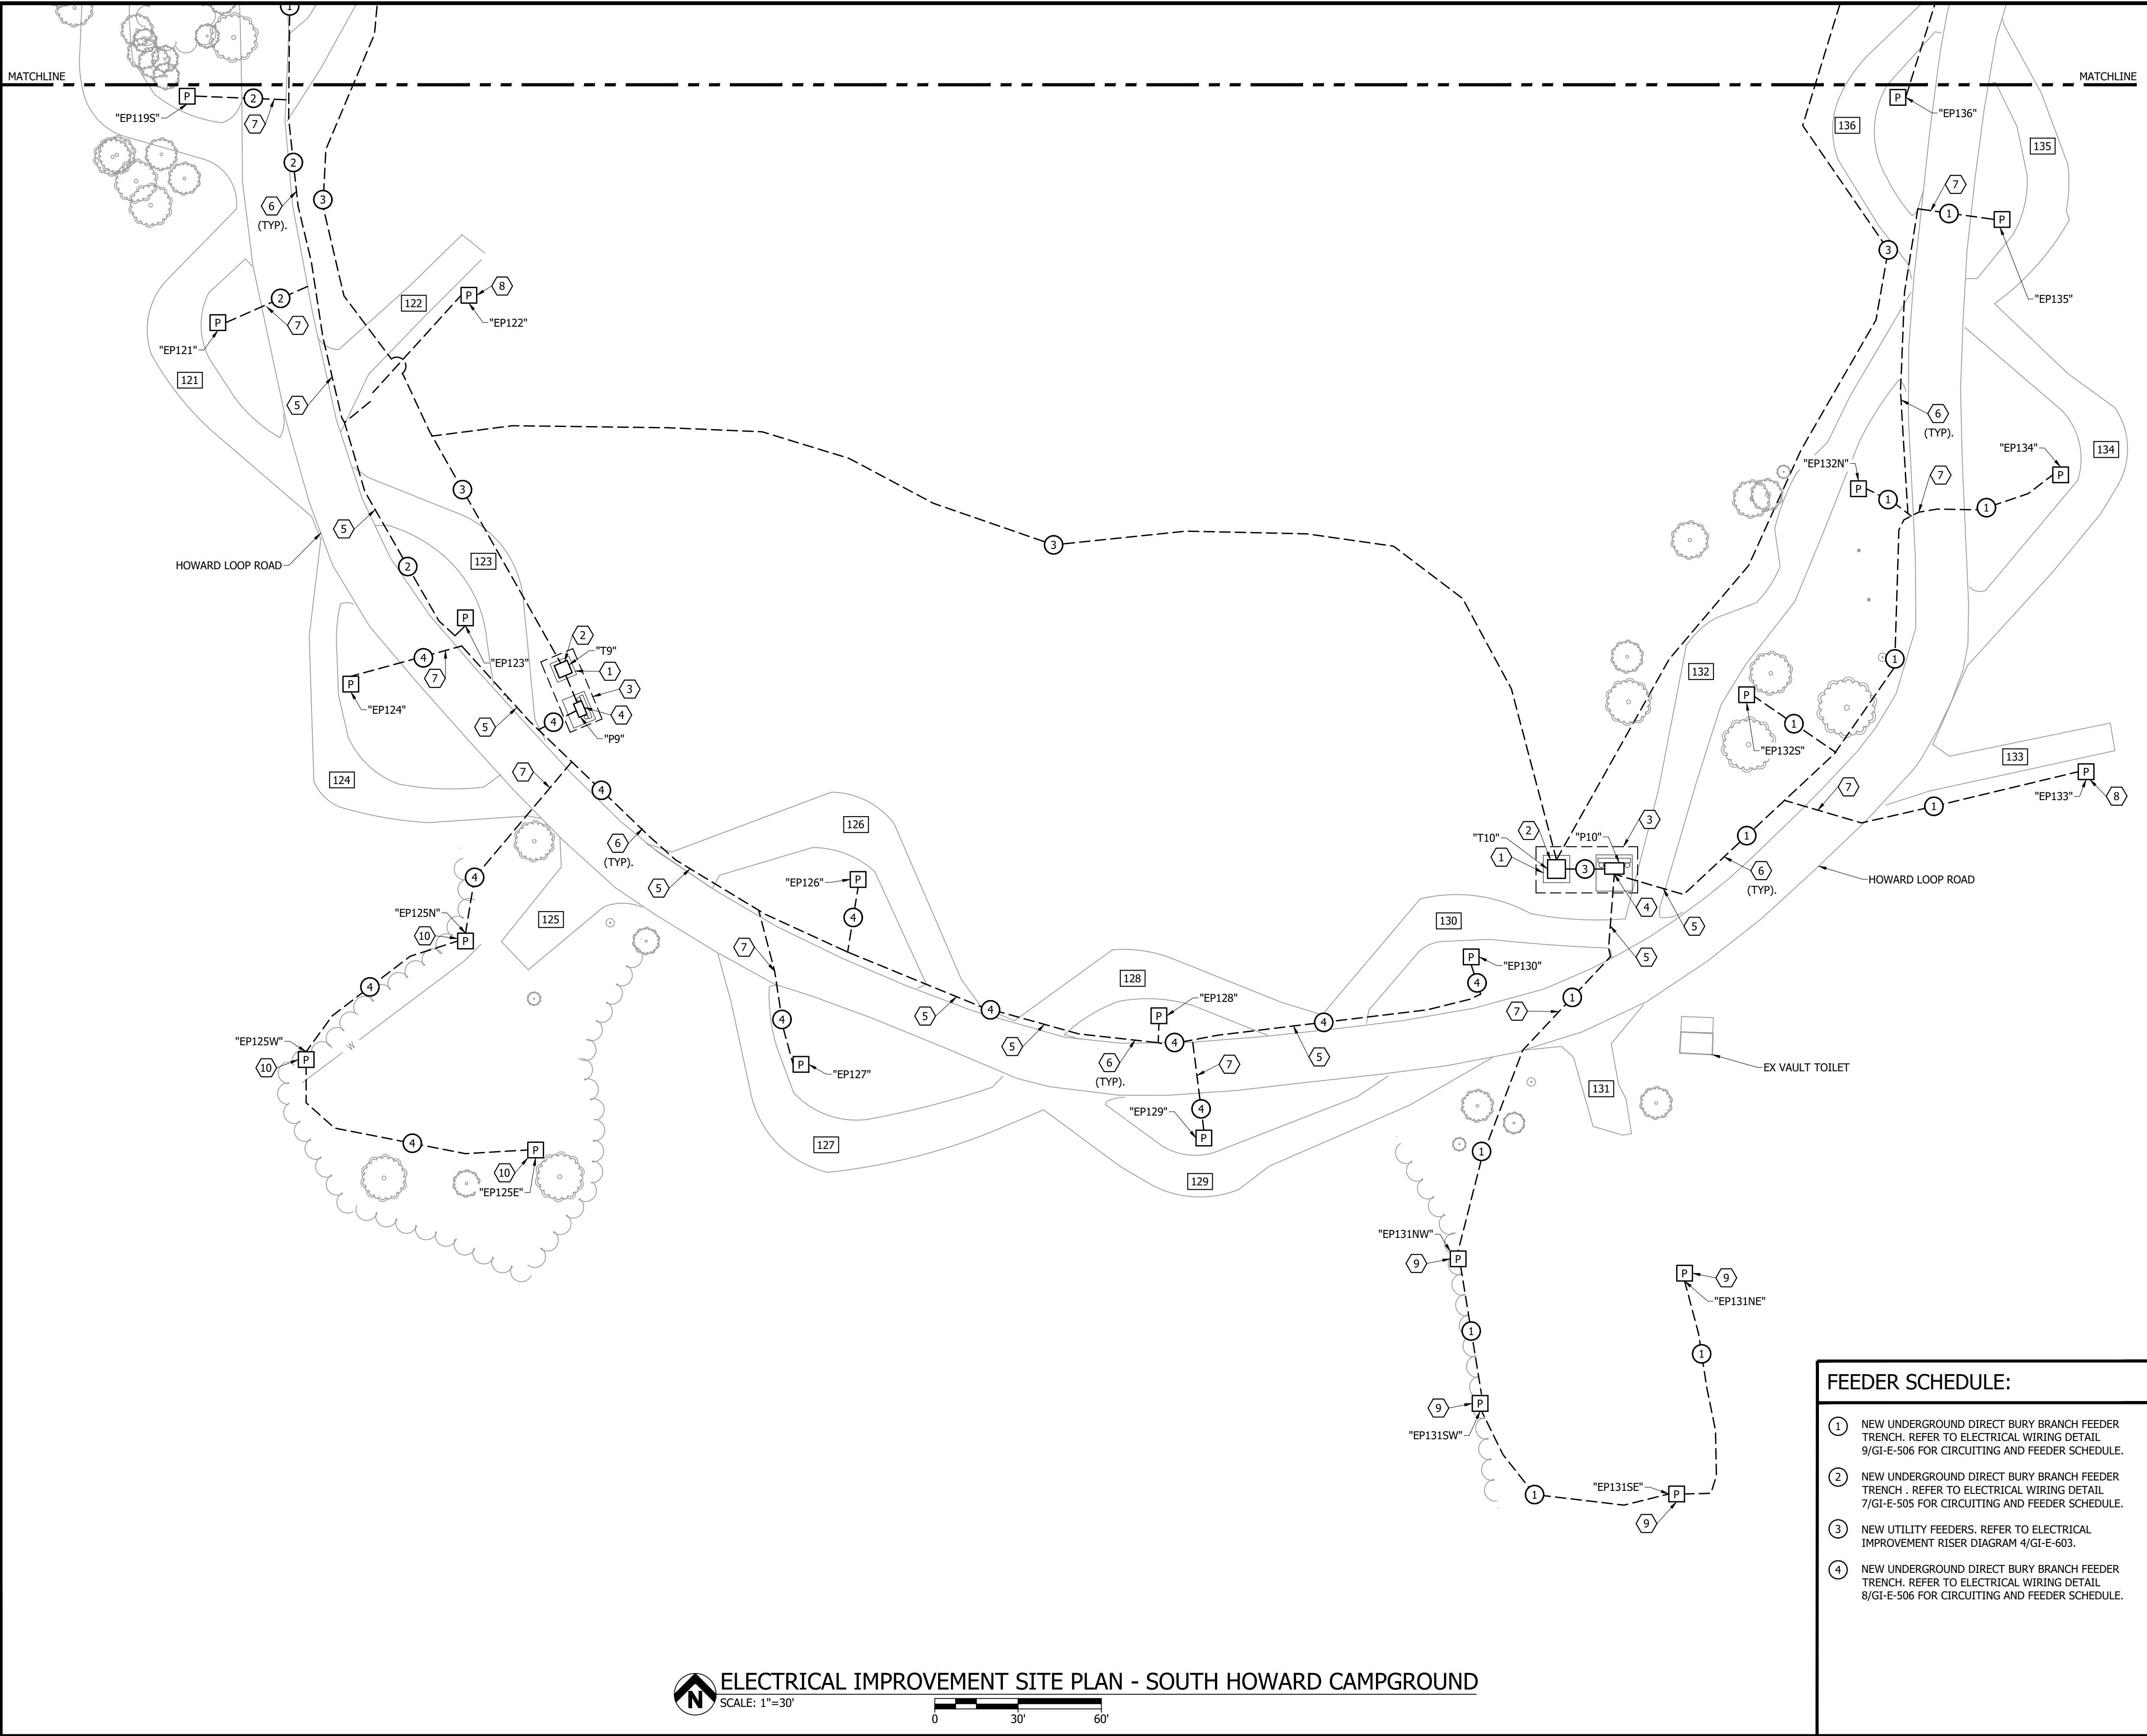
**ELECTRICAL IMPROVEMENT SITE PLAN  
EAST HOWARD CAMPGROUND  
GRAHAM'S ISLAND STATE PARK  
NORTH DAKOTA PARKS & RECREATION DEPARTMENT  
ELECTRICAL UPGRADES  
BISMARCK, NORTH DAKOTA**

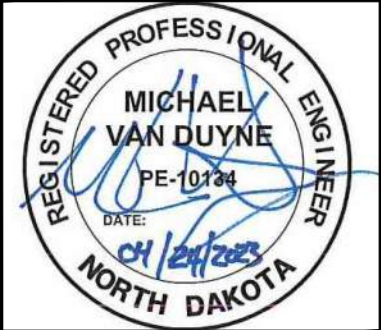

DESIGNED BY:	ARH
DRAWN BY:	SDM
APPROVED BY:	MSV
DESIGN PROJ:	21219.000
CONST PROJ:	
SCALE:	AS NOTED
DATE:	04-24-2023
DRAWING NO:	<b>GI-E-113</b>
SHEET NO:	17 of 32

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Last edit on: 4/21/2023 12:25 PM by: SDW01521 Drawing Name: F:\proj\21000\21219\21219.000\AutoCad\Plan Set\Graham's Island\21219.000E - Electrical Improvement Site Plans - GISP.dwg Layout Name: S. HOWARD IMPRV. SITE PLAN Plotted on: 4/24/2023 2:21:30 PM



REFERENCE NOTES:

1

E/C TO PROVIDE NEW UTILITY TRANSFORMER CONCRETE EQUIPMENT PAD. E/C TO FIELD VERIFY EXACT LOCATION AND COORDINATE ALL REQUIREMENTS WITH ELECTRIC UTILITY.

2

NEW UTILITY TRANSFORMER AND UTILITY METER, PROVIDED BY ELECTRIC UTILITY. E/C TO COORDINATE EXACT CONNECTION REQUIREMENTS WITH ELECTRIC UTILITY.

3

REFER TO ELECTRICAL IMPROVEMENT RISER DIAGRAM DETAIL 4/GI-E-603.

4

NEW 600 AMP, 120/240 VOLT, 1 PHASE, 3 WIRE PANELBOARD. REFER TO PANELBOARD SCHEDULE ON SHEET GI-E-601.

5

E/C HAS THE OPTION TO BORE UNDER THE STAND (RV GRAVEL PAD) OR TRENCH THROUGH THE STAND.E/C TO RECLAIM TO EX CONDITIONS. E/C TO REPLACE ALL THE DISTURBED STAND AND GRASS AREAS WITH MATCHING MATERIALS, BACKFILLING, AND SEEDING REQUIREMENTS THAT MEET NORTH DAKOTA PARKS AND RECREATION DEPARTMENT'S STANDARDS. MIXED GRAVEL/SAND/DIRT REPLACEMENT FILL MATERIAL WILL NOT BE ACCEPTED. E/C WILL BE REQUIRED TO SORT EX MATERIAL IF REUSED. E/C TO FIELD COORDINATE ALL REQUIREMENTS.

6

E/C TO ROUTE UNDERGROUND FEEDER PARALLEL WITH EX LOOP ROAD. E/C SHALL NOT DISTURB EX ROAD MATERIAL AND BE RESPONSIBLE TO REPAIR ANY DAMAGED ROAD MATERIAL.

7

E/C HAS THE OPTION TO BORE UNDER THE ROAD OR TRENCH THROUGH THE ROAD. E/C TO RECLAIM TO EX CONDITIONS. E/C TO REPLACE ALL THE DISTURBED ASPHALT ROADWAY, GRAVEL, AND GRASS AREAS WITH MATCHING MATERIALS, BACKFILLING, AND SEEDING REQUIREMENTS THAT MEET NORTH DAKOTA PARKS AND RECREATION DEPARTMENT'S STANDARDS. MIXED GRAVEL/SAND/DIRT REPLACEMENT FILL MATERIAL WILL NOT BE ACCEPTED. E/C WILL BE REQUIRED TO SORT EX MATERIAL IF REUSED. E/C TO FIELD COORDINATE ALL REQUIREMENTS.

8

E/C TO REFER TO 1/GI-E-501 FOR NEW SINGLE BACK-IN PEDESTAL LOCATION.

9

E/C TO REFER TO 5/GI-E-501 FOR NEW QUAD PEDESTAL LOCATIONS.

10

E/C TO REFER TO 6/GI-E-501 FOR NEW TRIPLE PEDESTAL LOCATIONS.

GENERAL NOTES:

1.

E/C TO PROVIDE ALL NEW PEDESTAL UNDERGROUND DIRECT BURY BRANCH FEEDERS WITHIN THE SAME TRENCH. FIELD COORDINATE EXACT LOCATION.

2.

E/C SHALL NOT REMOVE OR DISTURB ANY TREES OR SHRUBS WITHOUT OWNER APPROVAL. FIELD COORDINATE WITH OWNER.

3.

THE EX CONDITIONS HAVE BEEN SHOWN BASED ON CASUAL ON-SITE INVESTIGATION WITH NO GUARANTEE TO THEIR ACCURACY. CONTRACTOR TO BE RESPONSIBLE TO FIELD VERIFY EX CONDITIONS.

4.

E/C TO FIELD COORDINATE ALL WORK WITH OTHER TRADES.

5.

E/C TO FIELD COORDINATE WITH NORTHERN PLAINS ELECTRIC CO-OP (NPEC) FOR ALL UTILITY COORDINATION.  
NPEC CONTACT: KEVIN LARSON  
PHONE: 701-303-0868  
EMAIL: scotti@mwec.com

6.

E/C TO BE RESPONSIBLE FOR A NEW UTILITY ELECTRICAL CONNECTION COSTS.

7.

E/C TO REPLACE ALL THE DISTURBED STAND AND GRASS AREAS WITH MATCHING VEGETATION, MATERIALS, BACKFILLING, AND SEEDING REQUIREMENTS THAT MEET NORTH DAKOTA PARKS AND RECREATION DEPARTMENT'S STANDARDS. MIXED GRAVEL/SAND/DIRT REPLACEMENT FILL MATERIAL WILL NOT BE ACCEPTED. E/C WILL BE REQUIRED TO SORT EX MATERIAL IF REUSED. E/C TO COORDINATE ALL REQUIREMENTS WITH NORTH DAKOTA PARKS AND RECREATION DEPARTMENT.

8.

E/C TO REFER TO 4/GI-E-501 FOR ALL NEW PULL-THROUGH PEDESTAL LOCATIONS, UNLESS NOTED OTHERWISE.

FEEDER SCHEDULE:

1

NEW UNDERGROUND DIRECT BURY BRANCH FEEDER TRENCH. REFER TO ELECTRICAL WIRING DETAIL 9/GI-E-506 FOR CIRCUITING AND FEEDER SCHEDULE.

2

NEW UNDERGROUND DIRECT BURY BRANCH FEEDER TRENCH . REFER TO ELECTRICAL WIRING DETAIL 7/GI-E-505 FOR CIRCUITING AND FEEDER SCHEDULE.

3

NEW UTILITY FEEDERS. REFER TO ELECTRICAL IMPROVEMENT RISER DIAGRAM 4/GI-E-603.

4

NEW UNDERGROUND DIRECT BURY BRANCH FEEDER TRENCH. REFER TO ELECTRICAL WIRING DETAIL 8/GI-E-506 FOR CIRCUITING AND FEEDER SCHEDULE.

KEY PLAN:

ELECTRICAL IMPROVEMENT SITE PLAN - SOUTH HOWARD CAMPGROUND

SCALE: 1"=30'

0

30'

60'

DESIGNED BY:

ARH

DRAWN BY:

SDM

APPROVED BY:

MSV

DESIGN PROJ:

21219.000

CONST PROJ:

SCALE:

AS NOTED

DATE:

04-24-2023

DRAWING NO:

GI-E-114

SHEET NO:

18 of 32

REGISTERED PROFESSIONAL ENGINEER

MICHAEL VAN DUYN

PE-10724

DATE: 04/24/2023

NORTH DAKOTA

BY

DESCRIPTION

DATE

#

ELECTRICAL IMPROVEMENT SITE PLAN

SOUTH HOWARD CAMPGROUND

GRAHAM'S ISLAND STATE PARK

NORTH DAKOTA PARKS & RECREATION DEPARTMENT

ELECTRICAL UPGRADES

BISMARCK, NORTH DAKOTA


3456 E CENTURY AVENUE - BISMARCK, ND 58503

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Last edit on: 4/21/2023 12:25 PM by: SDW01521 Drawing Name: F:\Proj\21000\21219\21219.000\AutoCad\Plan Set\Graham's Island\21219.000E - Electrical Improvement Site Plans - GISP.dwg Layout Name: N\_ZIEBACH IMPRV. SITE PLAN Plotted By: SDW01521 Plotted on: 4/24/2023 2:21:39 PM



GENERAL NOTES:

- E/C TO PROVIDE ALL NEW PEDESTAL UNDERGROUND DIRECT BURY BRANCH FEEDERS WITHIN THE SAME TRENCH. FIELD COORDINATE EXACT LOCATION.
- E/C TO PROVIDE NEW 20 AMP/1P GFI CIRCUIT BREAKER AND 20 AMP/1P RECEPTACLE WITHIN ALL EX PEDESTALS, UNLESS NOTED OTHERWISE.
- E/C SHALL NOT REMOVE OR DISTURB ANY TREES OR SHRUBS WITHOUT OWNER APPROVAL. FIELD COORDINATE WITH OWNER.
- THE EX CONDITIONS HAVE BEEN SHOWN BASED ON CASUAL ON-SITE INVESTIGATION WITH NO GUARANTEE TO THEIR ACCURACY, CONTRACTOR TO BE RESPONSIBLE TO FIELD VERIFY EX CONDITIONS.
- E/C TO FIELD COORDINATE ALL WORK WITH OTHER TRADES.
- E/C TO FIELD COORDINATE WITH NORTHERN PLAINS ELECTRIC CO-OP (NPEC) FOR ALL UTILITY COORDINATION.  
NPEC CONTACT: KEVIN LARSON  
PHONE: 701-303-0868  
EMAIL: scotti@mwec.com
- E/C TO BE RESPONSIBLE FOR A NEW UTILITY ELECTRICAL CONNECTION COSTS.
- E/C TO REPLACE ALL THE DISTURBED STAND AND GRASS AREAS WITH MATCHING VEGETATION, MATERIALS, BACKFILLING, AND SEEDING REQUIREMENTS THAT MEET NORTH DAKOTA PARKS AND RECREATION DEPARTMENT'S STANDARDS. E/C TO COORDINATE ALL REQUIREMENTS WITH NORTH DAKOTA PARKS AND RECREATION DEPARTMENT.
- E/C TO REFER TO 4/GI-E-501 FOR ALL NEW PULL-THROUGH PEDESTAL LOCATIONS, UNLESS NOTED OTHERWISE.

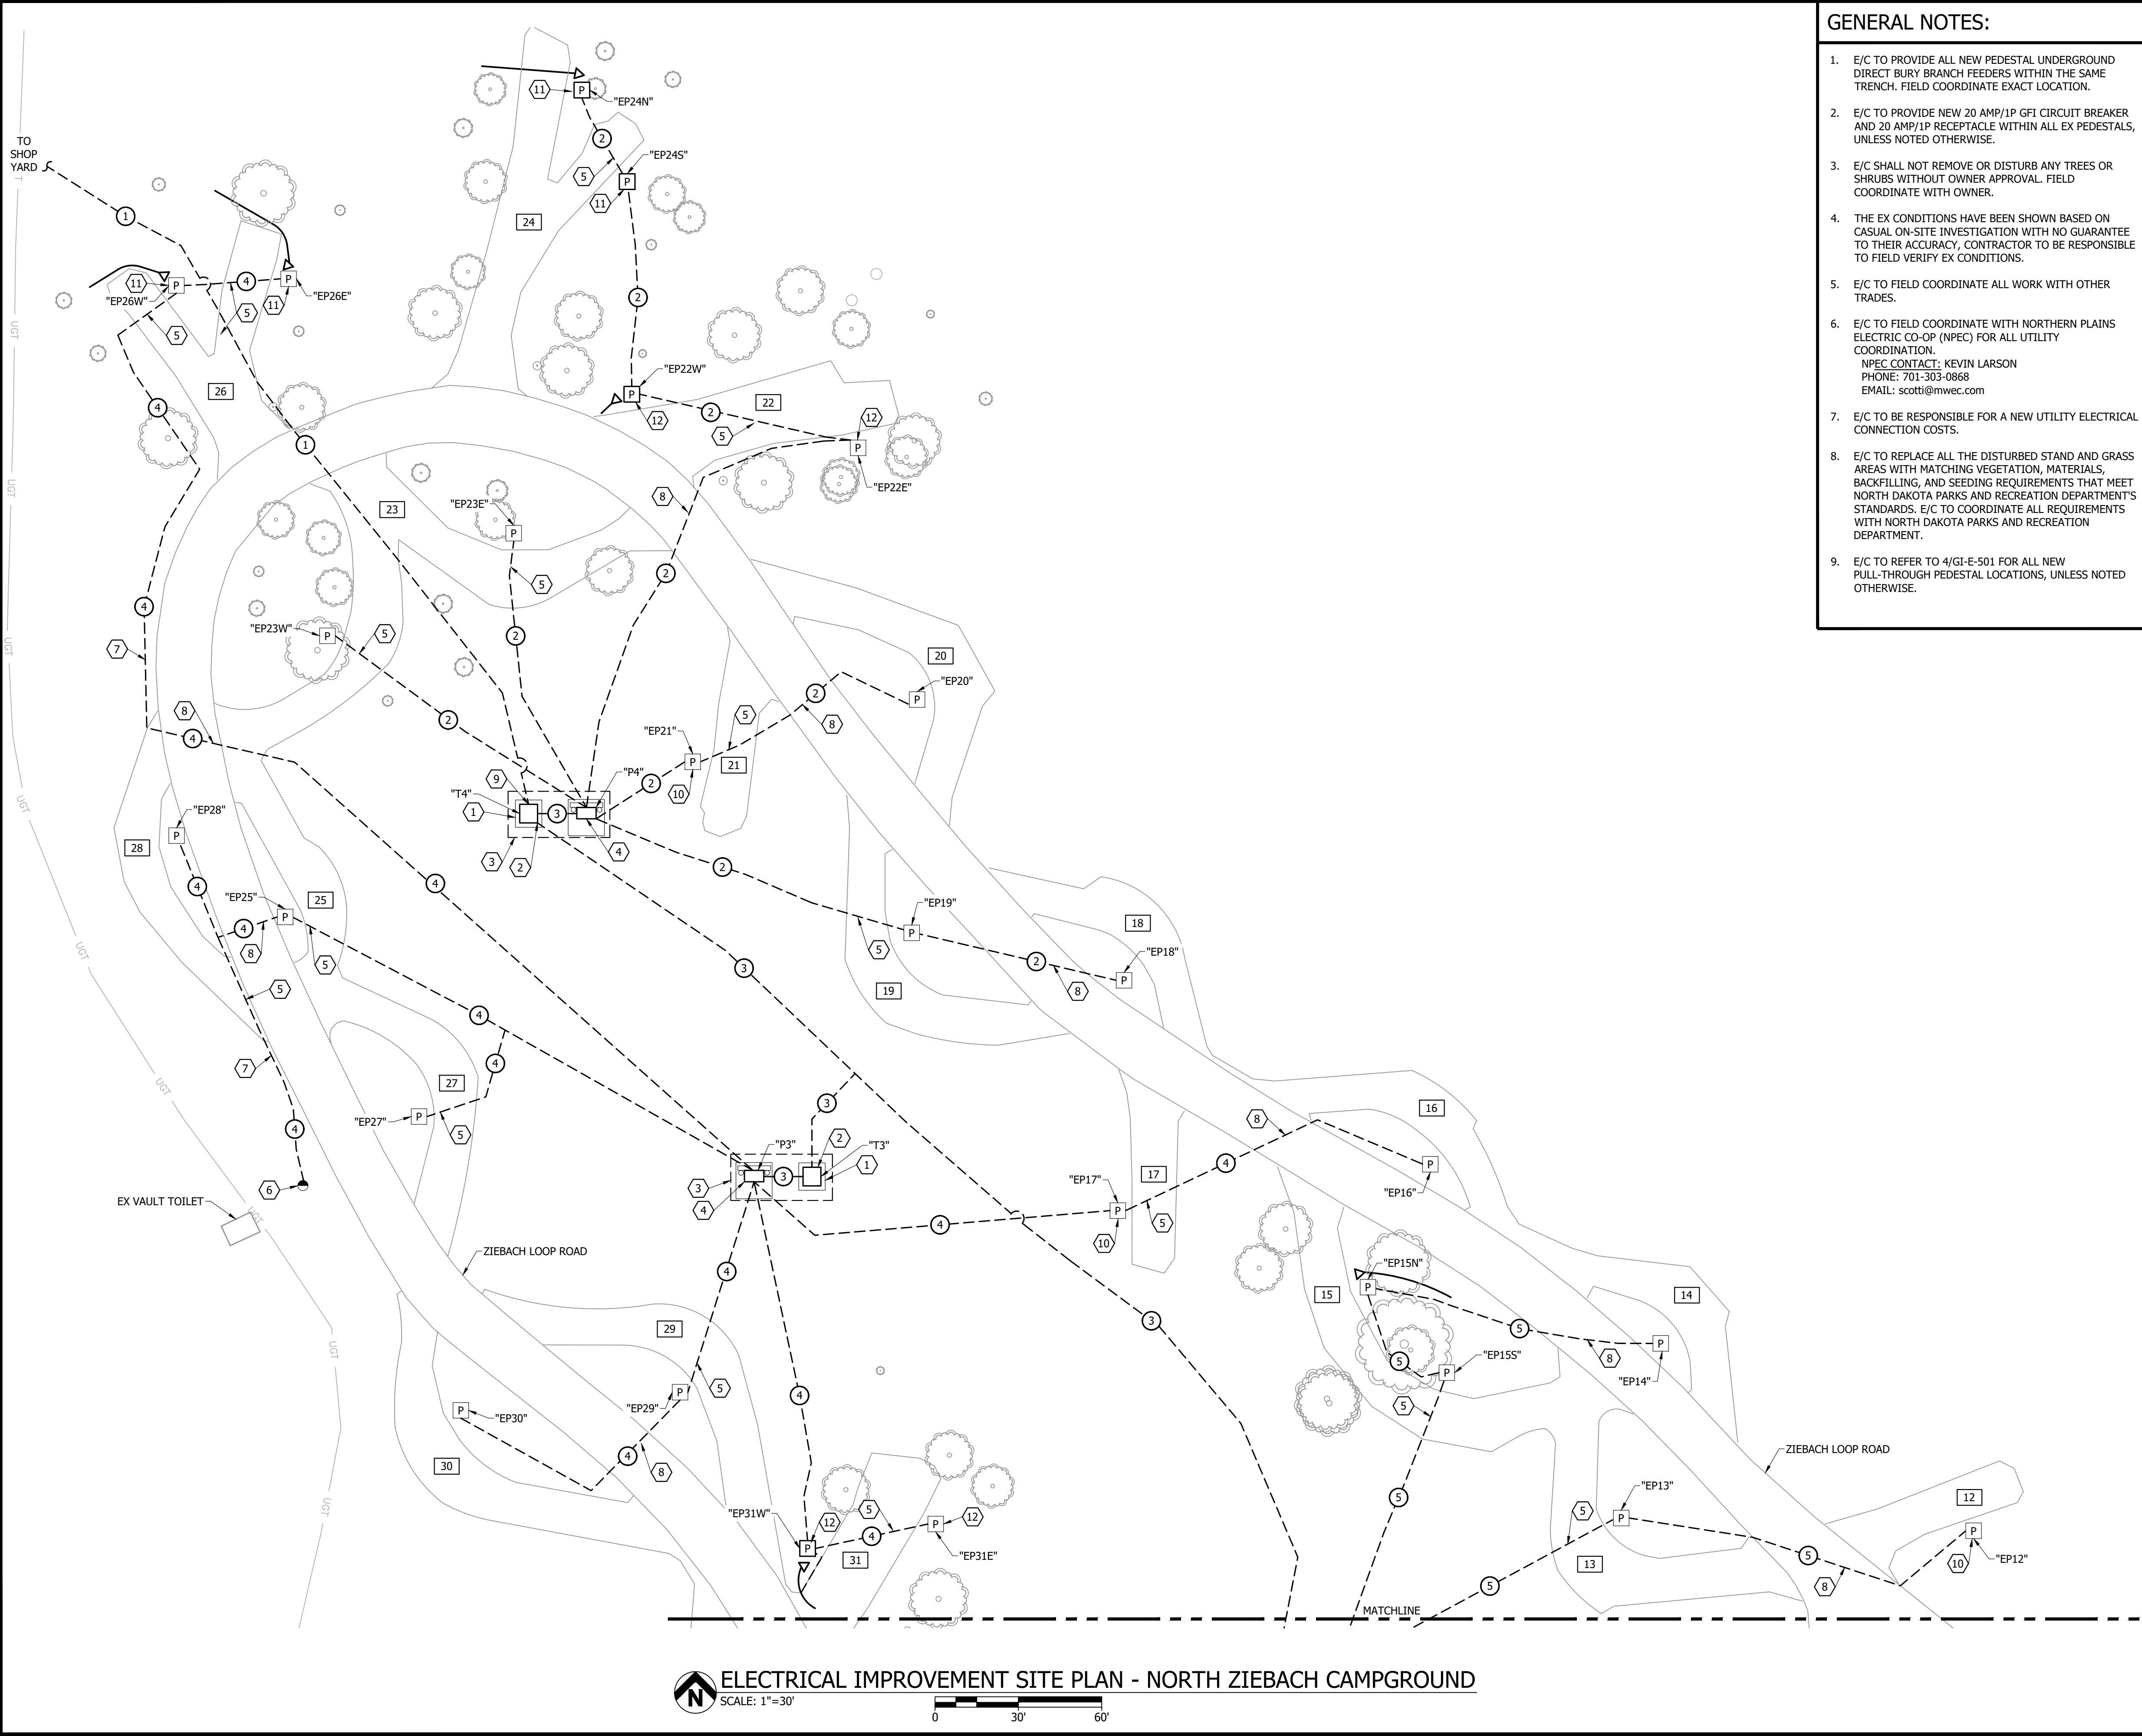
REFERENCE NOTES:

- E/C TO PROVIDE NEW UTILITY TRANSFORMER CONCRETE EQUIPMENT PAD. E/C TO FIELD VERIFY EXACT LOCATION AND COORDINATE ALL REQUIREMENTS WITH ELECTRIC UTILITY.
- NEW UTILITY TRANSFORMER PROVIDED BY ELECTRIC UTILITY. E/C TO COORDINATE EXACT CONNECTION REQUIREMENTS WITH ELECTRIC UTILITY.
- REFER TO ELECTRICAL IMPROVEMENT RISER DIAGRAM DETAIL 3/GI-E-603.
- NEW 600 AMP, 120/240 VOLT, 1 PHASE, 3 WIRE PANELBOARD. REFER TO PANELBOARD SCHEDULE ON SHEET GI-E-602.
- E/C HAS THE OPTION TO BORE UNDER THE STAND (RV GRAVEL PAD) OR TRENCH THROUGH THE STAND. E/C TP RECLAIM TO EX CONDITIONS. E/C TO REPLACE ALL THE DISTURBED STAND AND GRASS AREAS WITH MATCHING MATERIALS, BACKFILLING, AND SEEDING REQUIREMENTS THAT MEET NORTH DAKOTA PARKS AND RECREATION DEPARTMENT'S STANDARDS. MIXED GRAVEL/SAND/DIRT REPLACEMENT FILL MATERIAL WILL NOT BE ACCEPTED. E/C WILL BE REQUIRED TO SORT EX MATERIAL IF REUSED. E/C TO FIELD COORDINATE ALL REQUIREMENTS.
- E/C TO CONNECT NEW FEEDER WIRE AND CONDUIT TO EX POLE MOUNTED LIGHTING FIXTURE. ALL EXPOSED FEEDER WIRE TO BE IN RIGID CONDUIT PAINTED TO MATCH EX POLE FINISH. FIELD VERIFY EXACT REQUIREMENTS.
- E/C TO ROUTE UNDERGROUND FEEDER PARALLEL WITH EX LOOP ROAD. E/C SHALL NOT DISTURB EX ROAD MATERIAL AND BE RESPONSIBLE TO REPAIR ANY DAMAGED ROAD MATERIAL.
- E/C HAS THE OPTION TO BORE UNDER THE ROAD OR TRENCH THROUGH THE ROAD. E/C TO RECLAIM TO EX CONDITIONS. E/C TO REPLACE ALL THE DISTURBED ASPHALT ROADWAY, GRAVEL, AND GRASS AREAS WITH MATCHING MATERIALS, BACKFILLING, AND SEEDING REQUIREMENTS THAT MEET NORTH DAKOTA PARKS AND RECREATION DEPARTMENT'S STANDARDS. MIXED GRAVEL/SAND/DIRT REPLACEMENT FILL MATERIAL WILL NOT BE ACCEPTED. E/C WILL BE REQUIRED TO SORT EX MATERIAL IF REUSED. E/C TO FIELD COORDINATE ALL REQUIREMENTS.
- UTILITY TO INTERCEPT AND EXTEND EX UNDERGROUND MEDIUM VOLTAGE FEEDER AND CONDUIT AND RECONNECT TO NEW "T4". FIELD COORDINATE WITH E/C.
- E/C TO REFER TO 1/GI-E-501 FOR NEW SINGLE BACK-IN PEDESTAL LOCATION.
- E/C TO REFER TO 3/GI-E-501 FOR NEW DOUBLE BACK-IN PEDESTAL LOCATIONS.
- E/C TO REFER TO 2/GI-E-501 FOR NEW PULL-IN AND BACK-IN PEDESTAL LOCATIONS.


FEEDER SCHEDULE:

- EX UNDERGROUND DIRECT BURY MAIN FEEDER TO REMAIN.
- NEW UNDERGROUND DIRECT BURY BRANCH FEEDER TRENCH. REFER TO ELECTRICAL WIRING DETAIL 14/GI-E-509 FOR CIRCUITING AND FEEDER SCHEDULE.
- NEW UTILITY FEEDERS. REFER TO ELECTRICAL IMPROVEMENT RISER DIAGRAM 3/GI-E-603.
- NEW UNDERGROUND DIRECT BURY BRANCH FEEDER TRENCH. REFER TO ELECTRICAL WIRING DETAIL 13/GI-E-508 FOR CIRCUITING AND FEEDER SCHEDULE.
- NEW UNDERGROUND DIRECT BURY BRANCH FEEDER TRENCH. REFER TO ELECTRICAL WIRING DETAIL 12/GI-E-508 FOR CIRCUITING AND FEEDER SCHEDULE.

KEY PLAN:

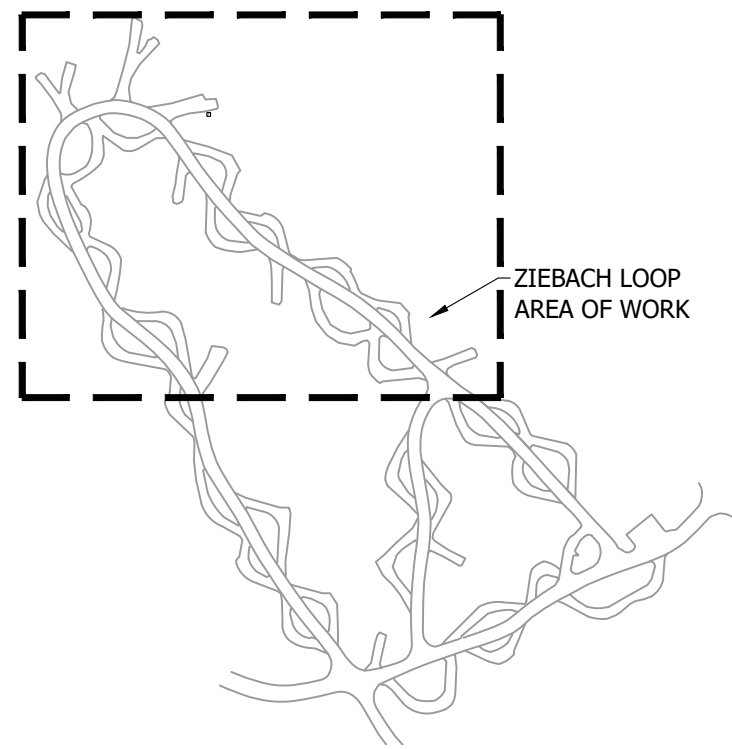

ELECTRICAL IMPROVEMENT SITE PLAN  
NORTH ZIEBACH CAMPGROUND  
GRAHAM'S ISLAND STATE PARK  
NORTH DAKOTA PARKS & RECREATION DEPARTMENT  
ELECTRICAL UPGRADES  
BISMARCK, NORTH DAKOTA

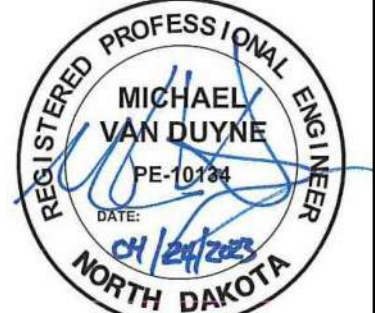

DESIGNED BY:	ARH
DRAWN BY:	SDM
APPROVED BY:	MSV
DESIGN PROJ:	21219.000
CONST PROJ:	
SCALE:	AS NOTED
DATE:	04-24-2023
DRAWING NO:	GI-E-115
SHEET NO:	19 of 32

3456 E CENTURY AVENUE - BISMARCK, ND 58503  
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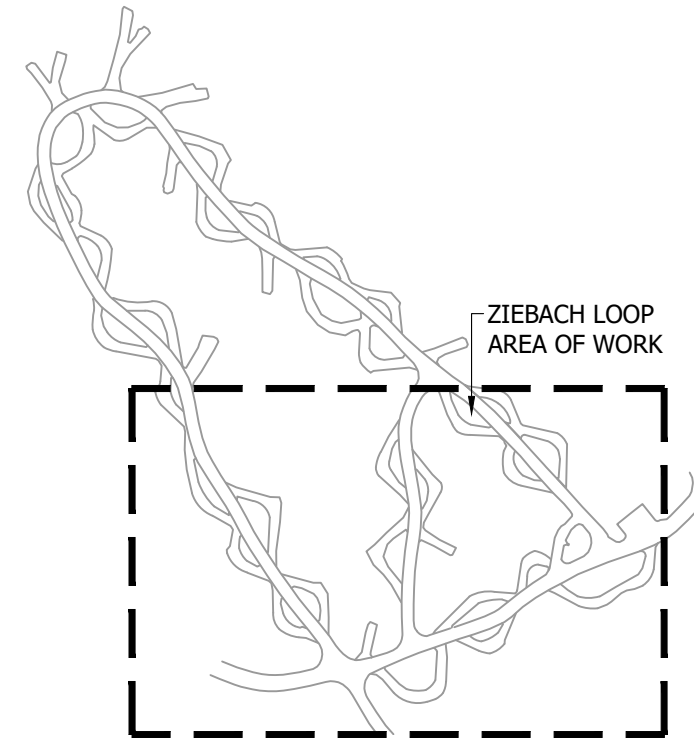
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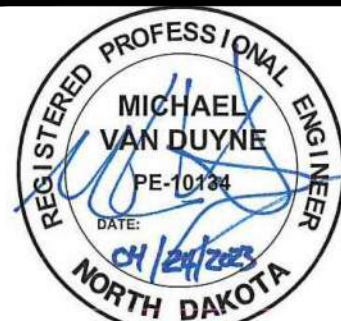
### REFERENCE NOTES:

- ① E/C TO PROVIDE NEW UTILITY TRANSFORMER. CONCRETE EQUIPMENT PAD, E/C TO FIELD VERIFY EXACT LOCATION AND COORDINATE ALL REQUIREMENTS WITH ELECTRIC UTILITY.
- ② NEW UTILITY TRANSFORMER PROVIDED BY ELECTRIC UTILITY. E/C TO COORDINATE EXACT CONNECTION REQUIREMENTS WITH ELECTRIC UTILITY.
- ③ REFER TO ELECTRICAL IMPROVEMENT RISER DIAGRAM DETAIL 3/GI-E-603.
- ④ NEW 600 AMP, 120/240 VOLT, 1 PHASE, 3 WIRE PANELBOARD. REFER TO PANELBOARD SCHEDULE ON SHEET GI-E-602.
- ⑤ E/C HAS THE OPTION TO BORE UNDER THE STAND (RV GRAVEL PAD) OR TRENCH THROUGH THE STAND. E/C TO RECLAIM TO EX CONDITIONS. E/C TO REPLACE ALL THE DISTURBED STAND AND GRASS AREAS WITH MATCHING MATERIALS, BACKFILLING, AND SEEDING REQUIREMENTS THAT MEET NORTH DAKOTA PARKS AND RECREATION DEPARTMENT'S STANDARDS. MIXED GRAVEL/SAND/DIRT REPLACEMENT FILL MATERIAL WILL NOT BE ACCEPTED. E/C WILL BE REQUIRED TO SORT EX MATERIAL IF REUSED. E/C TO FIELD COORDINATE ALL REQUIREMENTS.
- ⑥ E/C TO CONNECT NEW FEEDER WIRE AND CONDUIT TO EX LIFT STATION PANELBOARD. PROVIDE NEW LABEL "P13" FOR EXISTING PANELBOARD. REFER TO ELECTRICAL IMPROVEMENT RISER DIAGRAM DETAIL 3/GI-E-603.
- ⑦ E/C TO CONNECT NEW FEEDER WIRE AND CONDUIT TO EX COMFORT STATION PANELBOARD. PROVIDE NEW LABEL "P12" FOR EXISTING PANELBOARD. REFER TO ELECTRICAL IMPROVEMENT RISER DIAGRAM DETAIL 3/GI-E-603.
- ⑧ E/C TO CONNECT NEW FEEDER WIRE AND CONDUIT TO EX POLE MOUNTED LIGHTING FIXTURE. ALL EXPOSED FEEDER WIRE TO BE IN RIGID CONDUIT PAINTED TO MATCH EX POLE FINISH. FIELD VERIFY EXACT REQUIREMENTS.
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- ⑪ ALTERNATE BID 1: E/C TO PROVIDE NEW METER. E/C TO FIELD COORDINATE WITH OWNER ON ALL REQUIREMENTS.
- ⑫ E/C TO REFER TO 1/GI-E-501 FOR NEW SINGLE BACK-IN PEDESTAL LOCATION.


1. E/C TO PROVIDE ALL NEW PEDESTAL UNDERGROUND DIRECT BURY BRANCH FEEDERS WITHIN THE SAME TRENCH. FIELD COORDINATE EXACT LOCATION.
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5. E/C TO FIELD COORDINATE ALL WORK WITH OTHER TRADES.
6. E/C TO FIELD COORDINATE WITH NORTHERN PLAINS ELECTRIC CO-OP (NPEC) FOR ALL UTILITY COORDINATION:  
NPEC CONTACT: KEVIN LARSON  
PHONE: 701-303-0968  
EMAIL: scotti@mwecc.com
7. E/C TO BE RESPONSIBLE FOR A NEW UTILITY ELECTRICAL CONNECTION COSTS.
8. E/C TO REPLACE ALL THE DISTURBED STAND AND GRASS WITH MATCHING VEGETATION, MATERIALS, BACKFILLING, AND SEEDING REQUIREMENTS THAT MEET NORTH DAKOTA PARKS AND RECREATION DEPARTMENT'S STANDARDS.
9. MIXED GRAVEL/SAND/DIRT REPLACEMENT FILL MATERIAL WILL NOT BE ACCEPTED. E/C WILL BE REQUIRED TO SORT EX MATERIAL IF REQUIRED. E/C TO COORDINATE ALL REQUIREMENTS WITH NORTH DAKOTA PARKS AND RECREATION DEPARTMENT.
10. E/C TO REFER TO 4/GI-E-501 FOR ALL NEW PULL-THROUGH PEDESTAL LOCATIONS, UNLESS NOTED OTHERWISE.




**ELECTRICAL IMPROVEMENT SITE PLAN**  
**SOUTH ZIEBACH CAMPGROUND**  
**GRAHAMS ISLAND STATE PARK**  
NORTH DAKOTA PARKS & RECREATION DEPARTMENT  
ELECTRICAL UPGRADES  
BISMARCK, NORTH DAKOTA




DESIGNED BY:	ARF
DRAWN BY:	SDM
APPROVED BY:	MSV
DESIGN PROJ:	21219.000
CONST PROJ:	
SCALE:	AS NOTED
DATE:	04-24-2023
DRAWING NO:	<b>GI-E-116</b>
SHEET NO:	

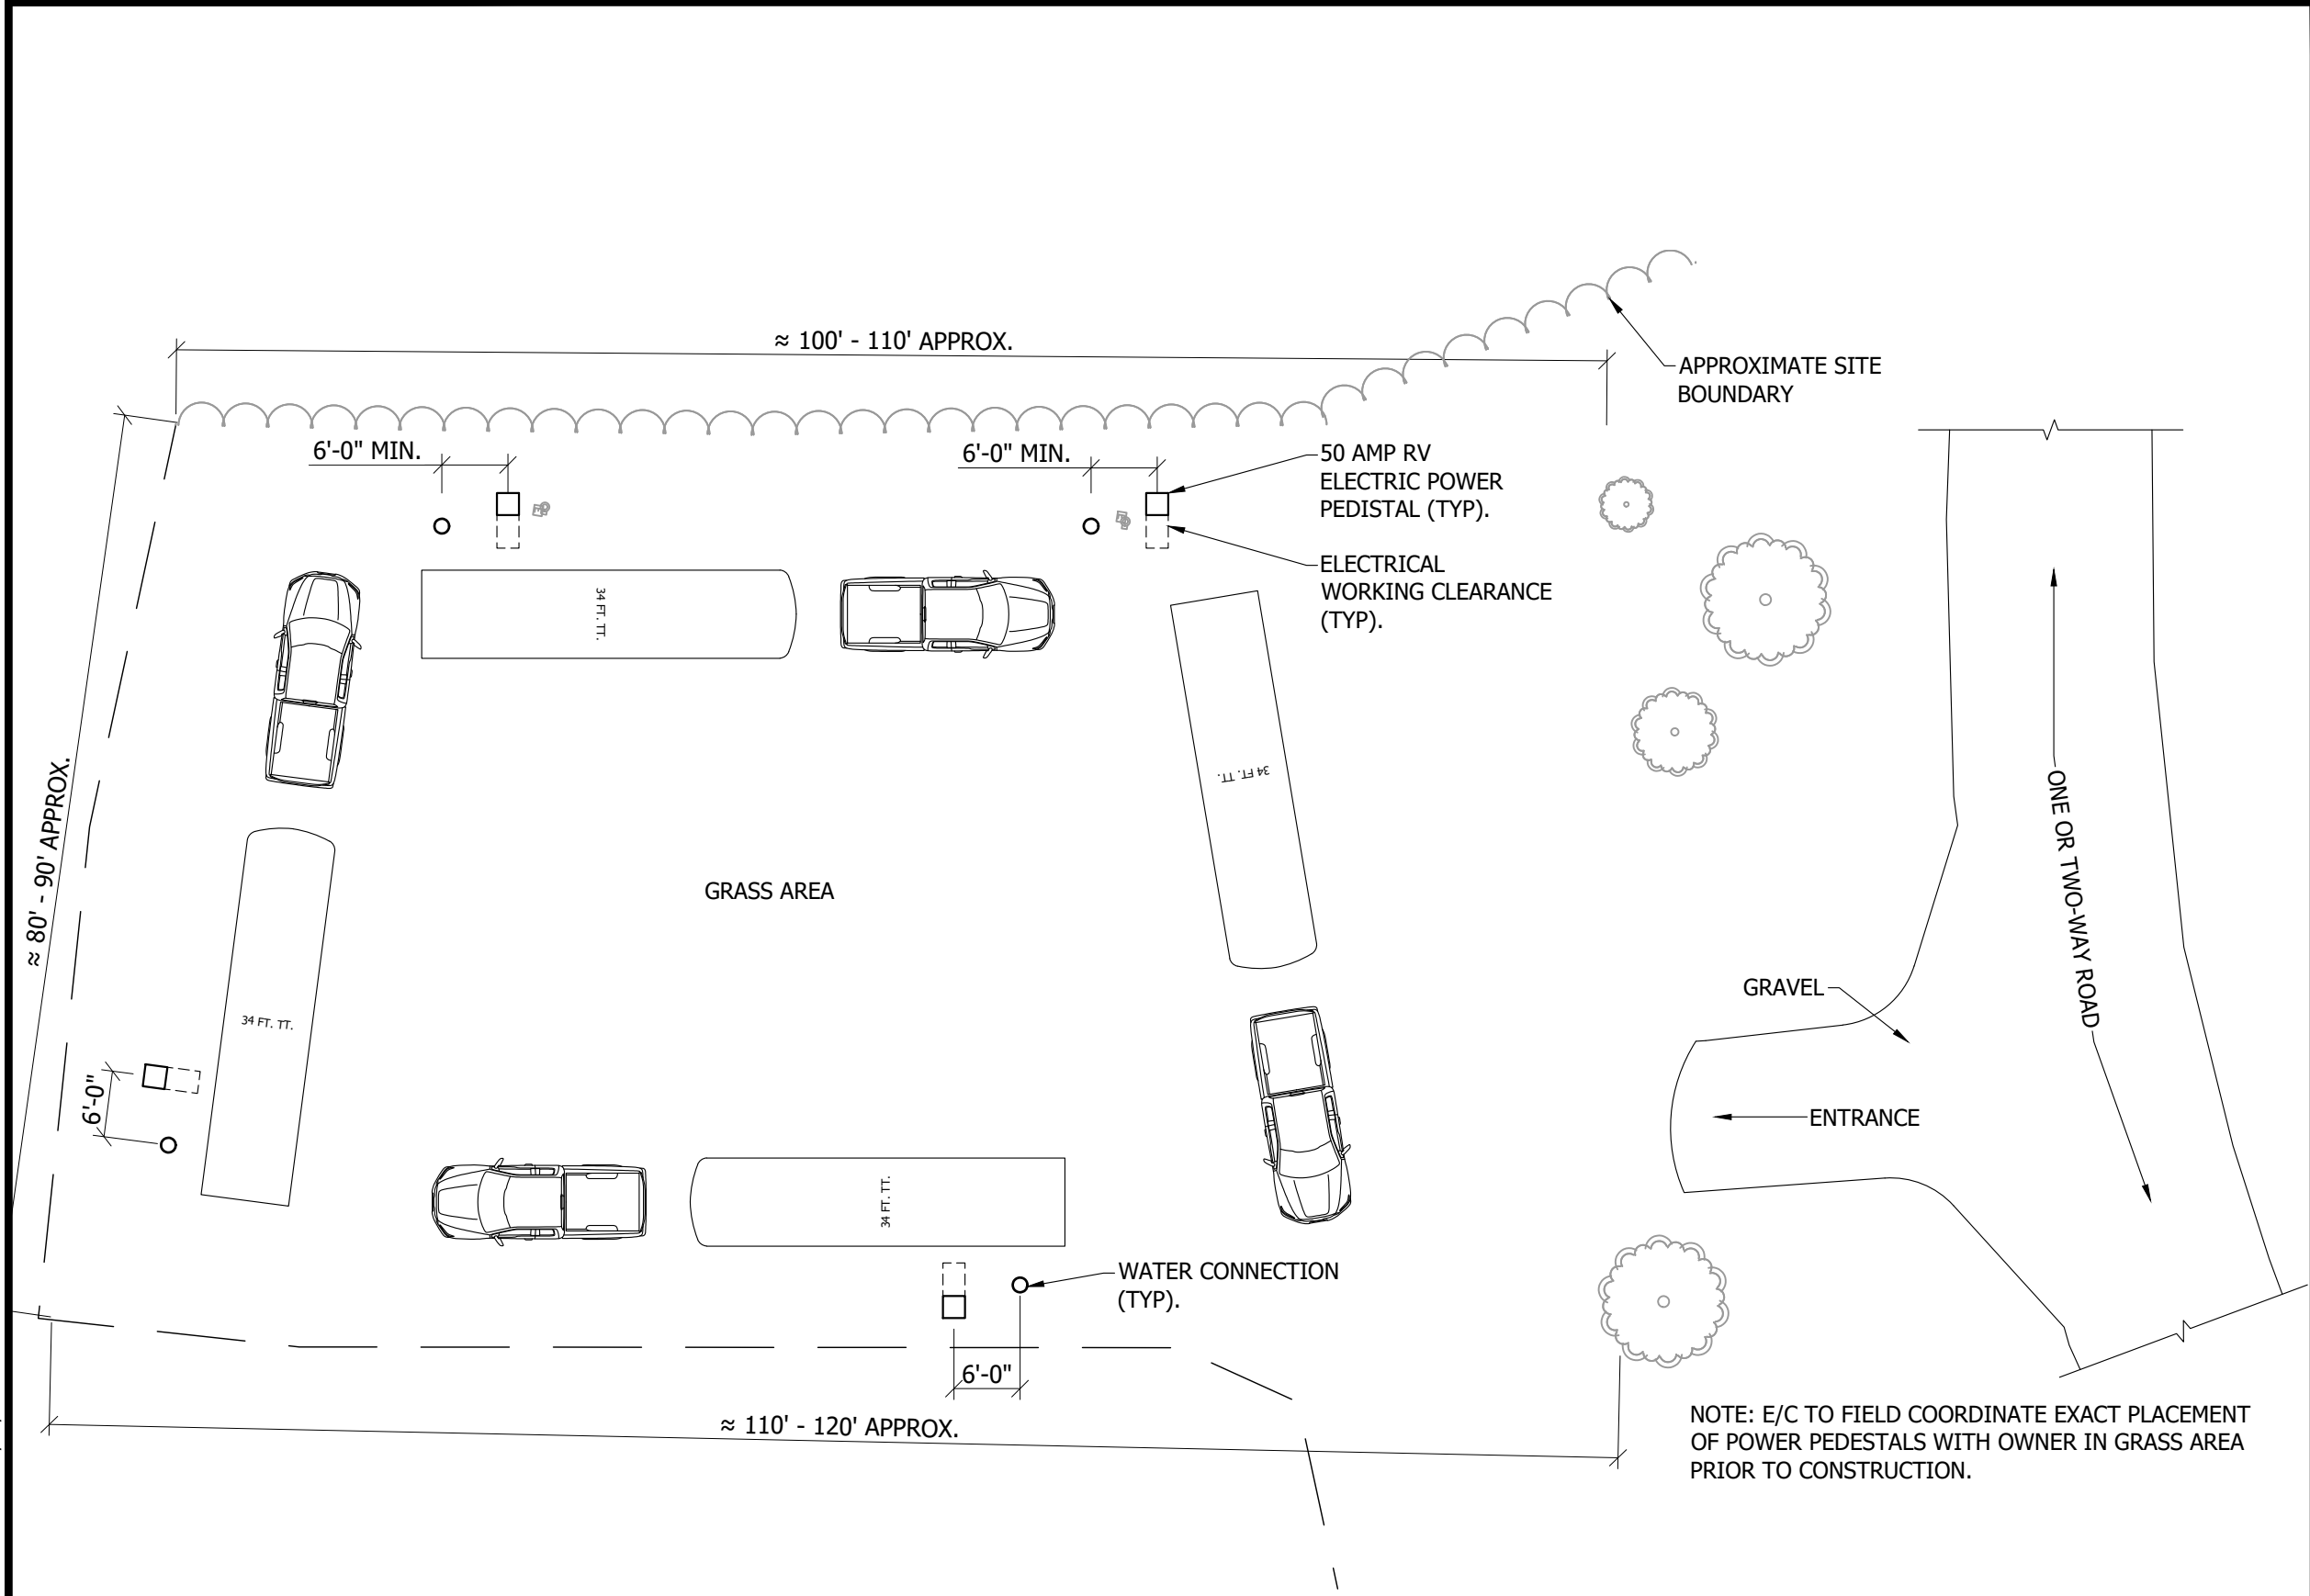


5 GRAHAMS ISLAND  
QUAD PULL-THRU/BACK-IN SITE DETAIL  
NOT TO SCALE

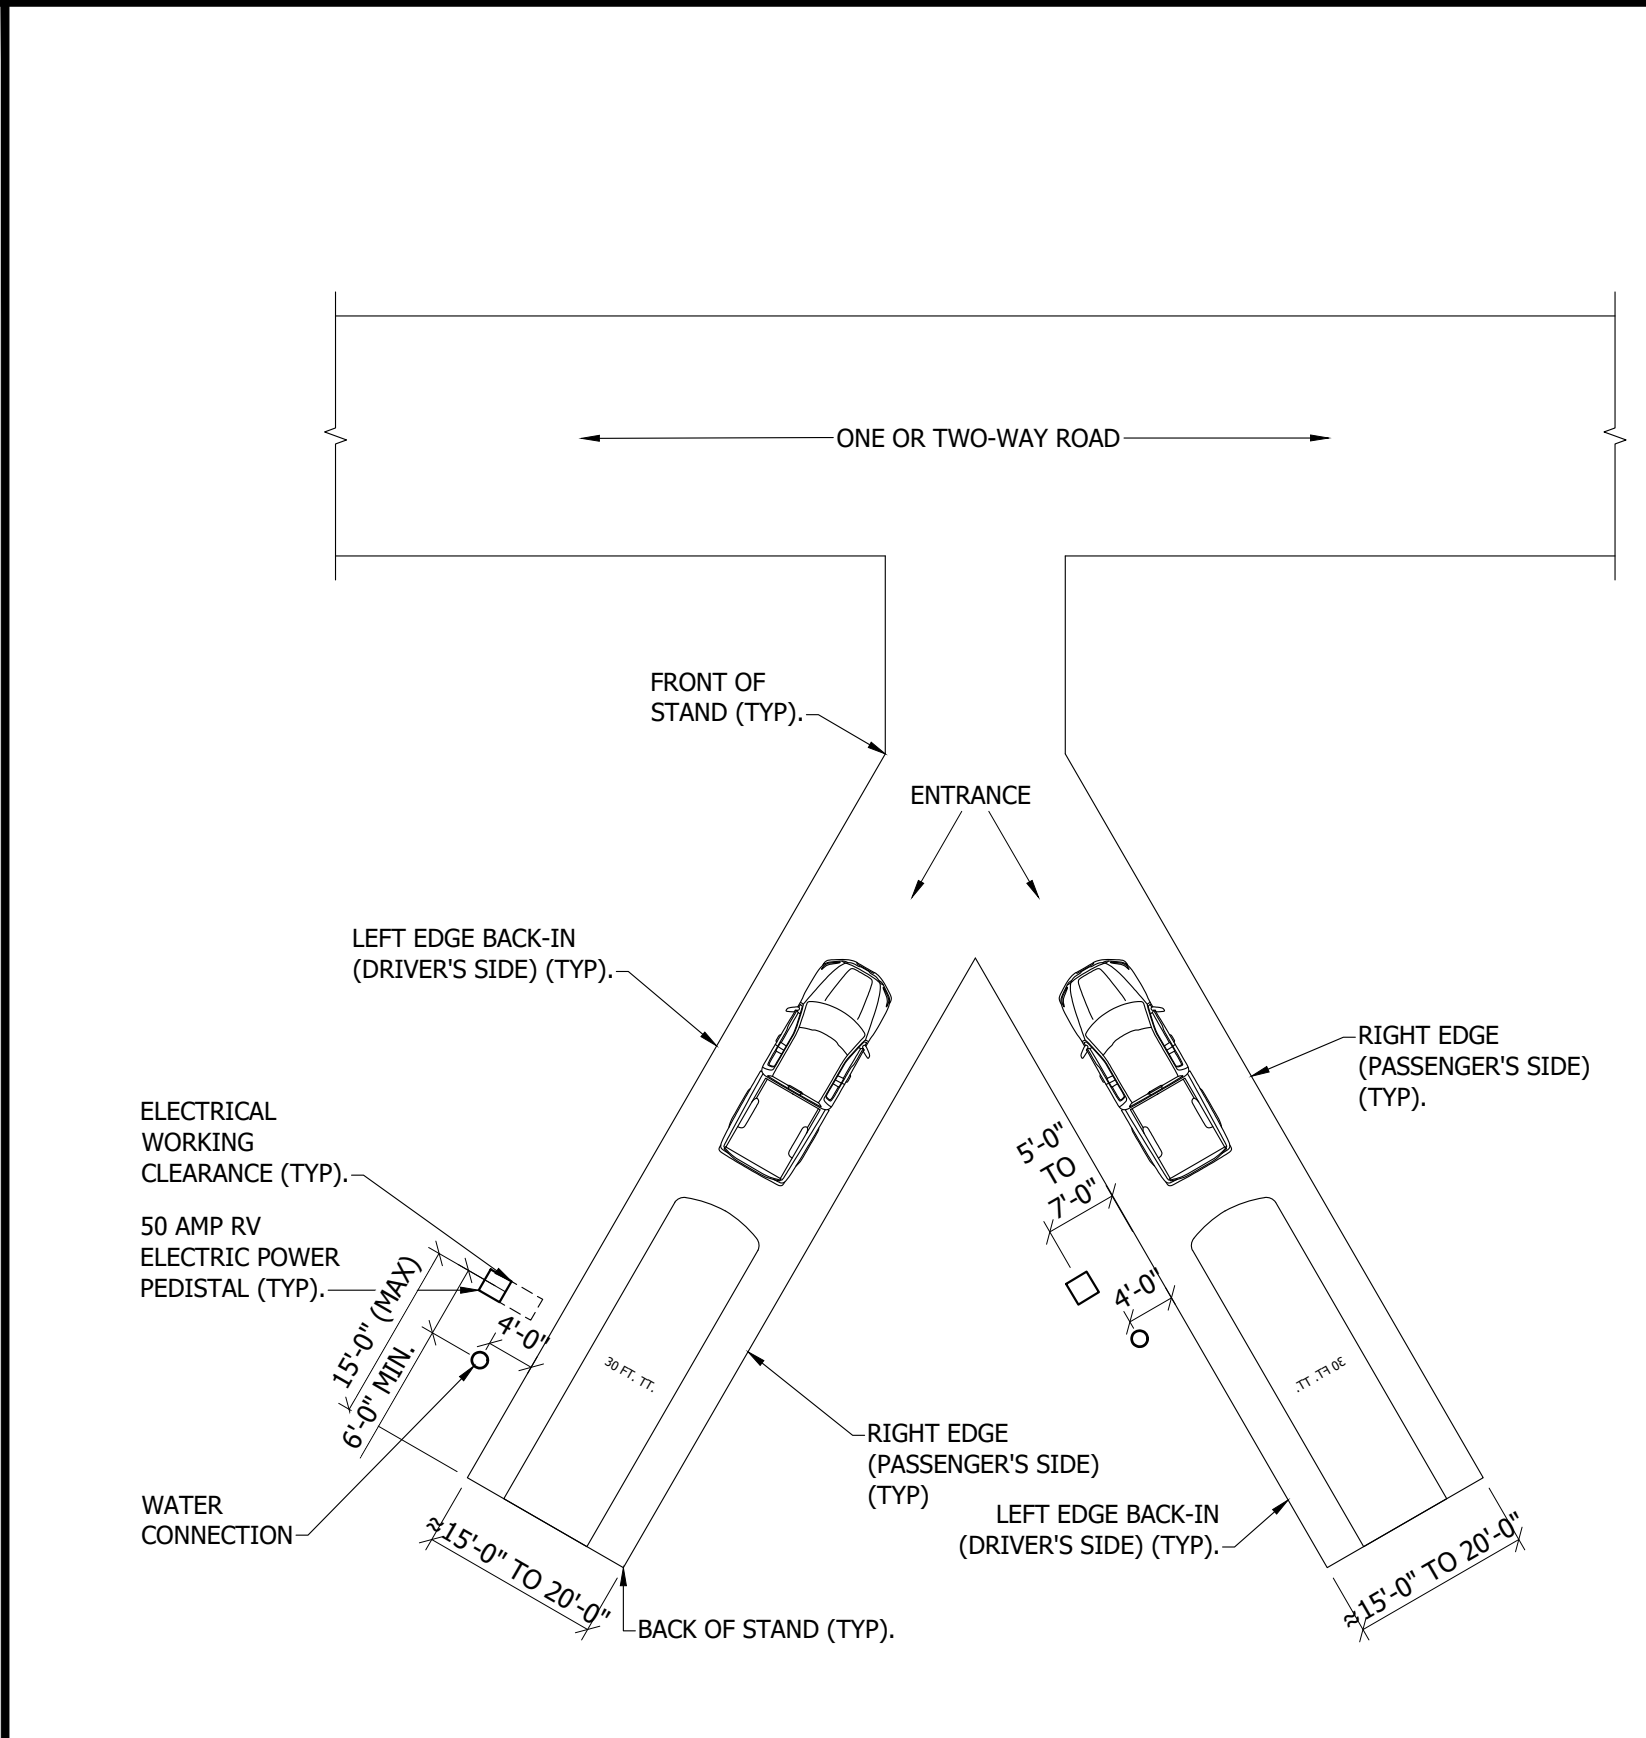


3 GRAHAMS ISLAND  
DOUBLE BACK-IN SITE DETAIL  
NOT TO SCALE

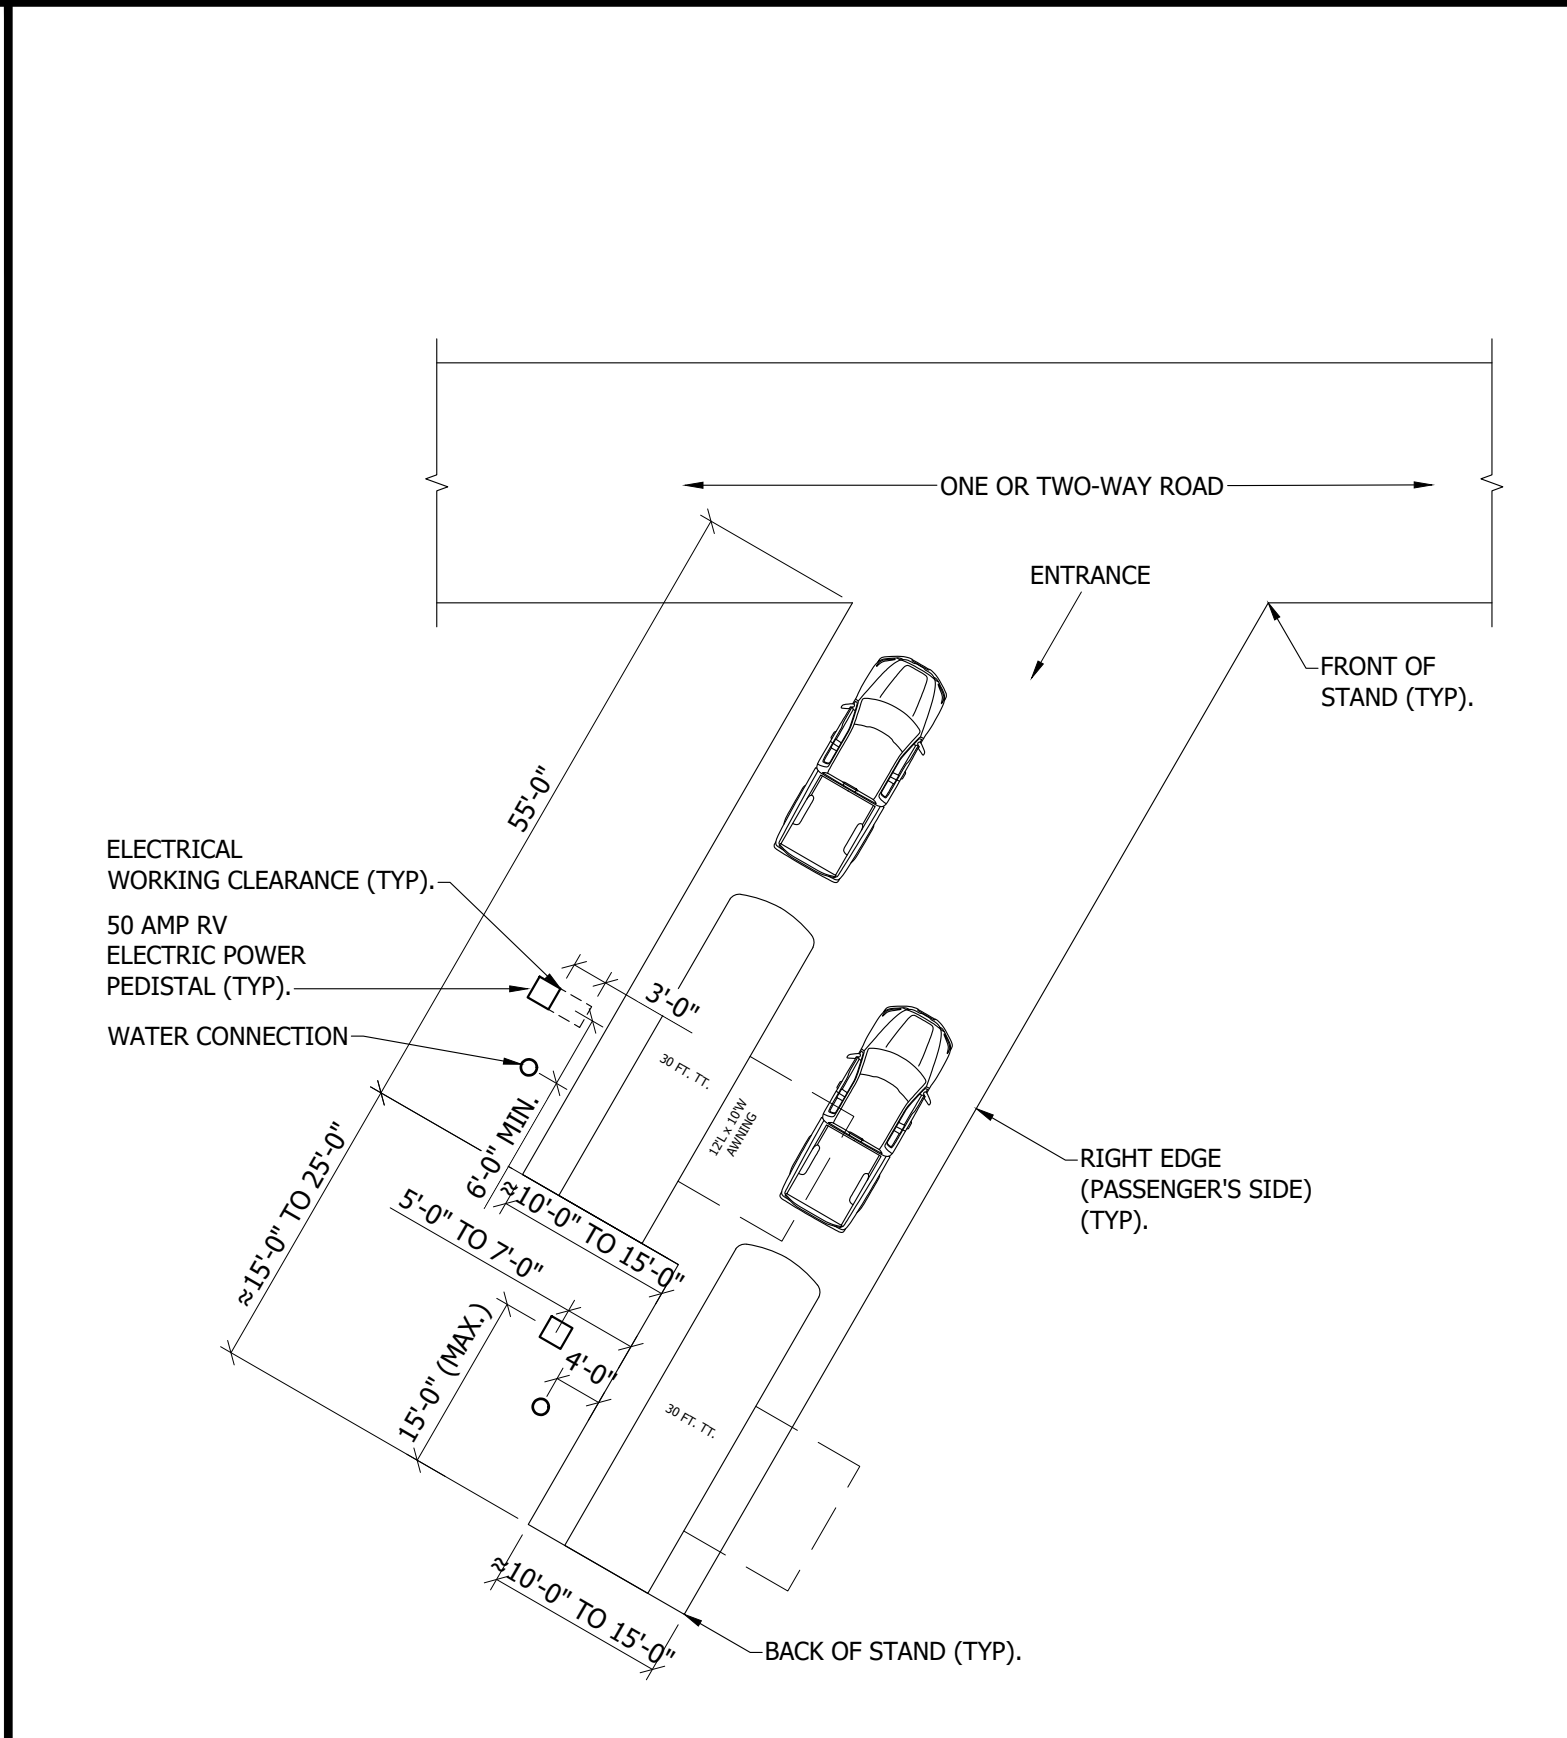


1 GRAHAMS ISLAND  
DOUBLE BACK-IN SITE DETAIL  
NOT TO SCALE

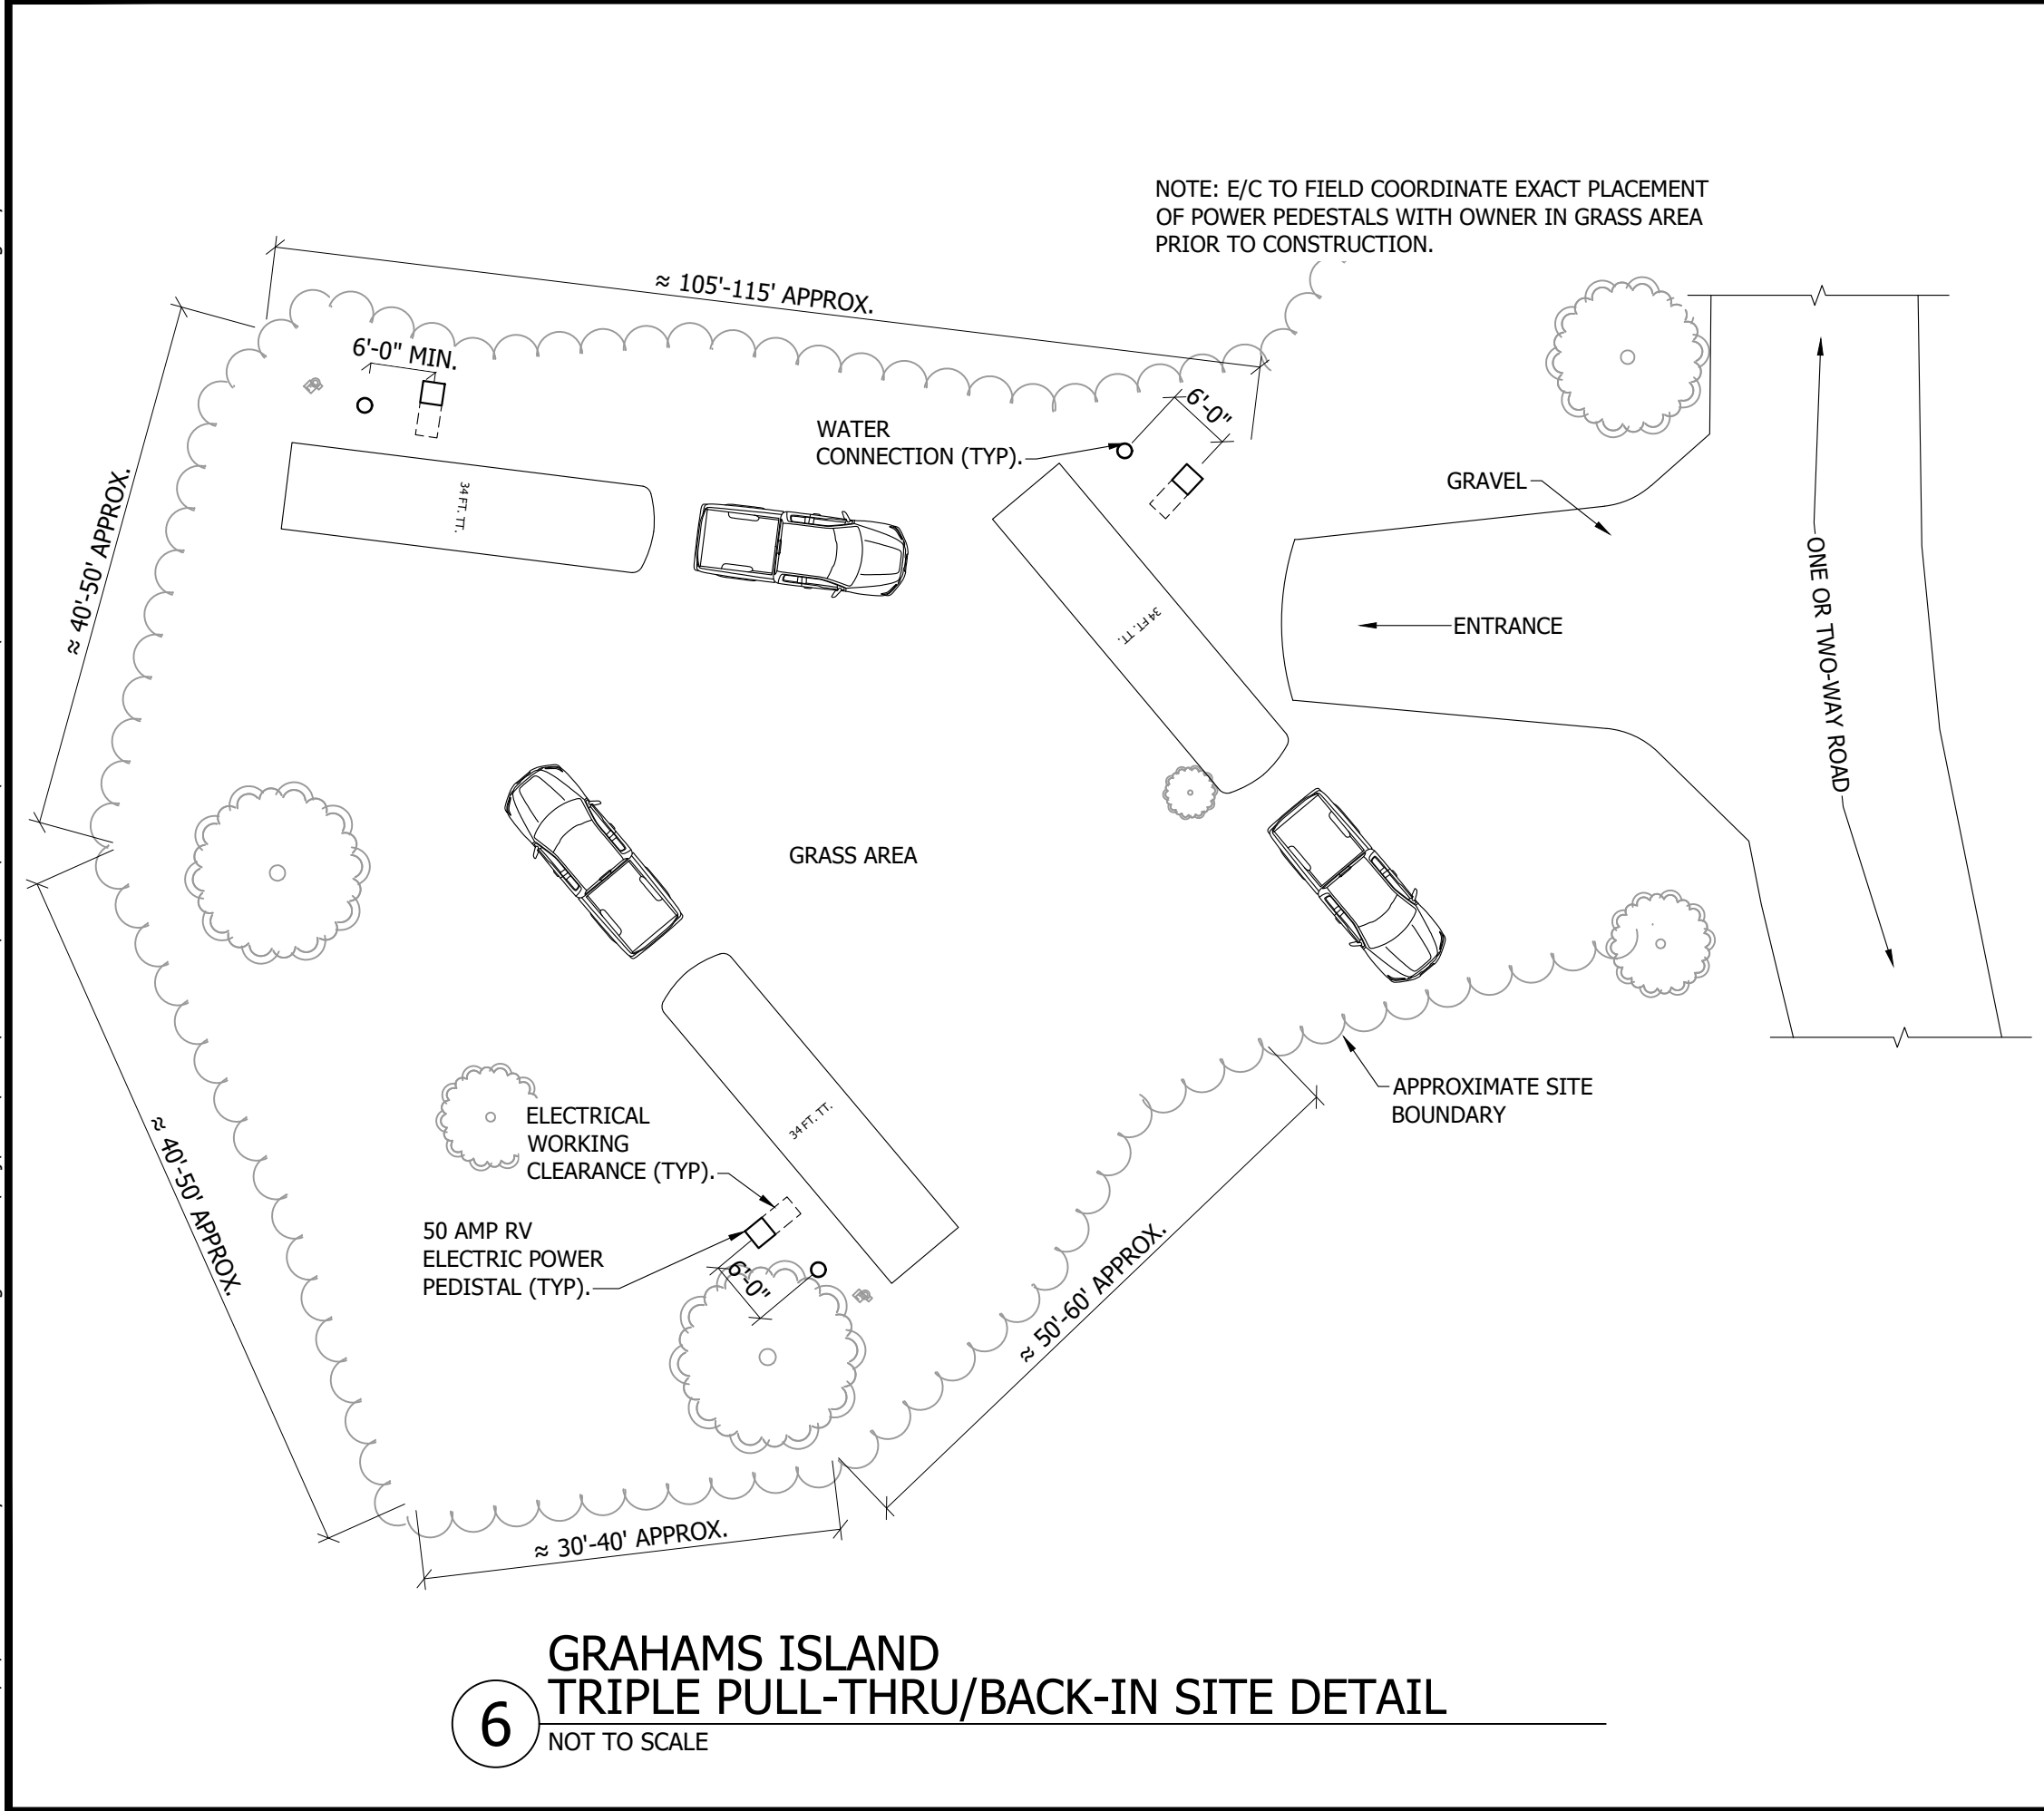

6 GRAHAMS ISLAND  
TRIPLE PULL-THRU/BACK-IN SITE DETAIL  
NOT TO SCALE

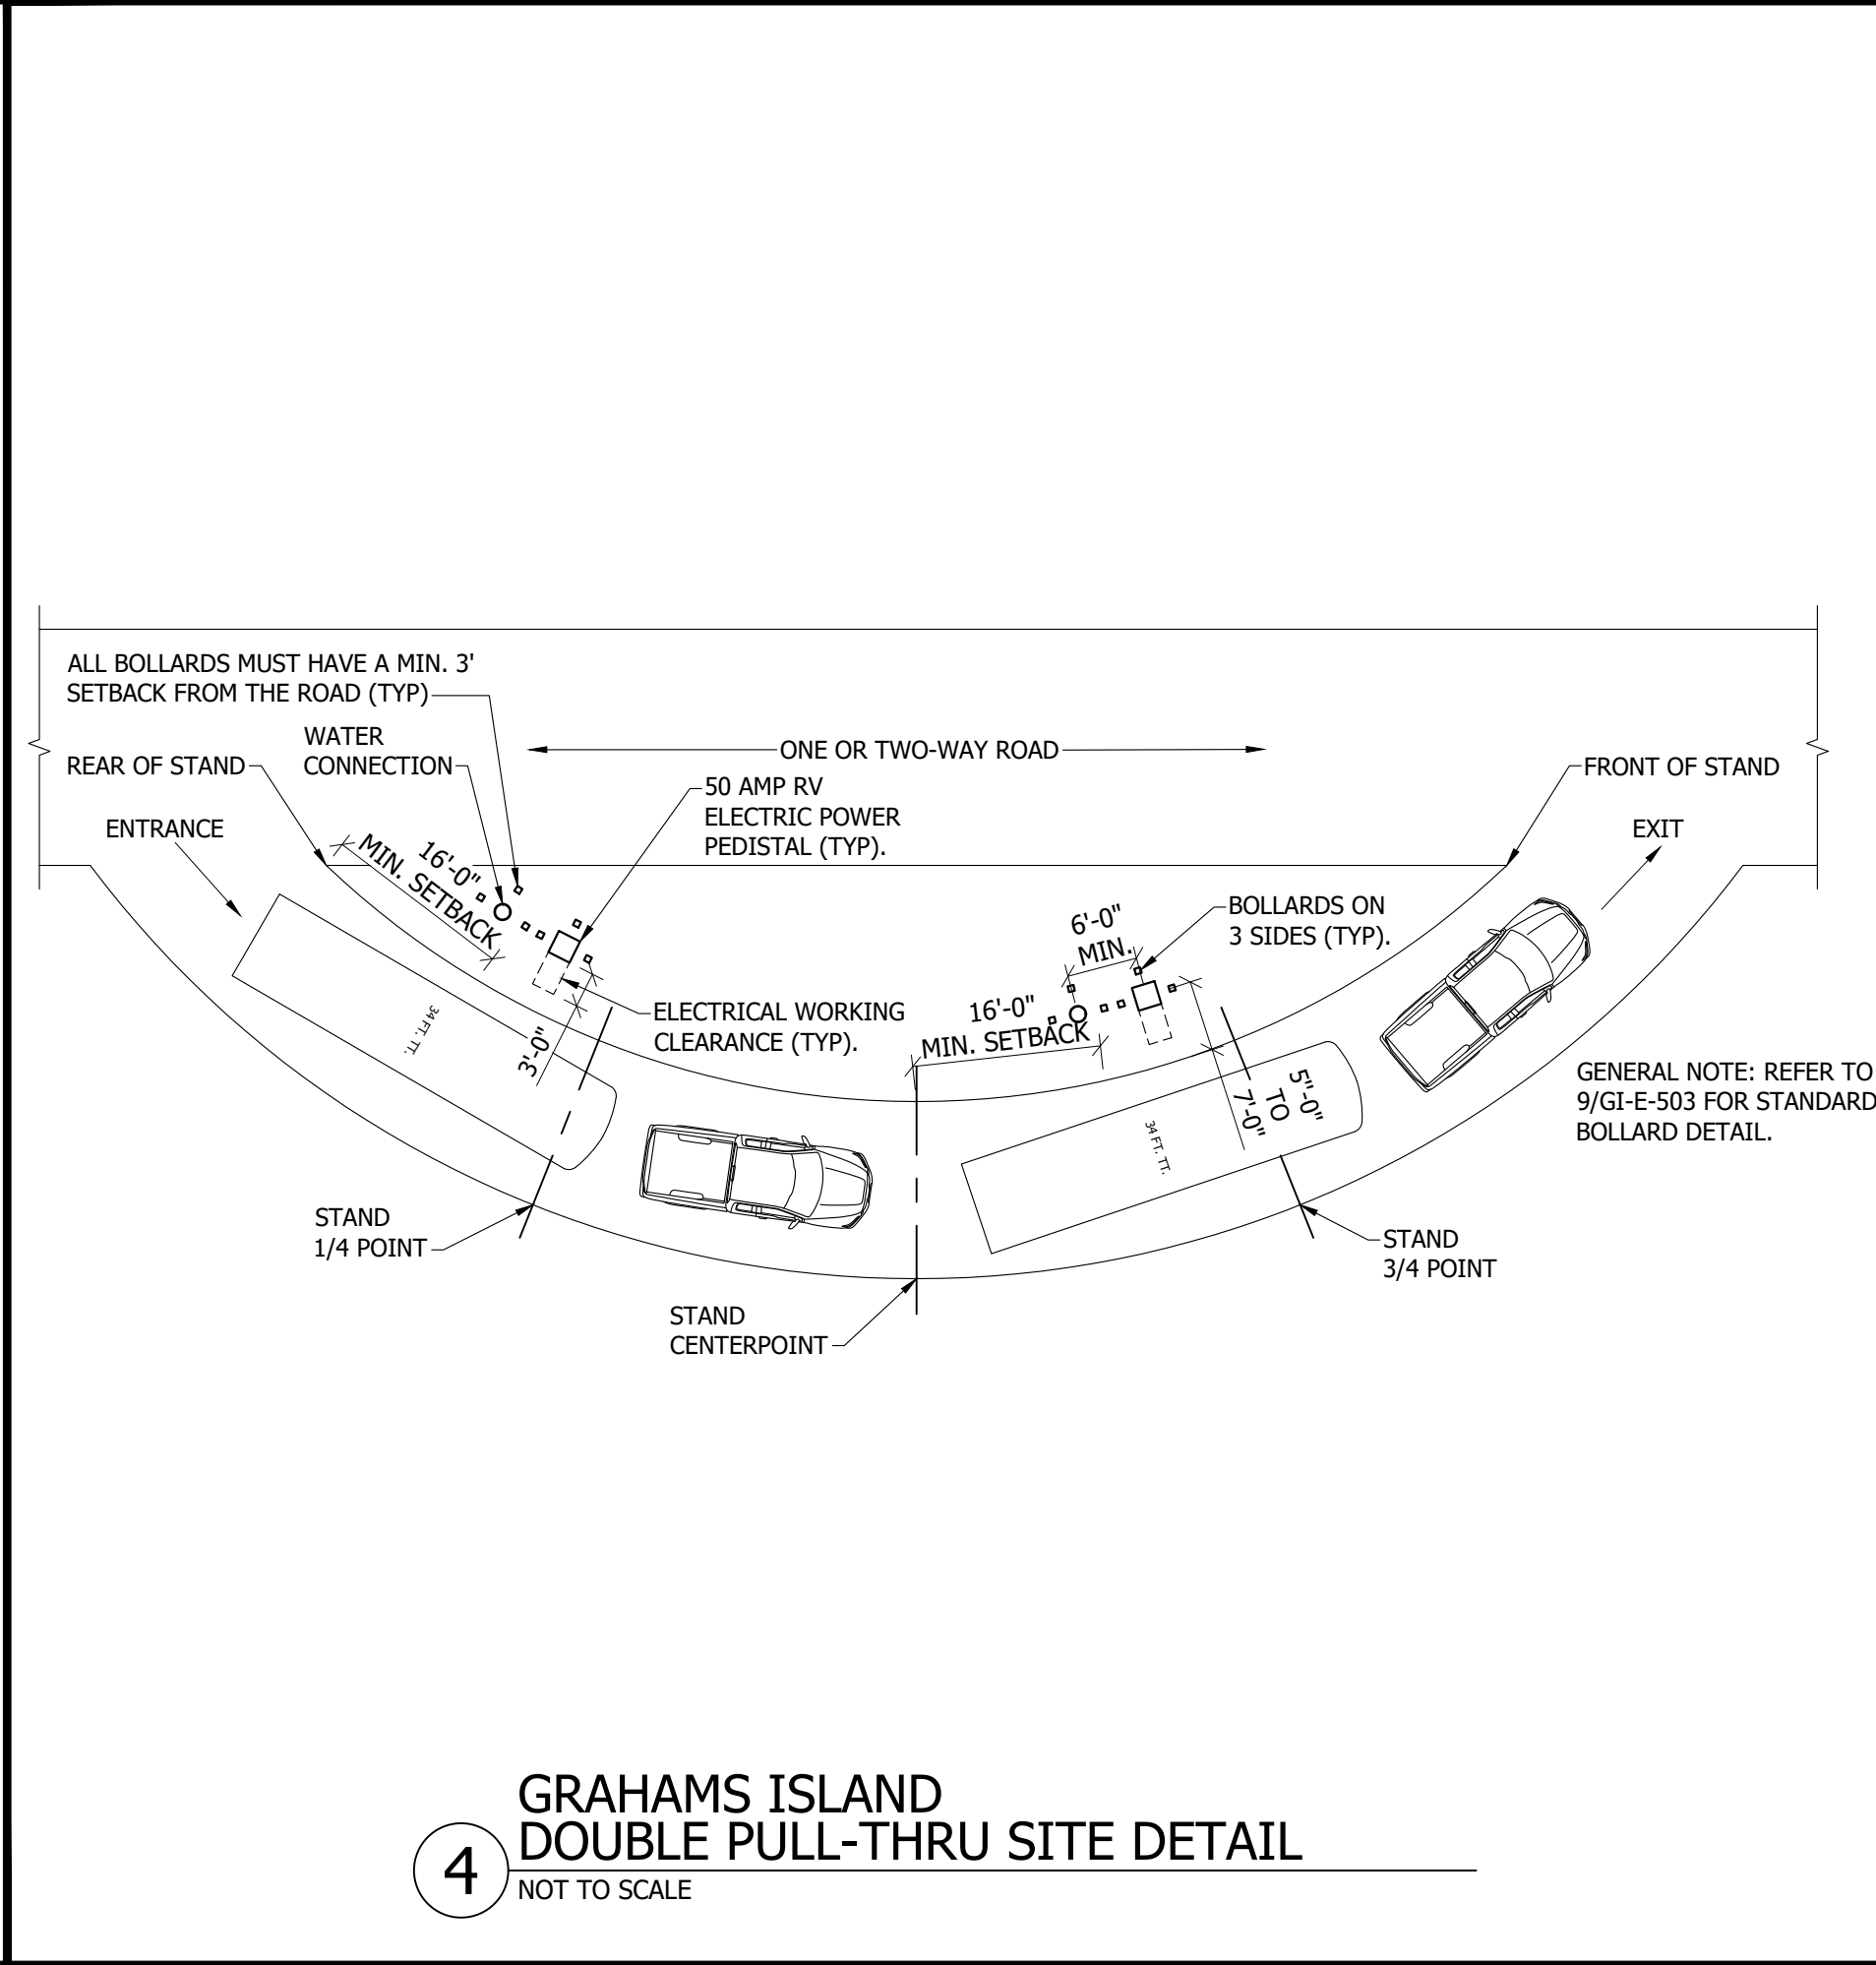

4 GRAHAMS ISLAND  
DOUBLE PULL-THRU SITE DETAIL  
NOT TO SCALE

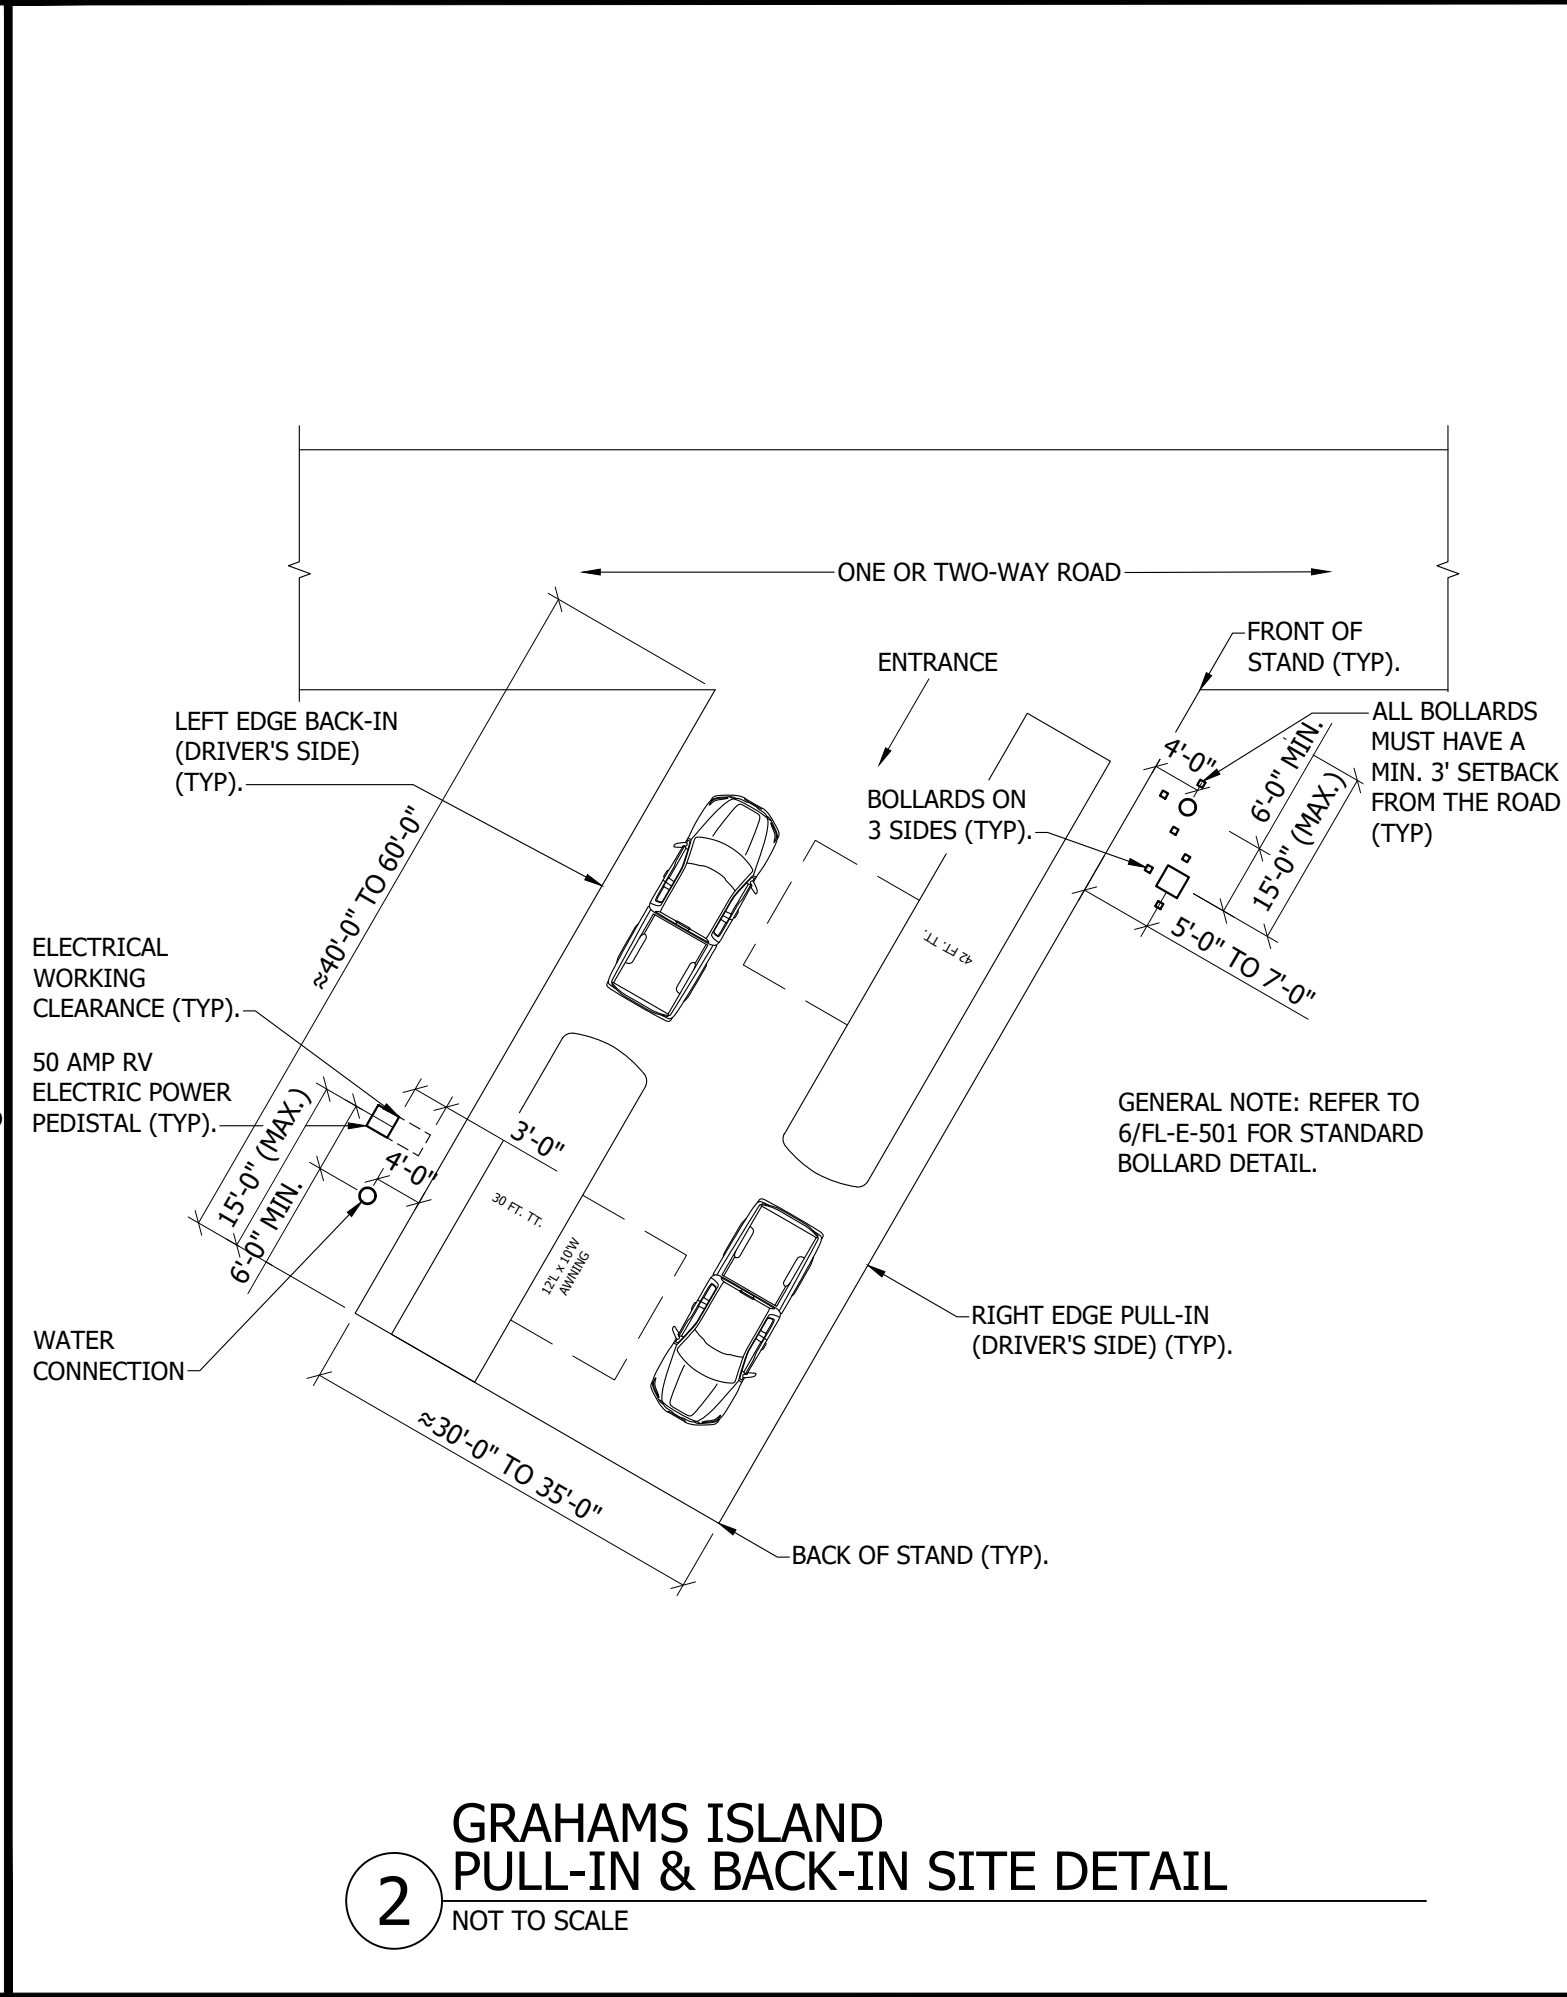

2 GRAHAMS ISLAND  
PULL-IN & BACK-IN SITE DETAIL  
NOT TO SCALE

BY	
DATE	
#	
DESCRIPTION	

**Bartlett & West**

3456 E CENTURY AVENUE - BISMARCK, ND 58503  
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WWW.BARTLETTWEST.COM

**ELECTRICAL SITE DETAILS**  
**GRAHAMS ISLAND STATE PARK**  
NORTH DAKOTA PARKS & RECREATION DEPARTMENT  
ELECTRICAL UPGRADES  
BISMARCK, NORTH DAKOTA

DESIGNED BY: ARH  
DRAWN BY: SDM  
APPROVED BY: MSV  
DESIGN PROJ: 21219.000  
CONST PROJ:  
SCALE: AS NOTED  
DATE: 04-24-2023  
DRAWING NO: **GI-E-501**  
SHEET NO: 21 of 32

Last edit on: 4/21/2023 12:11 PM by: SDW01521 Drawing Name: F:\proj\21000\21219\21219\000\AutoCad\Plan Set\Graham's Island\21219.000E - Electrical Details - GISP.dwg Layout Name: ELECTRICAL DETAILS - GISP.dwg Plotted by: SDW01521 Plotted on: 4/24/2023 2:21:07 PM



EX "P13"  
MIDWEST ELECTRIC  
200 AMP, 120/240 VOLT,  
1 PHASE, 3 WIRE  
PANELBOARD



EX "T8"

4 EX "P13" AND EX "T8" (SITE 122, HOWARD LOOP)

NOT TO SCALE



EX "P14"  
MIDWEST ELECTRIC  
200 AMP, 120/240 VOLT,  
1 PHASE, 3 WIRE  
PANELBOARD



EX "T9"

5 EX "P14" AND EX "T9" (EAST OF SITE 130, HOWARD LOOP)

NOT TO SCALE



EX "P15"  
MIDWEST ELECTRIC  
200 AMP, 120/240 VOLT,  
1 PHASE, 3 WIRE  
PANELBOARD



EX "T10"

6 EX "P15" AND EX "T10" (SOUTH OF SITE 140, ZIEBACH LOOP)

NOT TO SCALE



EX "P10"  
MIDWEST ELECTRIC  
200 AMP, 120/240 VOLT,  
1 PHASE, 3 WIRE  
PANELBOARD



EX "T5"

1 EX "P10" AND EX "T5" (SITE 104, HOWARD LOOP)

NOT TO SCALE



EX "P11"  
MIDWEST ELECTRIC  
200 AMP, 120/240 VOLT,  
1 PHASE, 3 WIRE  
PANELBOARD



EX "T6"

2 EX "P11" AND EX "T6" (NORTH OF SITE 111, HOWARD LOOP)

NOT TO SCALE



EX "P12"  
MIDWEST ELECTRIC  
200 AMP, 120/240 VOLT,  
1 PHASE, 3 WIRE  
PANELBOARD



EX "T7"

3 EX "P12" AND EX "T7" (NORTH OF SITE 120, ZIEBACH LOOP)

NOT TO SCALE


BAR IS ONE INCH ON OFFICIAL DRAWINGS. 0 1" IF NOT ONE INCH, ADJUST SCALE ACCORDINGLY.

**Bartlett & West**

3456 E CENTURY AVENUE - BISMARCK, ND 58503  
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WWW.BARTLETTANDWEST.COM

ELECTRICAL DETAILS  
GRAHAM'S ISLAND STATE PARK

NORTH DAKOTA PARKS & RECREATION DEPARTMENT  
ELECTRICAL UPGRADES  
BISMARCK, NORTH DAKOTA

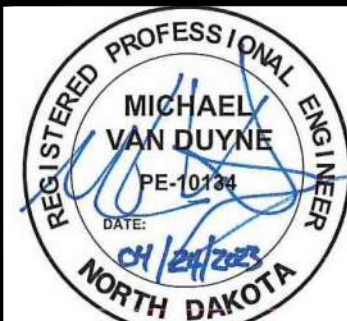

DESIGNED BY:	ARH
DRAWN BY:	ARH/SDM
APPROVED BY:	MSV
DESIGN PROJ:	21219.000
CONST PROJ:	
SCALE:	AS NOTED
DATE:	04-24-2023
DRAWING NO:	
<b>GI-E-502</b>	
SHEET NO:	

22 of ----

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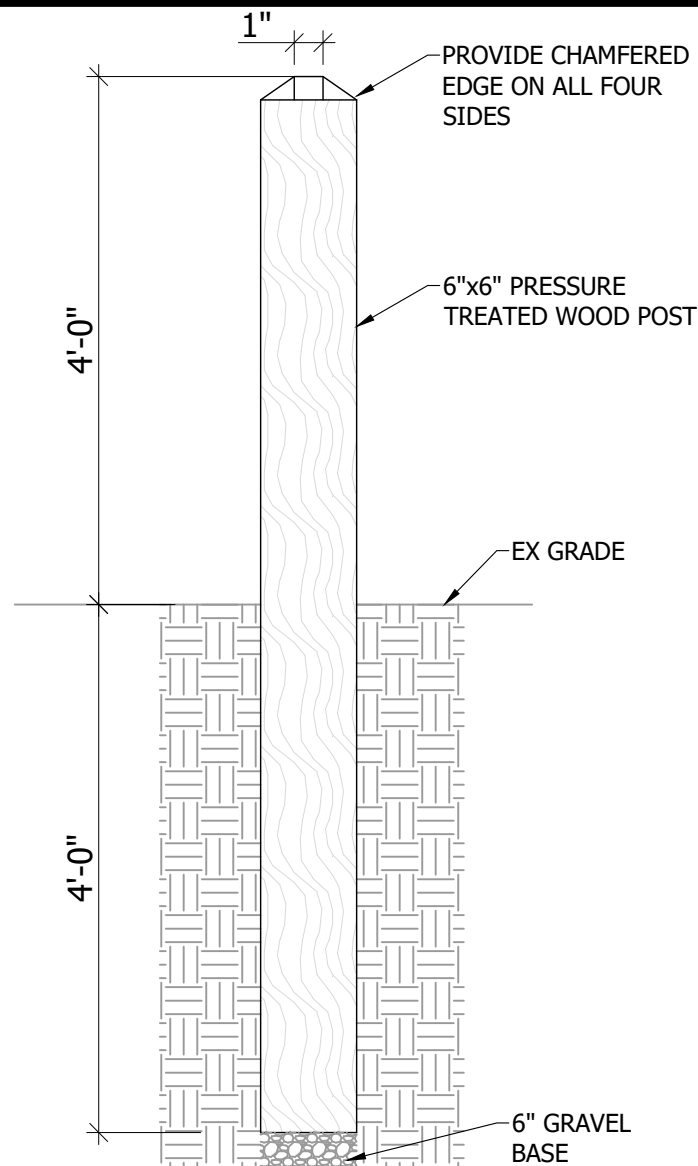
Last edit on: 4/21/2023 12:11 PM by: SDW01521 Drawing Name: F:\proj\21000\21219\21219\000\AutoCad\Plan Set\Graham's Island\21219.000E - Electrical Details - GISP.dwg Layout Name: ELECTRICAL DETAILS 2 - GISP Plotted by: SDW01521 Plotted on: 4/24/2023 2:21:20 PM




7 EX "P9" (LIFT STATION, ZIEBACH LOOP)  
NOT TO SCALE



8 EX SHOP YARD TRANSFORMER (NORTH OF ZIEBACH LOOP)  
NOT TO SCALE



6 BOLLARD DETAIL  
NOT TO SCALE

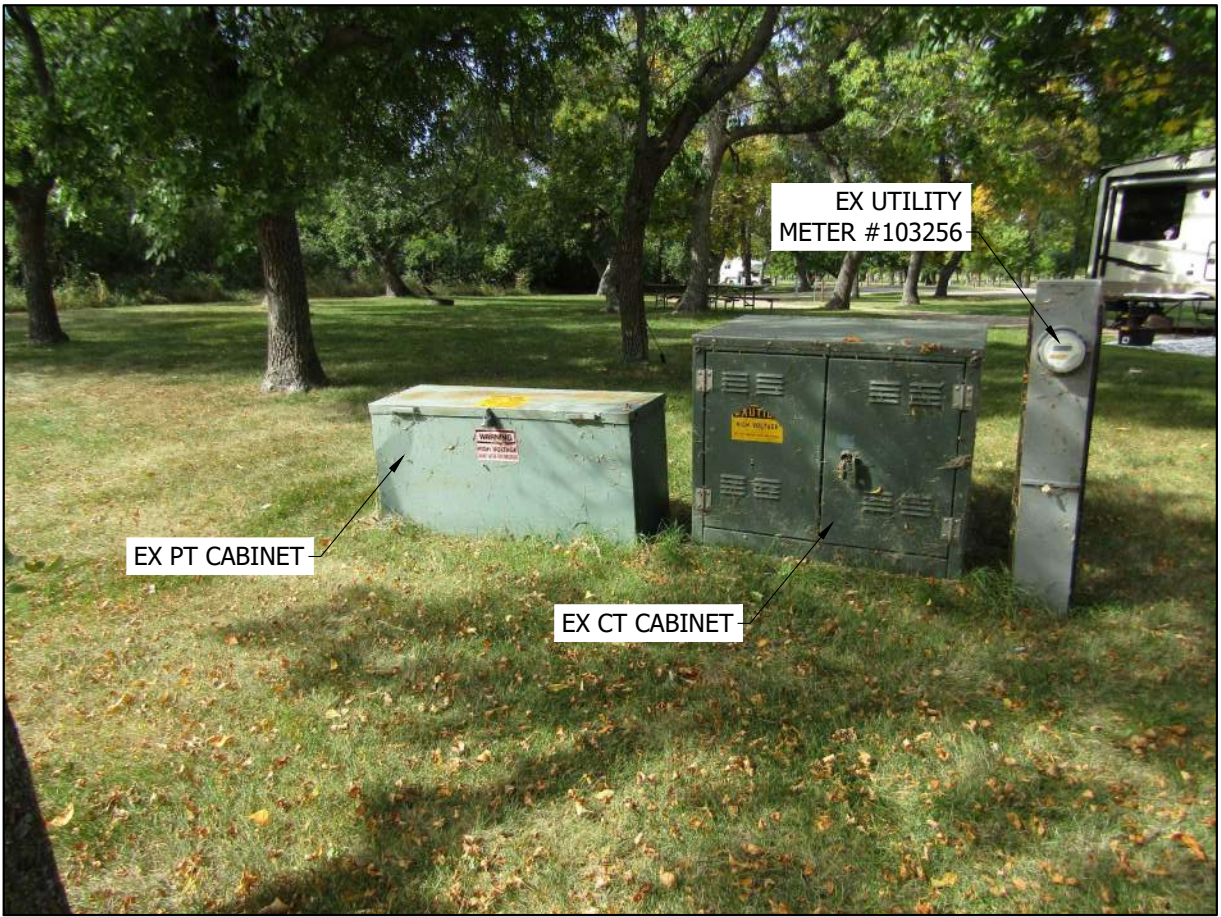

4 EX UTILITY EQUIPMENT (SOUTH OF SITE 6, ZIEBACH LOOP)  
NOT TO SCALE



5 EX "P7" AND "T4" (NORTH OF SITE 7A, ZIEBACH LOOP)  
NOT TO SCALE



6 EX "P8" (COMFORT STATION, ZIEBACH LOOP)  
NOT TO SCALE



1 EX "P1", EX "T1", AND EX "P2" (WEST OF SITE 39A, ZIEBACH LOOP)  
NOT TO SCALE



2 EX "P3", EX "T2", AND EX "P4" (WEST OF SITE 13, ZIEBACH LOOP)  
NOT TO SCALE



3 EX "P5", EX "T3", AND EX "P6" (WEST OF SITE 21, ZIEBACH LOOP)  
NOT TO SCALE


BAR IS ONE INCH ON OFFICIAL DRAWINGS. 0 1" IF NOT ONE INCH, ADJUST SCALE ACCORDINGLY.

**Bartlett & West**

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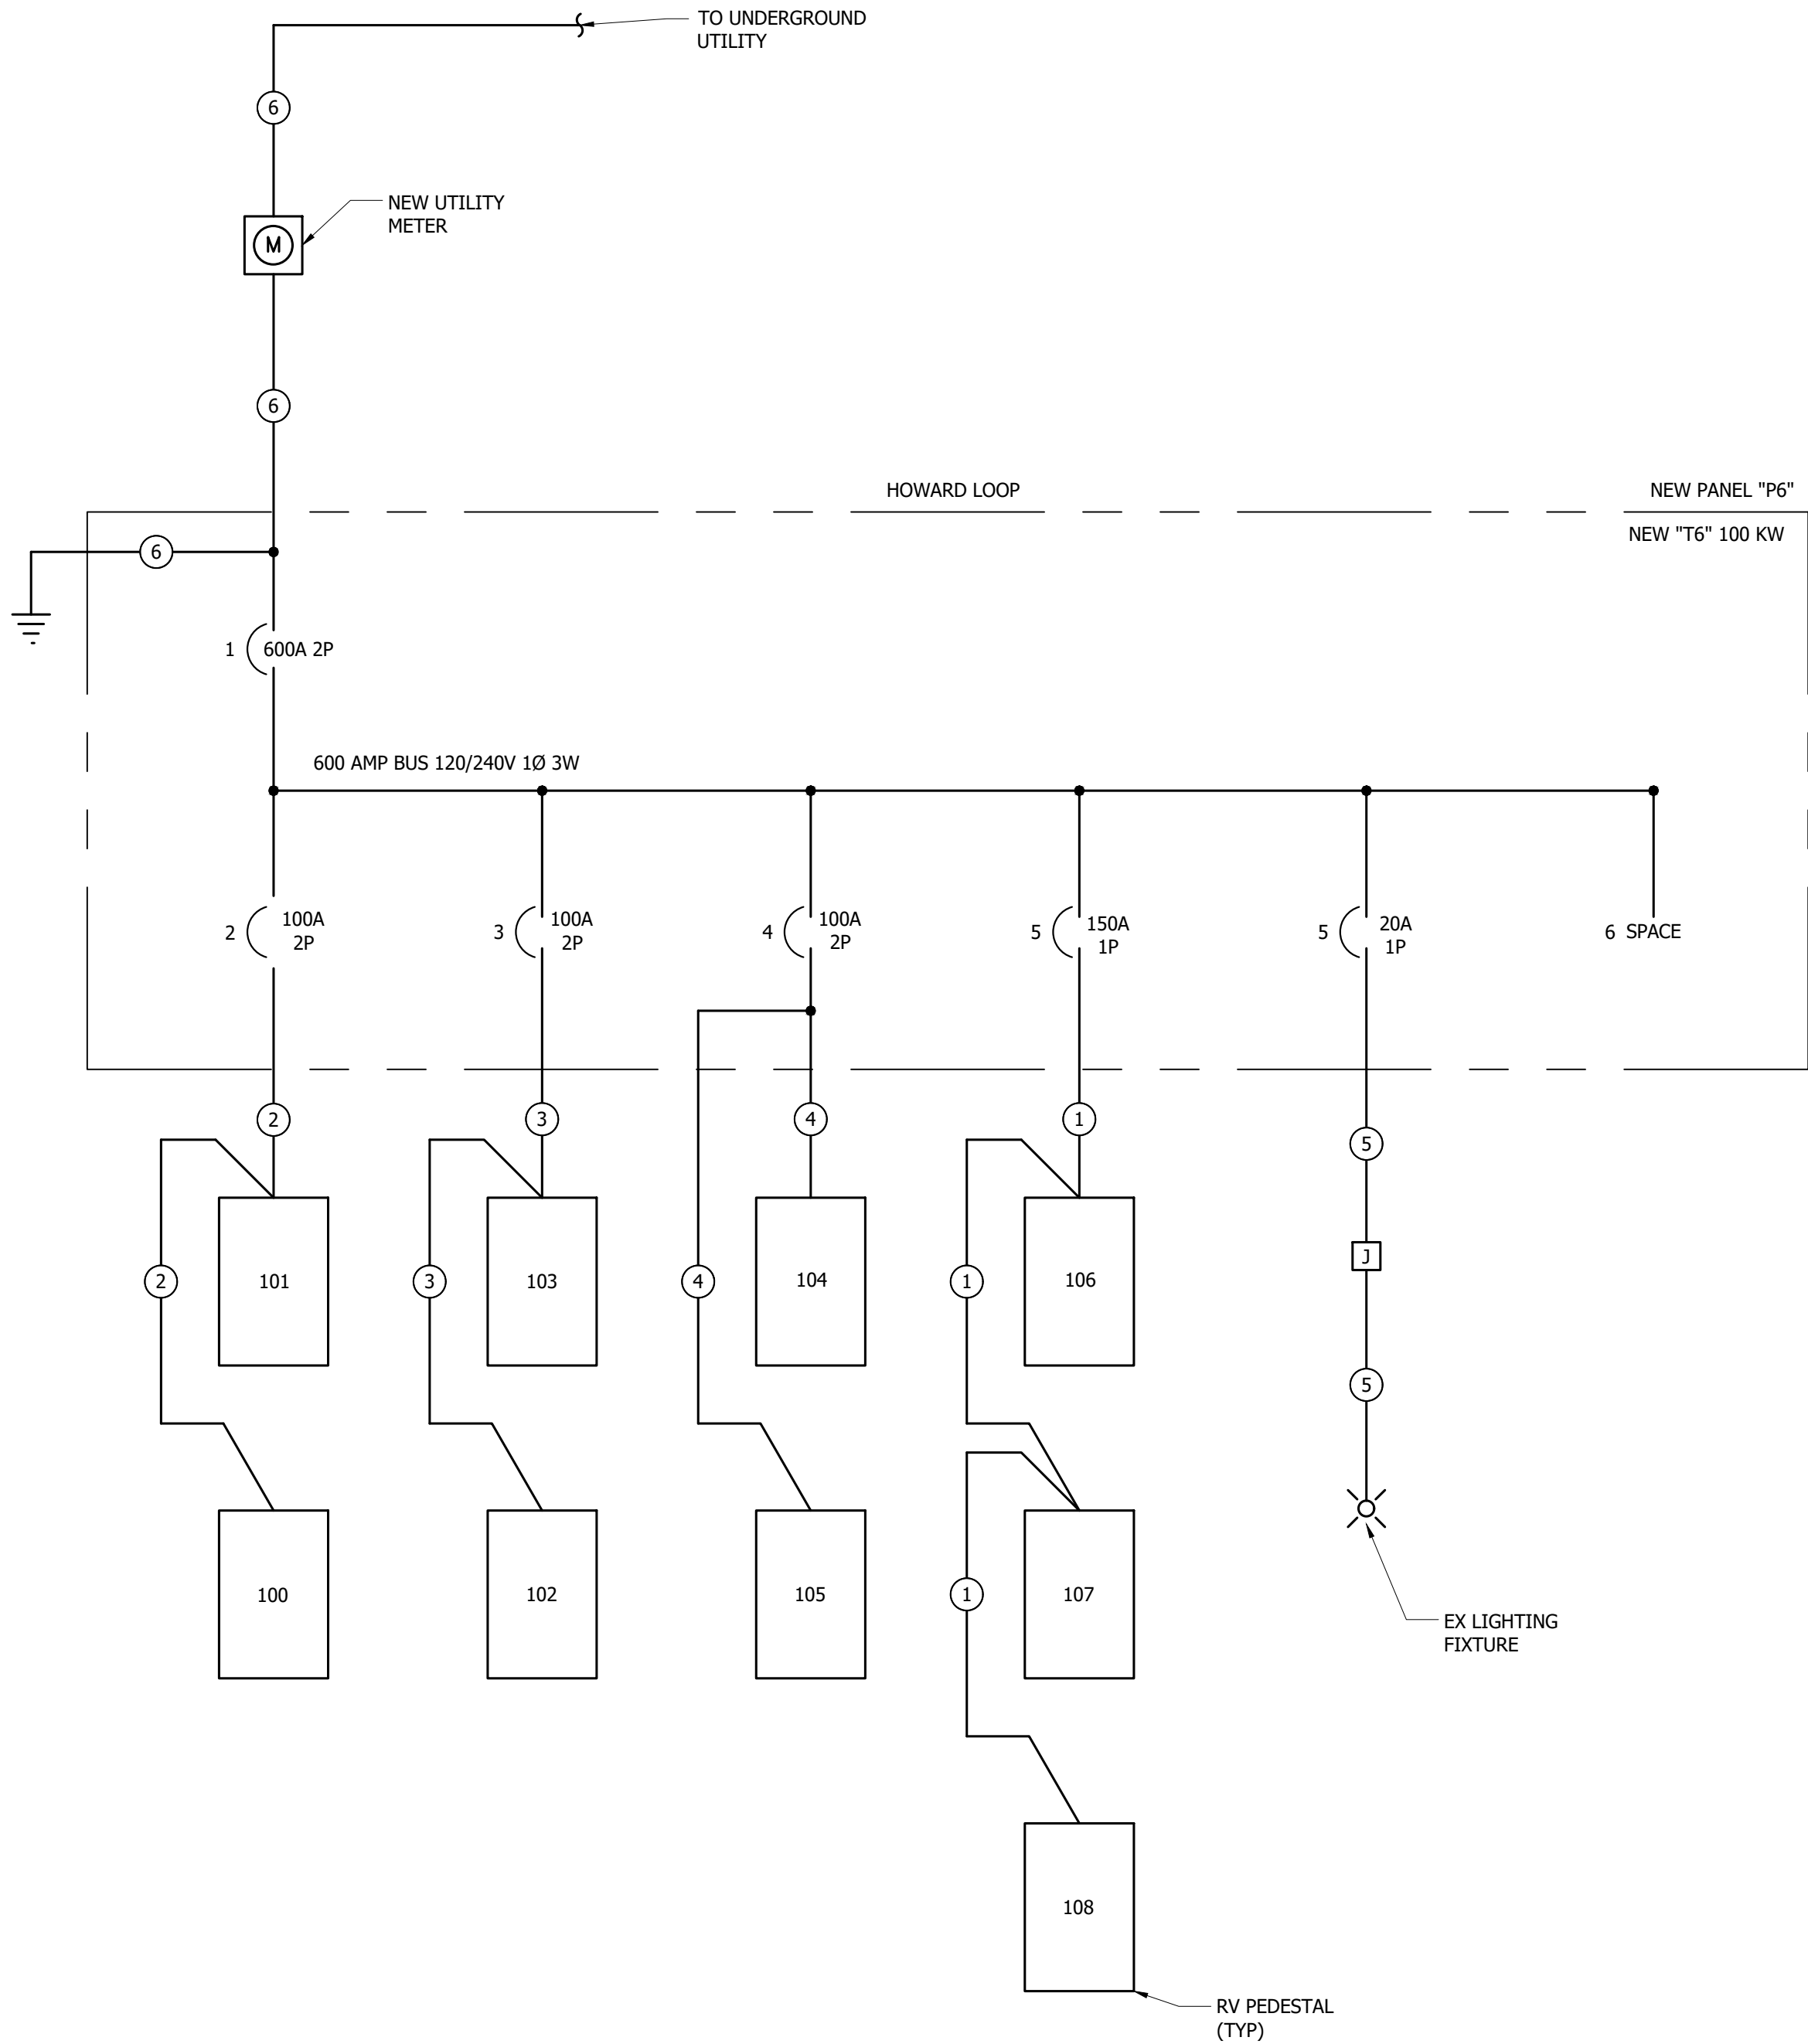
**ELECTRICAL DETAILS**  
**GRAHAM'S ISLAND STATE PARK**

**NORTH DAKOTA PARKS & RECREATION DEPARTMENT**  
**ELECTRICAL UPGRADES**  
**BISMARCK, NORTH DAKOTA**

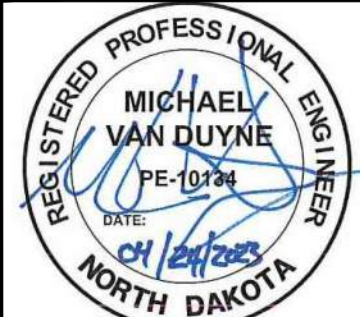

DESIGNED BY: ARH  
DRAWN BY: ARH/SDM  
APPROVED BY: MSV  
DESIGN PROJ: 21219.000  
CONST PROJ:  
SCALE: AS NOTED  
DATE: 04-24-2023  
DRAWING NO:  
**GI-E-503**  
SHEET NO:

Last edit on: 4/21/2023 12:11 PM by: SDM01521 Drawing Name: F:\Proj\21000\21219\21219\000\AutoCad\Plan Set\Graham's Island\21219.000E - Electrical Details - GISP.dwg Layout Name: ELECTRICAL DETAILS 3 - GISP Picked on: 4/24/2023 2:21:41 PM




5 "P6" ELECTRICAL WIRING DIAGRAM (HOWARD LOOP)  
NOT TO SCALE

FEEDER SCHEDULE:


- 1 3-250 DIRECT BURY CABLE WITH 250G.(BASED ON COPPER)
- 2 3-1 DIRECT BURY CABLE WITH 1G.(BASED ON COPPER)
- 3 3-2 DIRECT BURY CABLE WITH 2G.(BASED ON COPPER)
- 4 3-3 DIRECT BURY CABLE WITH 3G. (BASED ON COPPER)
- 5 2-10 DIRECT BURY CABLE WITH 1-10G. (BASED ON COPPER)
- 6 REFER TO ELECTRICAL IMPROVEMENT RISER DIAGRAM.

ALL POWER OUTLET PEDESTALS ARE BASED ON MIDWEST U075 GP6 POWER OUTLET PANELS W/ 100 AMP MAINS, 1-50 AMP, 2P BKR & 50AMP 240 VOLT RECEPTACLE, 1-30 AMP 1P BKR & 30 AMP 120 VOLT RECEPTACLE, AND 1-20 AMP 1P GFI BKR & 120 VOLT DUPLEX RECEPTACLE.


- 1 - PROVIDE PANELS WHICH ARE NEMA 3R & SERVICE ENTRANCE RATED.
- 2 - REFER TO IMPROVEMENT PLAN GI-E-111 FOR FEEDER LAYOUT. UNLESS NOTED OTHERWISE, TYPE USE, LISTED FOR DIRECT BURIAL. DIRECT BURIAL AND LIGHTING CIRCUIT WIRING BASED ON COPPER. E/C TO PROVIDE ALTERNATE PRICE FOR ALUMINUM.
- 3 - PROVIDE FEED-THRU GROUNDING STRAP AT EACH NEW PEDESTAL WHICH IS NOT AT THE END OF A CIRCUIT. CONNECT STRAP BETWEEN INCOMING AND OUTGOING GROUNDING CONDUCTORS. PROVIDE GROUND ROD AT EACH PEDESTAL. DO NOT CONNECT GROUND LUG TO NEUTRAL LUG.
- 4 - REFER TO FLUSH GRADE JUNCTION BOX DETAIL FOR BOTH PREDETERMINED JUNCTION BOX LOCATIONS ON PLANS AND FOR AREAS THAT MAY REQUIRE JUNCTION BOXES FOR PULLING WIRE.

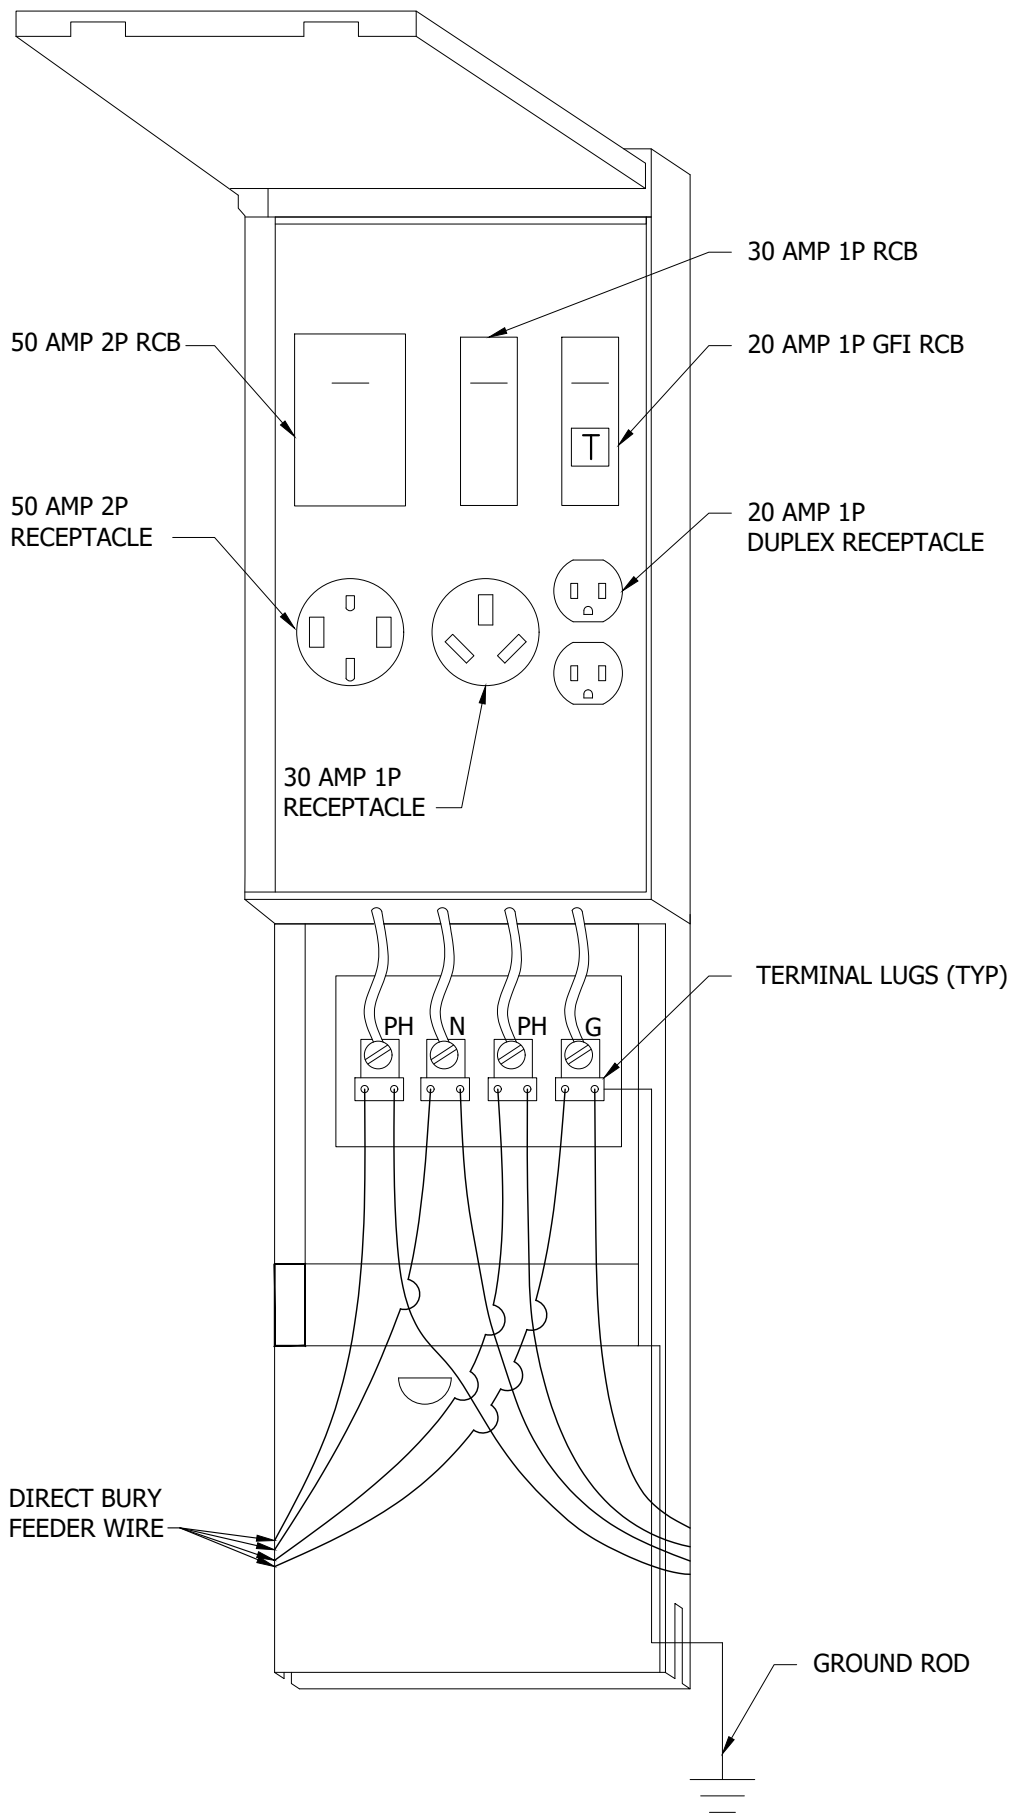


2 FEED THRU RV PEDESTAL DETAIL  
NOT TO SCALE

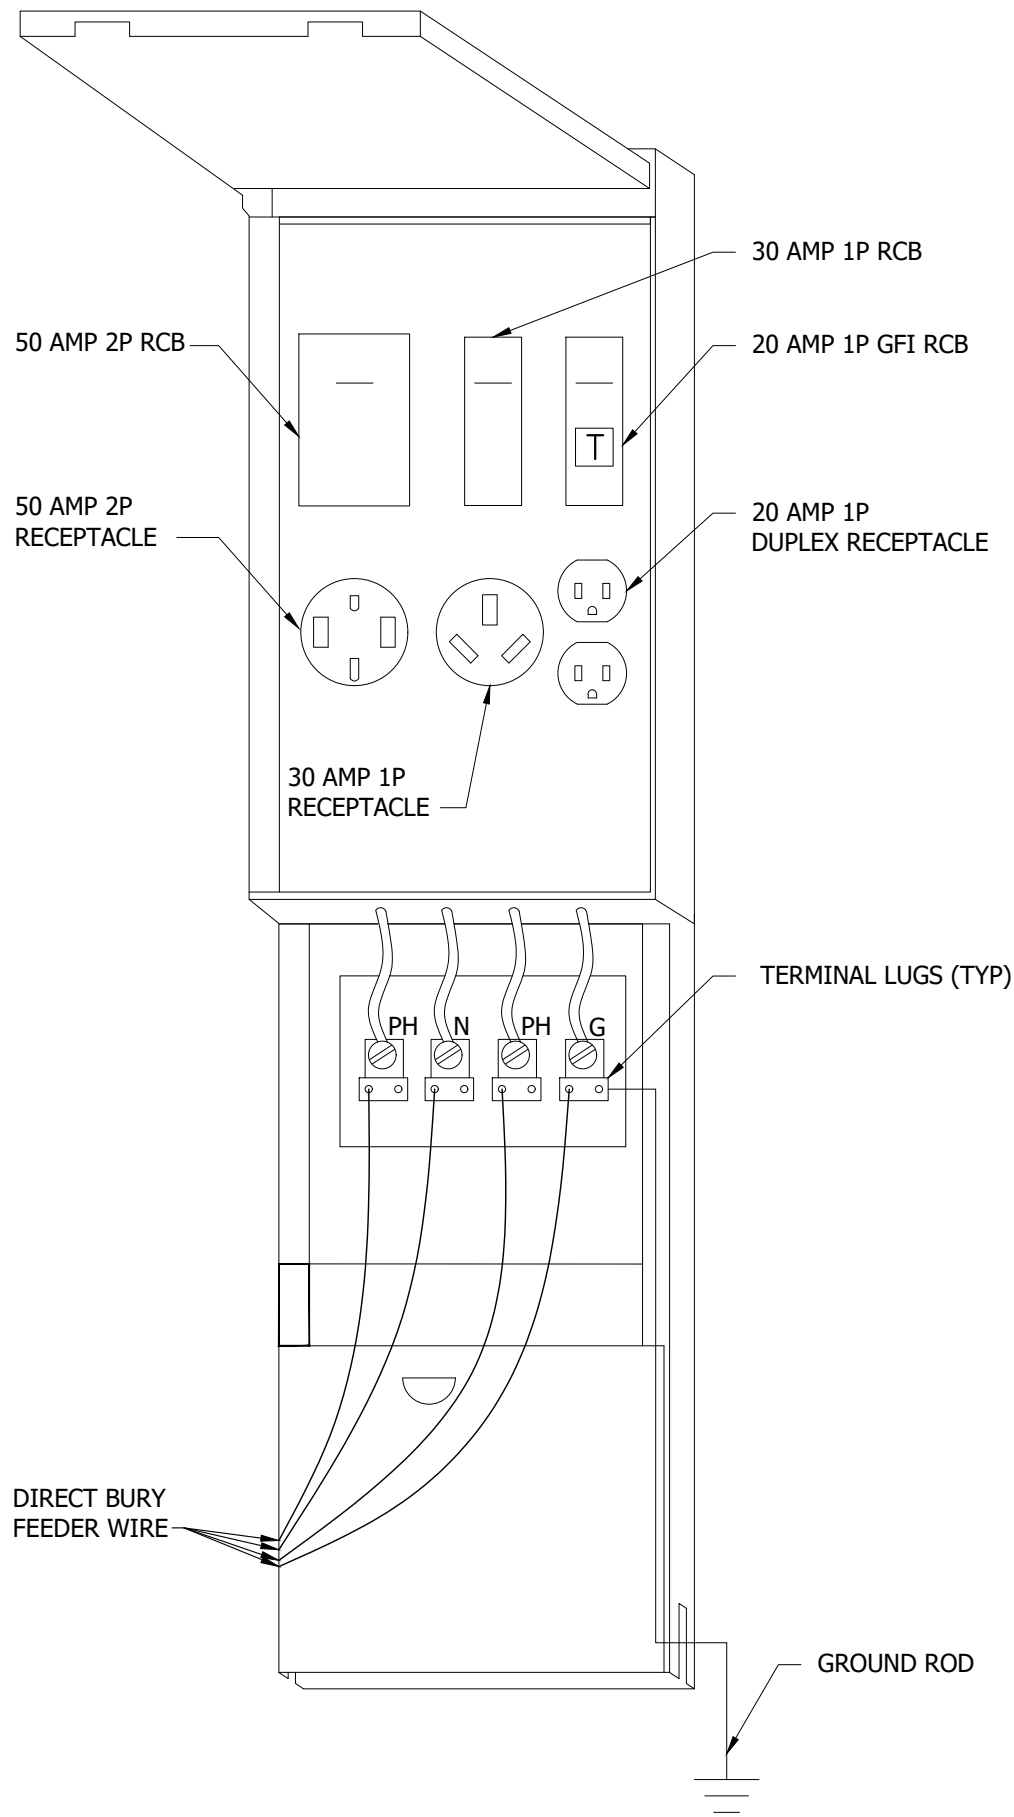

1 END OF LINE RV PEDESTAL DETAIL  
NOT TO SCALE

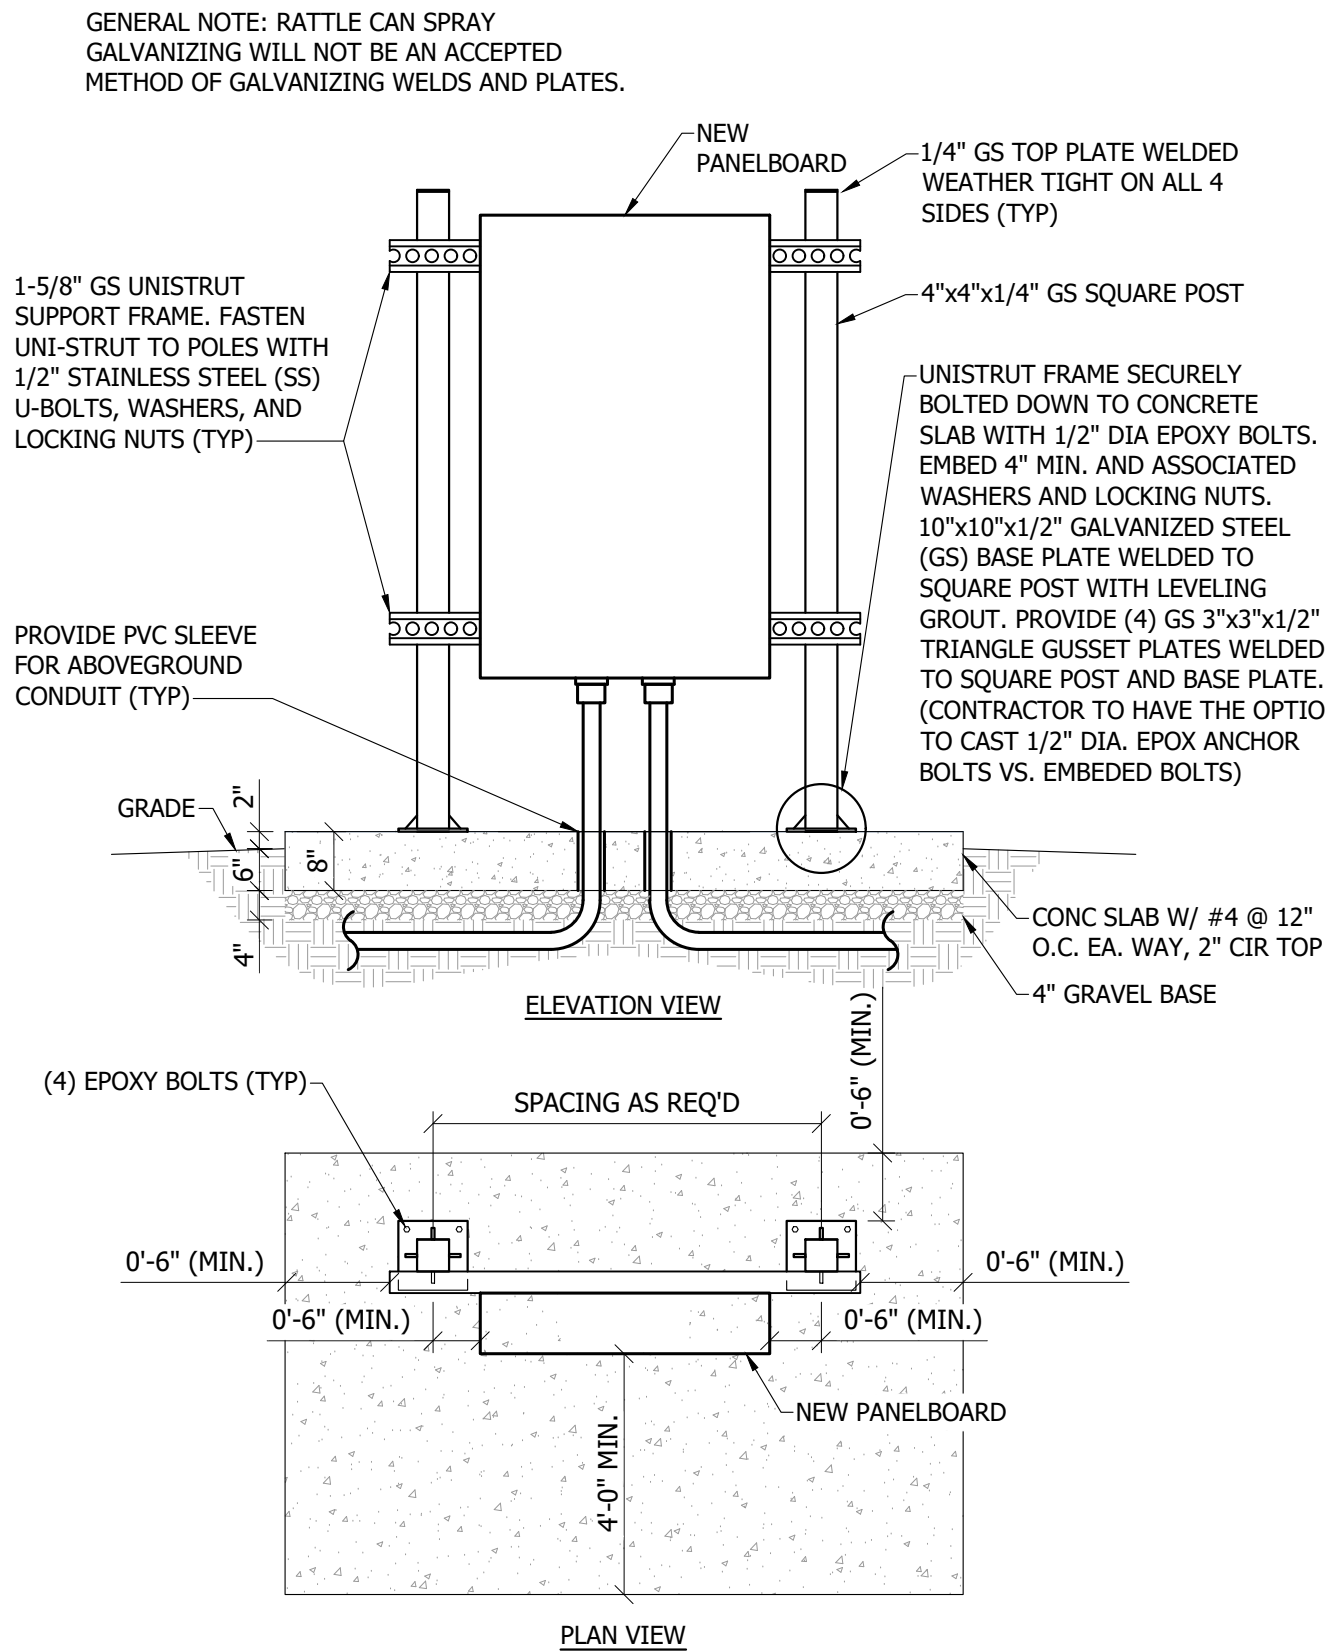

4 UNI-STRUT MOUNTING DETAIL  
NOT TO SCALE

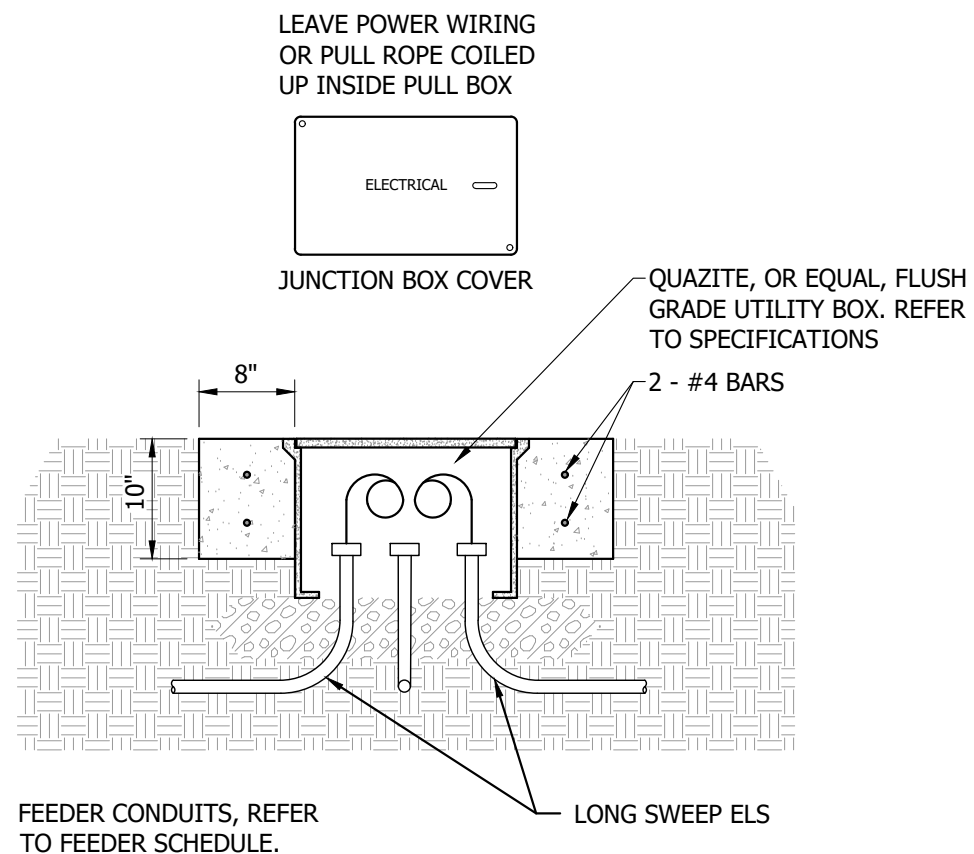


3 FLUSH GRADE JUNCTION BOX DETAIL  
NOT TO SCALE

**Bartlett & West**


3456 E CENTURY AVENUE - BISMARCK, ND 58503  
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**ELECTRICAL DETAILS**  
**GRAHAM'S ISLAND STATE PARK**  
**NORTH DAKOTA PARKS & RECREATION DEPARTMENT**  
**ELECTRICAL UPGRADES**  
**BISMARCK, NORTH DAKOTA**

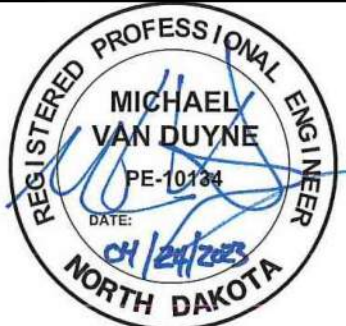

DESIGNED BY:	ARH
DRAWN BY:	ARH/SDM
APPROVED BY:	MSV
DESIGN PROJ:	21219.000
CONST PROJ:	
SCALE:	AS NOTED
DATE:	04-24-2023
DRAWING NO:	<b>GI-E-504</b>
SHEET NO:	24 of 32

Last edit on: 4/21/2023 12:11 PM by: SDM01521 Drawing Name: F:\Proj\21000\21219\21219\000\AutoCad\Plan Set\Graham's Island\21219.000E - Electrical Details - GISP.dwg Layout Name: ELECTRICAL DETAILS 4 - GISP Picked on: 4/24/2023 2:21:57 PM

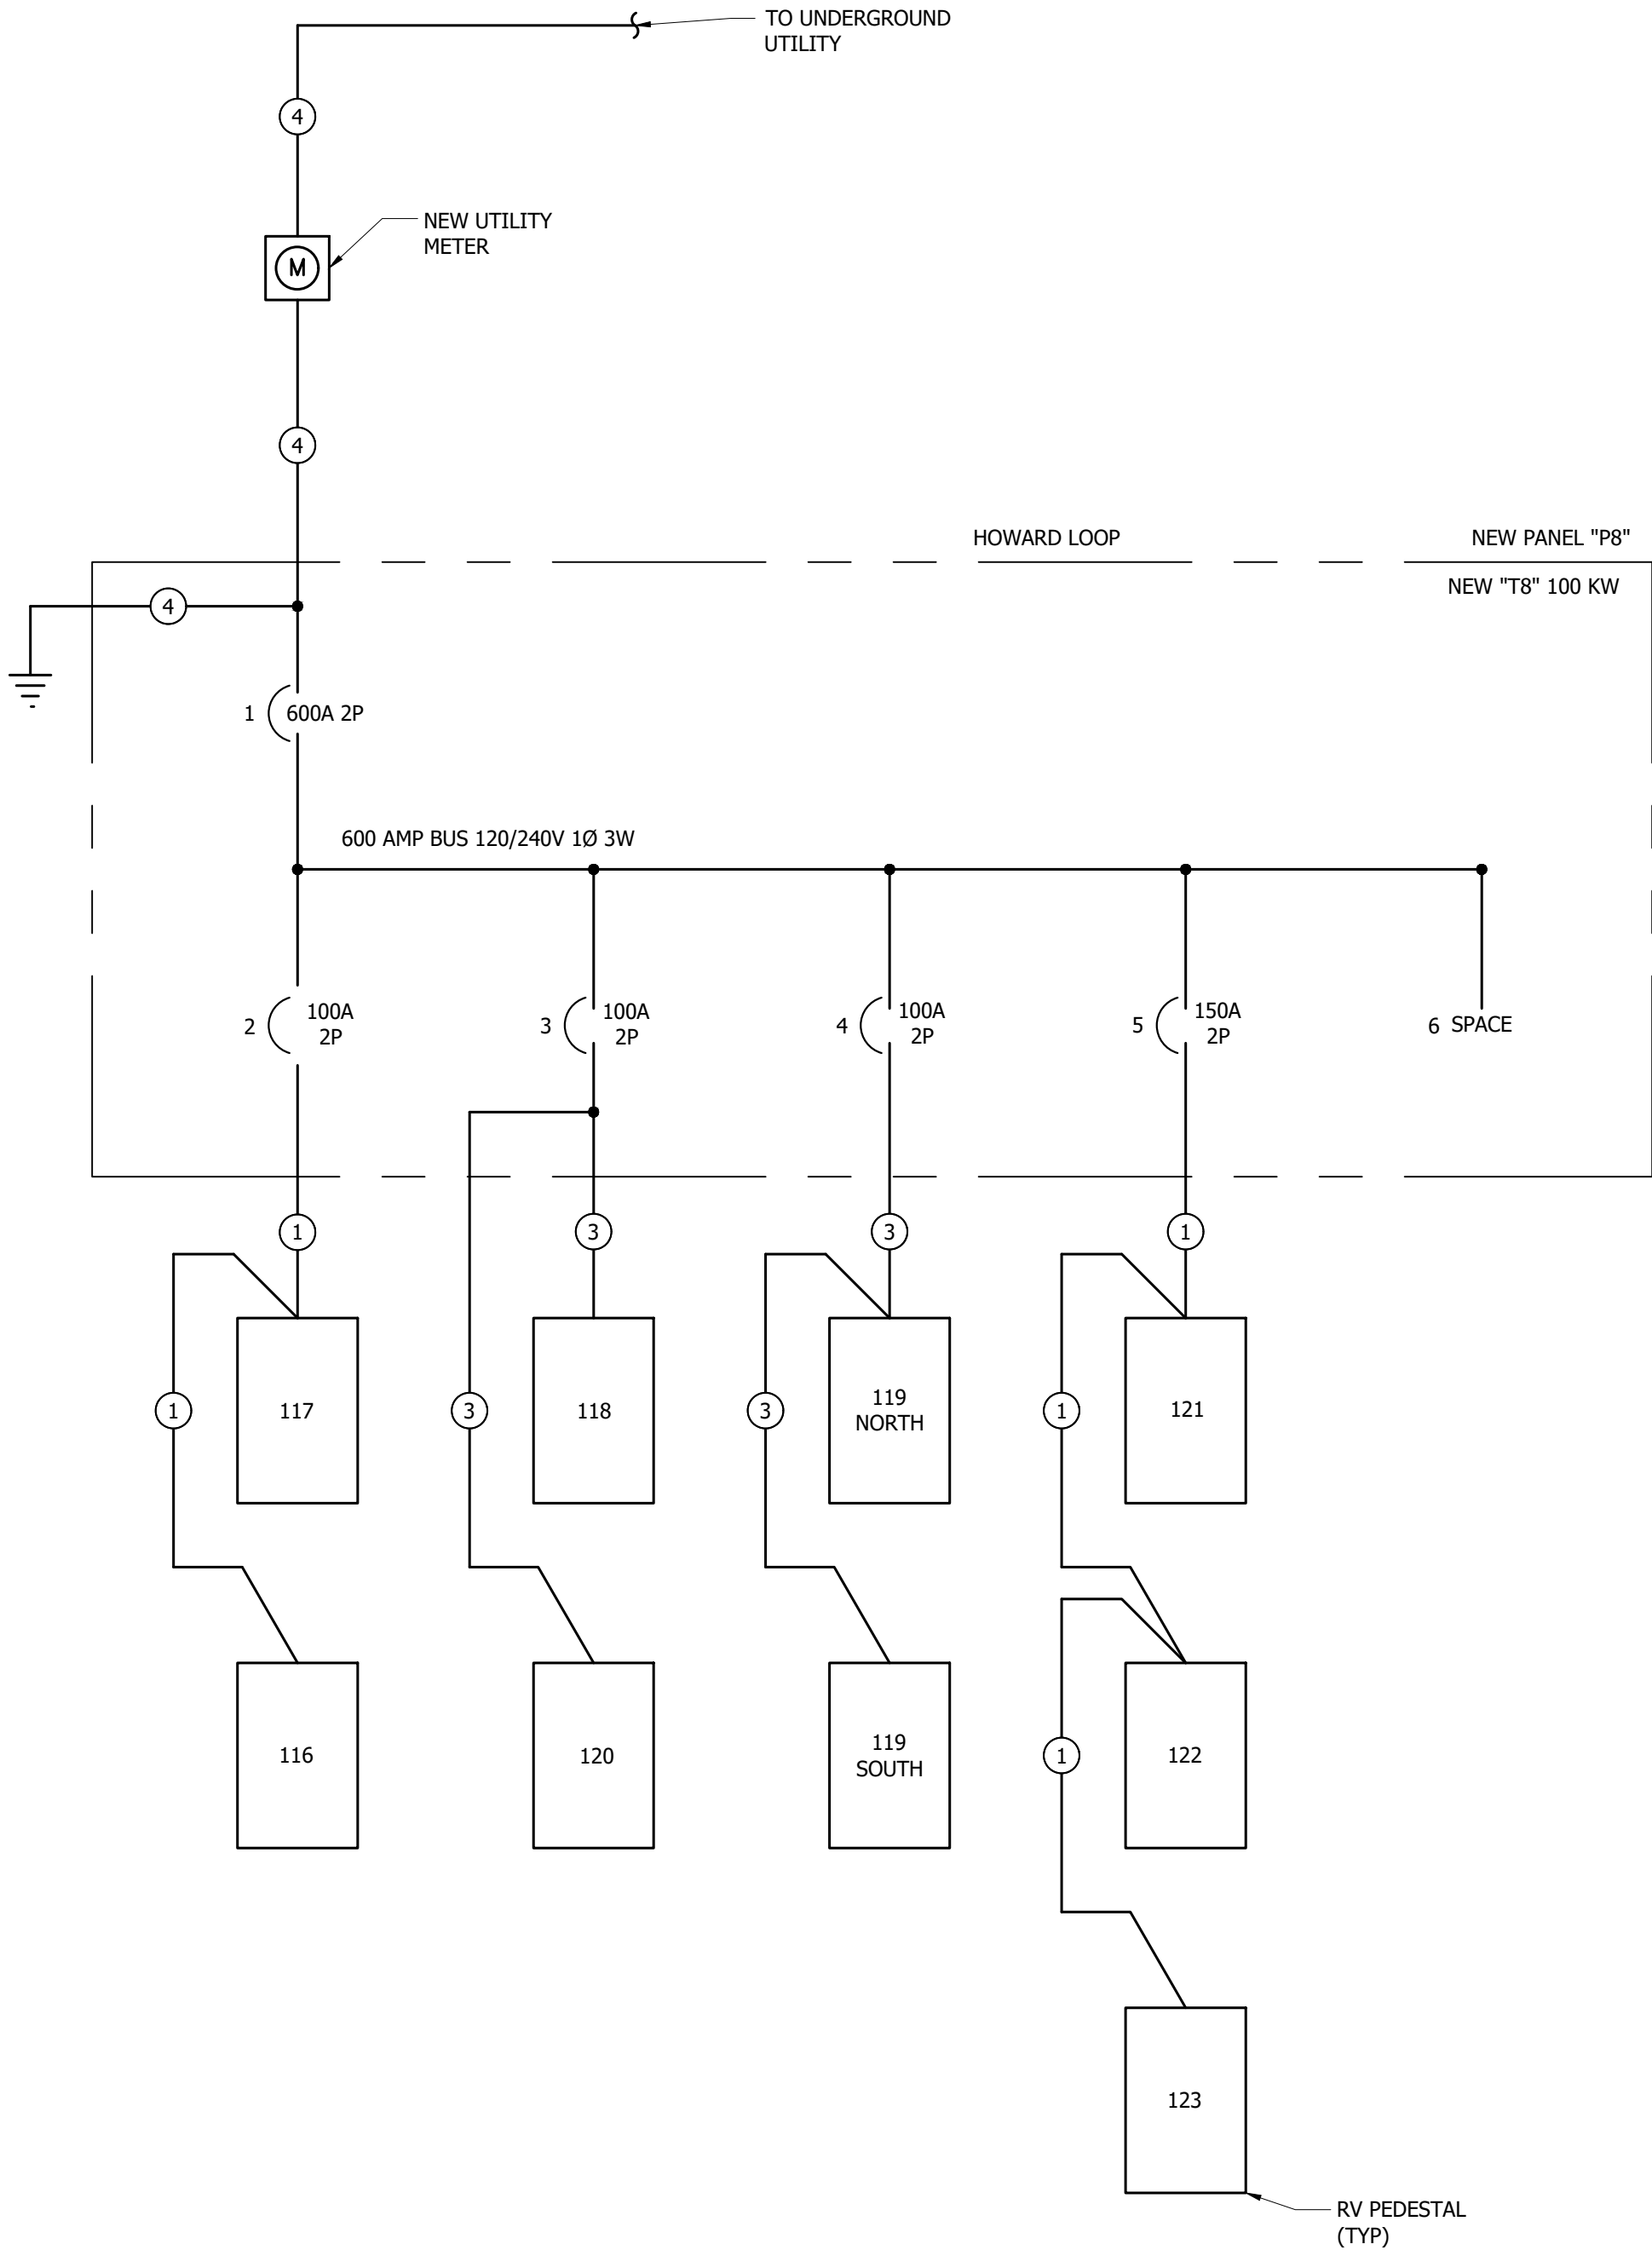


### FEEDER SCHEDULE:

- ① 3-2/0 DIRECT BURY CABLE WITH 2/0G.(BASED ON COPPER)
- ② 3-2 DIRECT BURY CABLE WITH 2G.(BASED ON COPPER)
- ③ 3-3 DIRECT BURY CABLE WITH 3G. (BASED ON COPPER)
- ④ REFER TO ELECTRICAL IMPROVEMENT RISER DIAGRAM.

ALL POWER OUTLET PEDESTALS ARE BASED ON MIDWEST U075 GP6 POWER OUTLET PANELS W/ 100 AMP MAINS. 1-50 AMP, 2P BKR & 50AMP 240 VOLT RECEPTACLE, 1-30 AMP 1P BKR & 30 AMP 120 VOLT RECEPTACLE, AND 1-20 AMP 1P GFI BKR & 120 VOLT DUPLEX RECEPTACLE.

- 1 - PROVIDE PANELS WHICH ARE NEMA 3R & SERVICE ENTRANCE RATED.
- 2 - REFER TO IMPROVEMENT PLAN GI-E-112 FOR FEEDER LAYOUT. UNLESS NOTED OTHERWISE, TYPE USE, LISTED FOR DIRECT BURIAL. DIRECT BURIAL AND LIGHTING CIRCUIT WIRING BASED ON COPPER. E/C TO PROVIDE ALTERNATE PRICE FOR ALUMINUM.
- 3 - PROVIDE FEED-THRU GROUNDING STRAP AT EACH NEW PEDESTAL WHICH IS NOT AT THE END OF A CIRCUIT. CONNECT STRAP BETWEEN INCOMING AND OUTGOING GROUNDING CONDUCTORS. PROVIDE GROUND ROD AT EACH PEDESTAL. DO NOT CONNECT GROUND LUG TO NEUTRAL LUG.
- 4 - REFER TO FLUSH GRADE JUNCTION BOX DETAIL FOR BOTH PREDETERMINED JUNCTION BOX LOCATIONS ON PLANS AND FOR AREAS THAT MAY REQUIRE JUNCTION BOXES FOR PULLING WIRE.

7 "P8" ELECTRICAL WIRING DIAGRAM (HOWARD LOOP)  
NOT TO SCALE

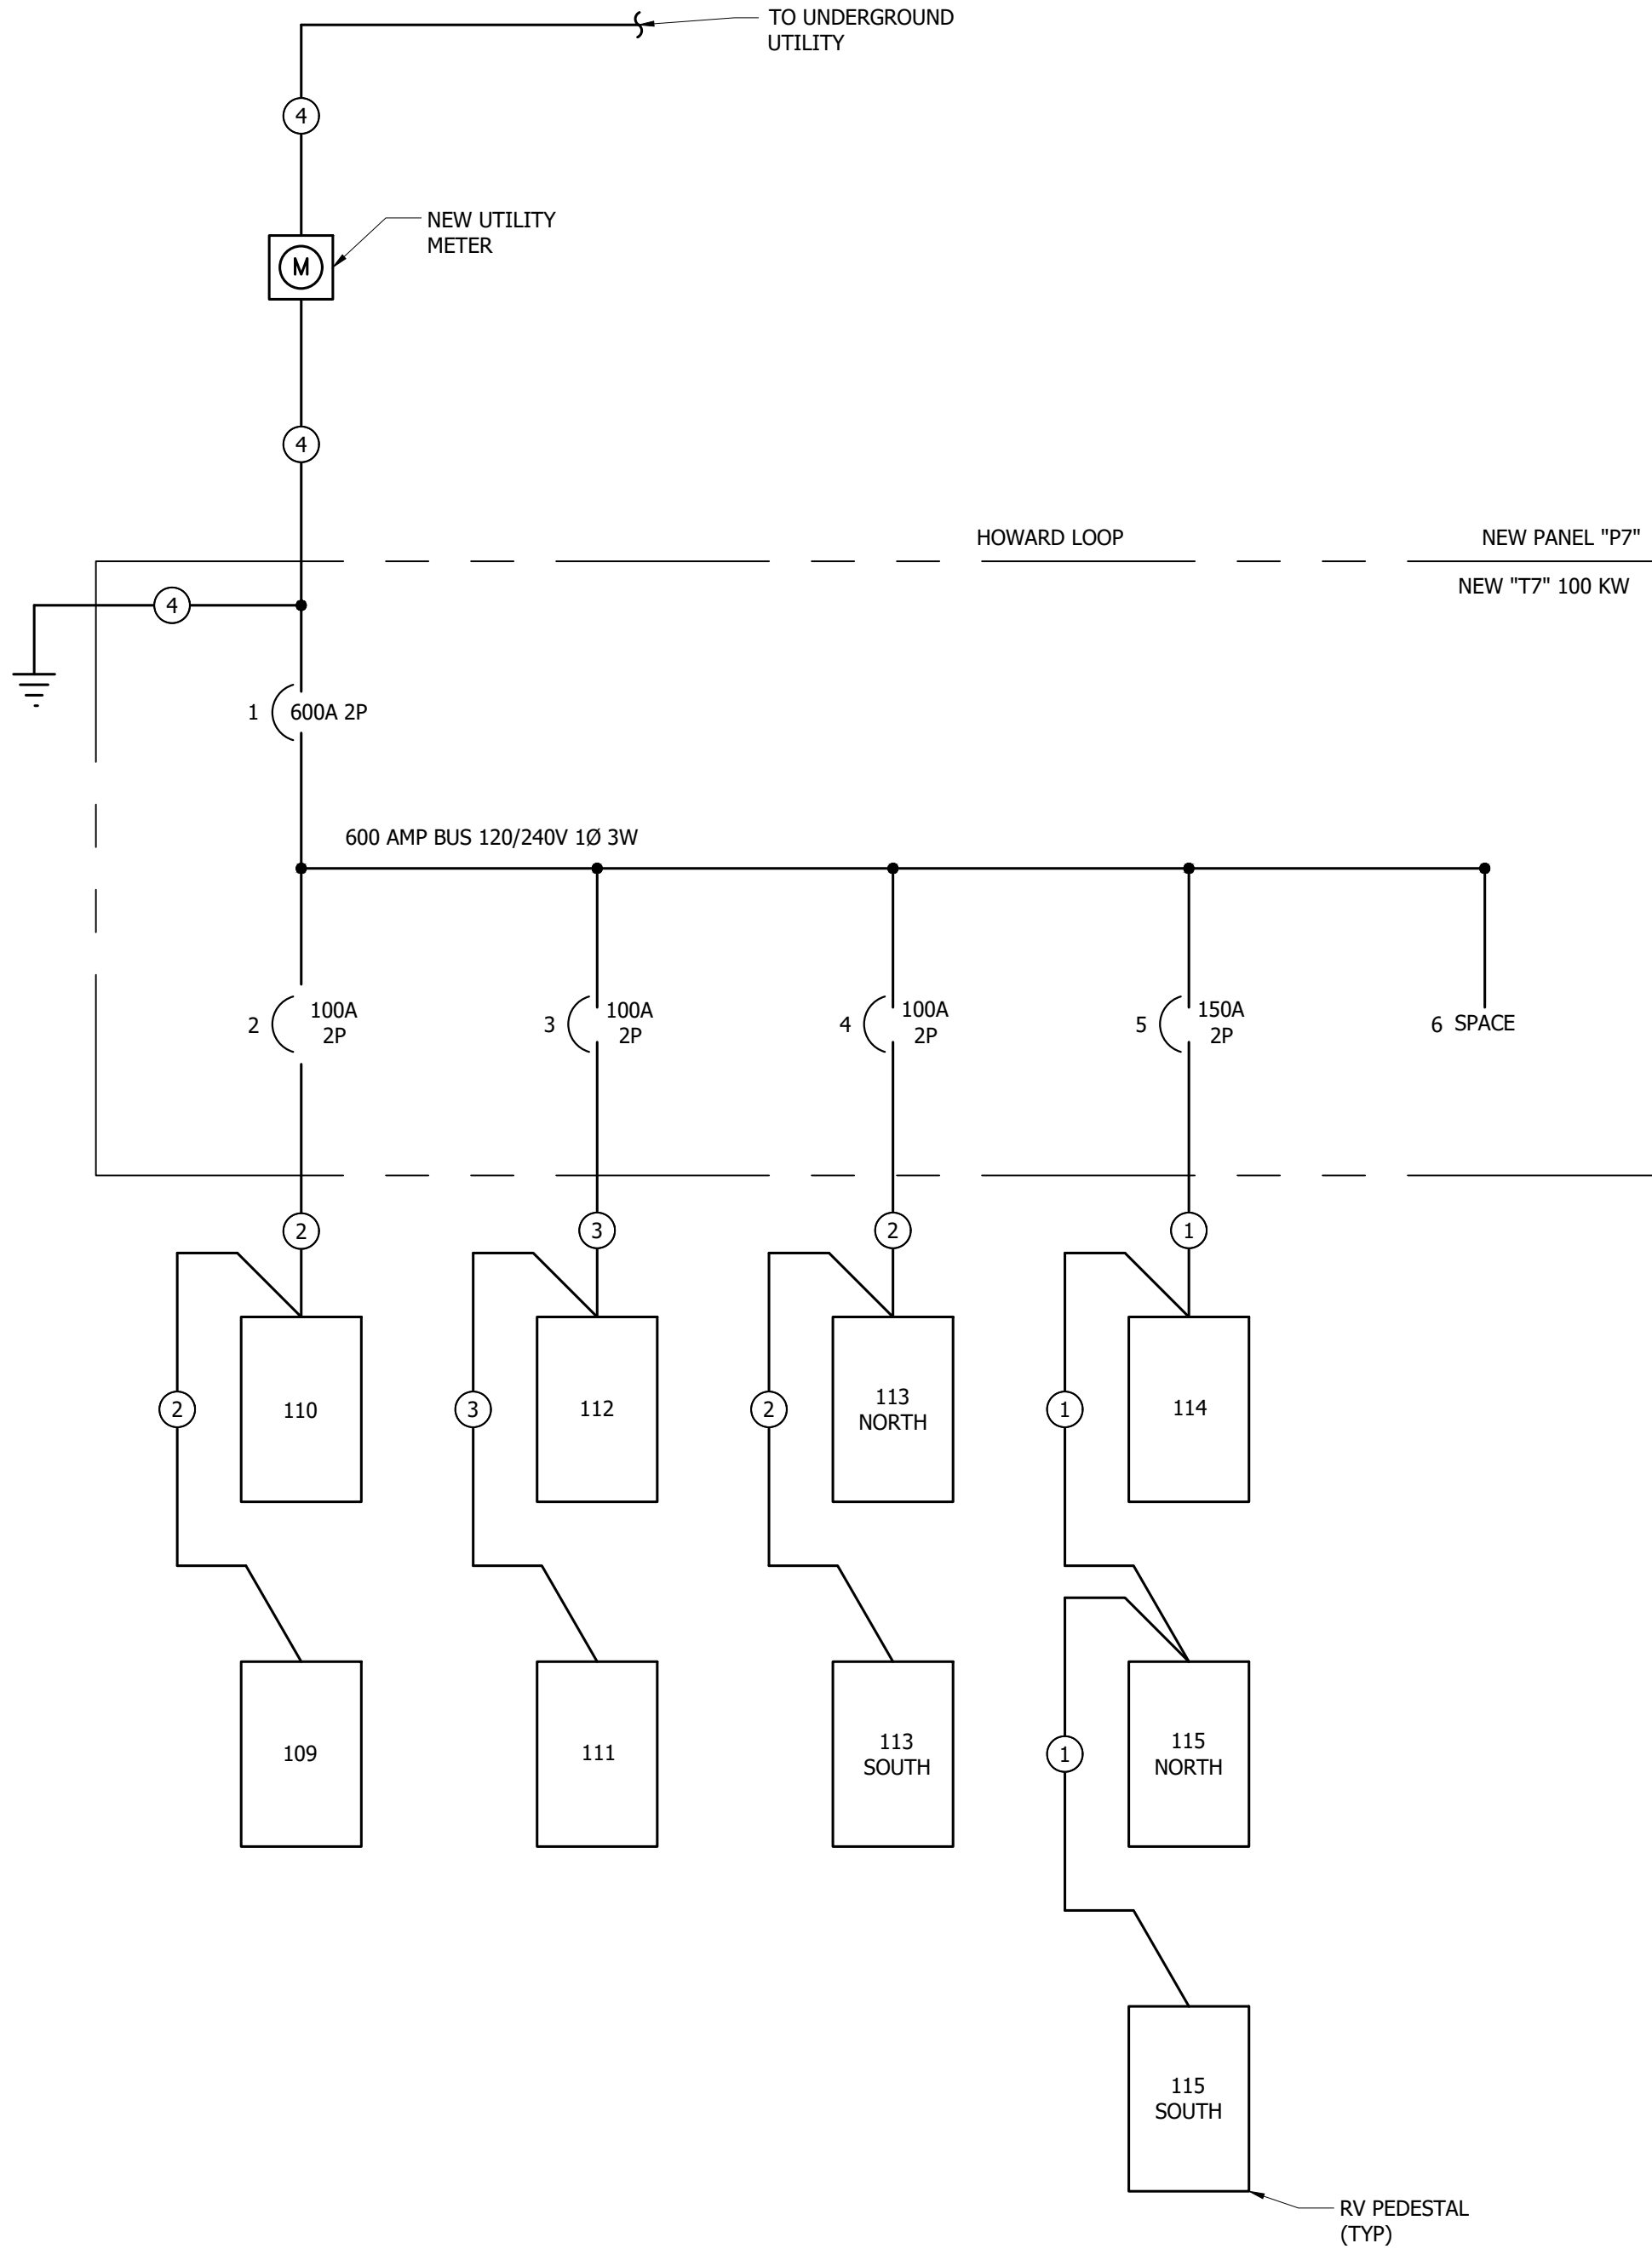

### FEEDER SCHEDULE:

- ① 3-3/0 DIRECT BURY CABLE WITH 3/0G.(BASED ON COPPER)
- ② 3-1 DIRECT BURY CABLE WITH 1G.(BASED ON COPPER)
- ③ 3-3 DIRECT BURY CABLE WITH 3G. (BASED ON COPPER)
- ④ REFER TO ELECTRICAL IMPROVEMENT RISER DIAGRAM.

ALL POWER OUTLET PEDESTALS ARE BASED ON MIDWEST U075 GP6 POWER OUTLET PANELS W/ 100 AMP MAINS. 1-50 AMP, 2P BKR & 50AMP 240 VOLT RECEPTACLE, 1-30 AMP 1P BKR & 30 AMP 120 VOLT RECEPTACLE, AND 1-20 AMP 1P GFI BKR & 120 VOLT DUPLEX RECEPTACLE.

- 1 - PROVIDE PANELS WHICH ARE NEMA 3R & SERVICE ENTRANCE RATED.
- 2 - REFER TO IMPROVEMENT PLAN GI-E-111 FOR FEEDER LAYOUT. UNLESS NOTED OTHERWISE, TYPE USE, LISTED FOR DIRECT BURIAL. DIRECT BURIAL AND LIGHTING CIRCUIT WIRING BASED ON COPPER. E/C TO PROVIDE ALTERNATE PRICE FOR ALUMINUM.
- 3 - PROVIDE FEED-THRU GROUNDING STRAP AT EACH NEW PEDESTAL WHICH IS NOT AT THE END OF A CIRCUIT. CONNECT STRAP BETWEEN INCOMING AND OUTGOING GROUNDING CONDUCTORS. PROVIDE GROUND ROD AT EACH PEDESTAL. DO NOT CONNECT GROUND LUG TO NEUTRAL LUG.
- 4 - REFER TO FLUSH GRADE JUNCTION BOX DETAIL FOR BOTH PREDETERMINED JUNCTION BOX LOCATIONS ON PLANS AND FOR AREAS THAT MAY REQUIRE JUNCTION BOXES FOR PULLING WIRE.

6 "P7" ELECTRICAL WIRING DIAGRAM (HOWARD LOOP)  
NOT TO SCALE

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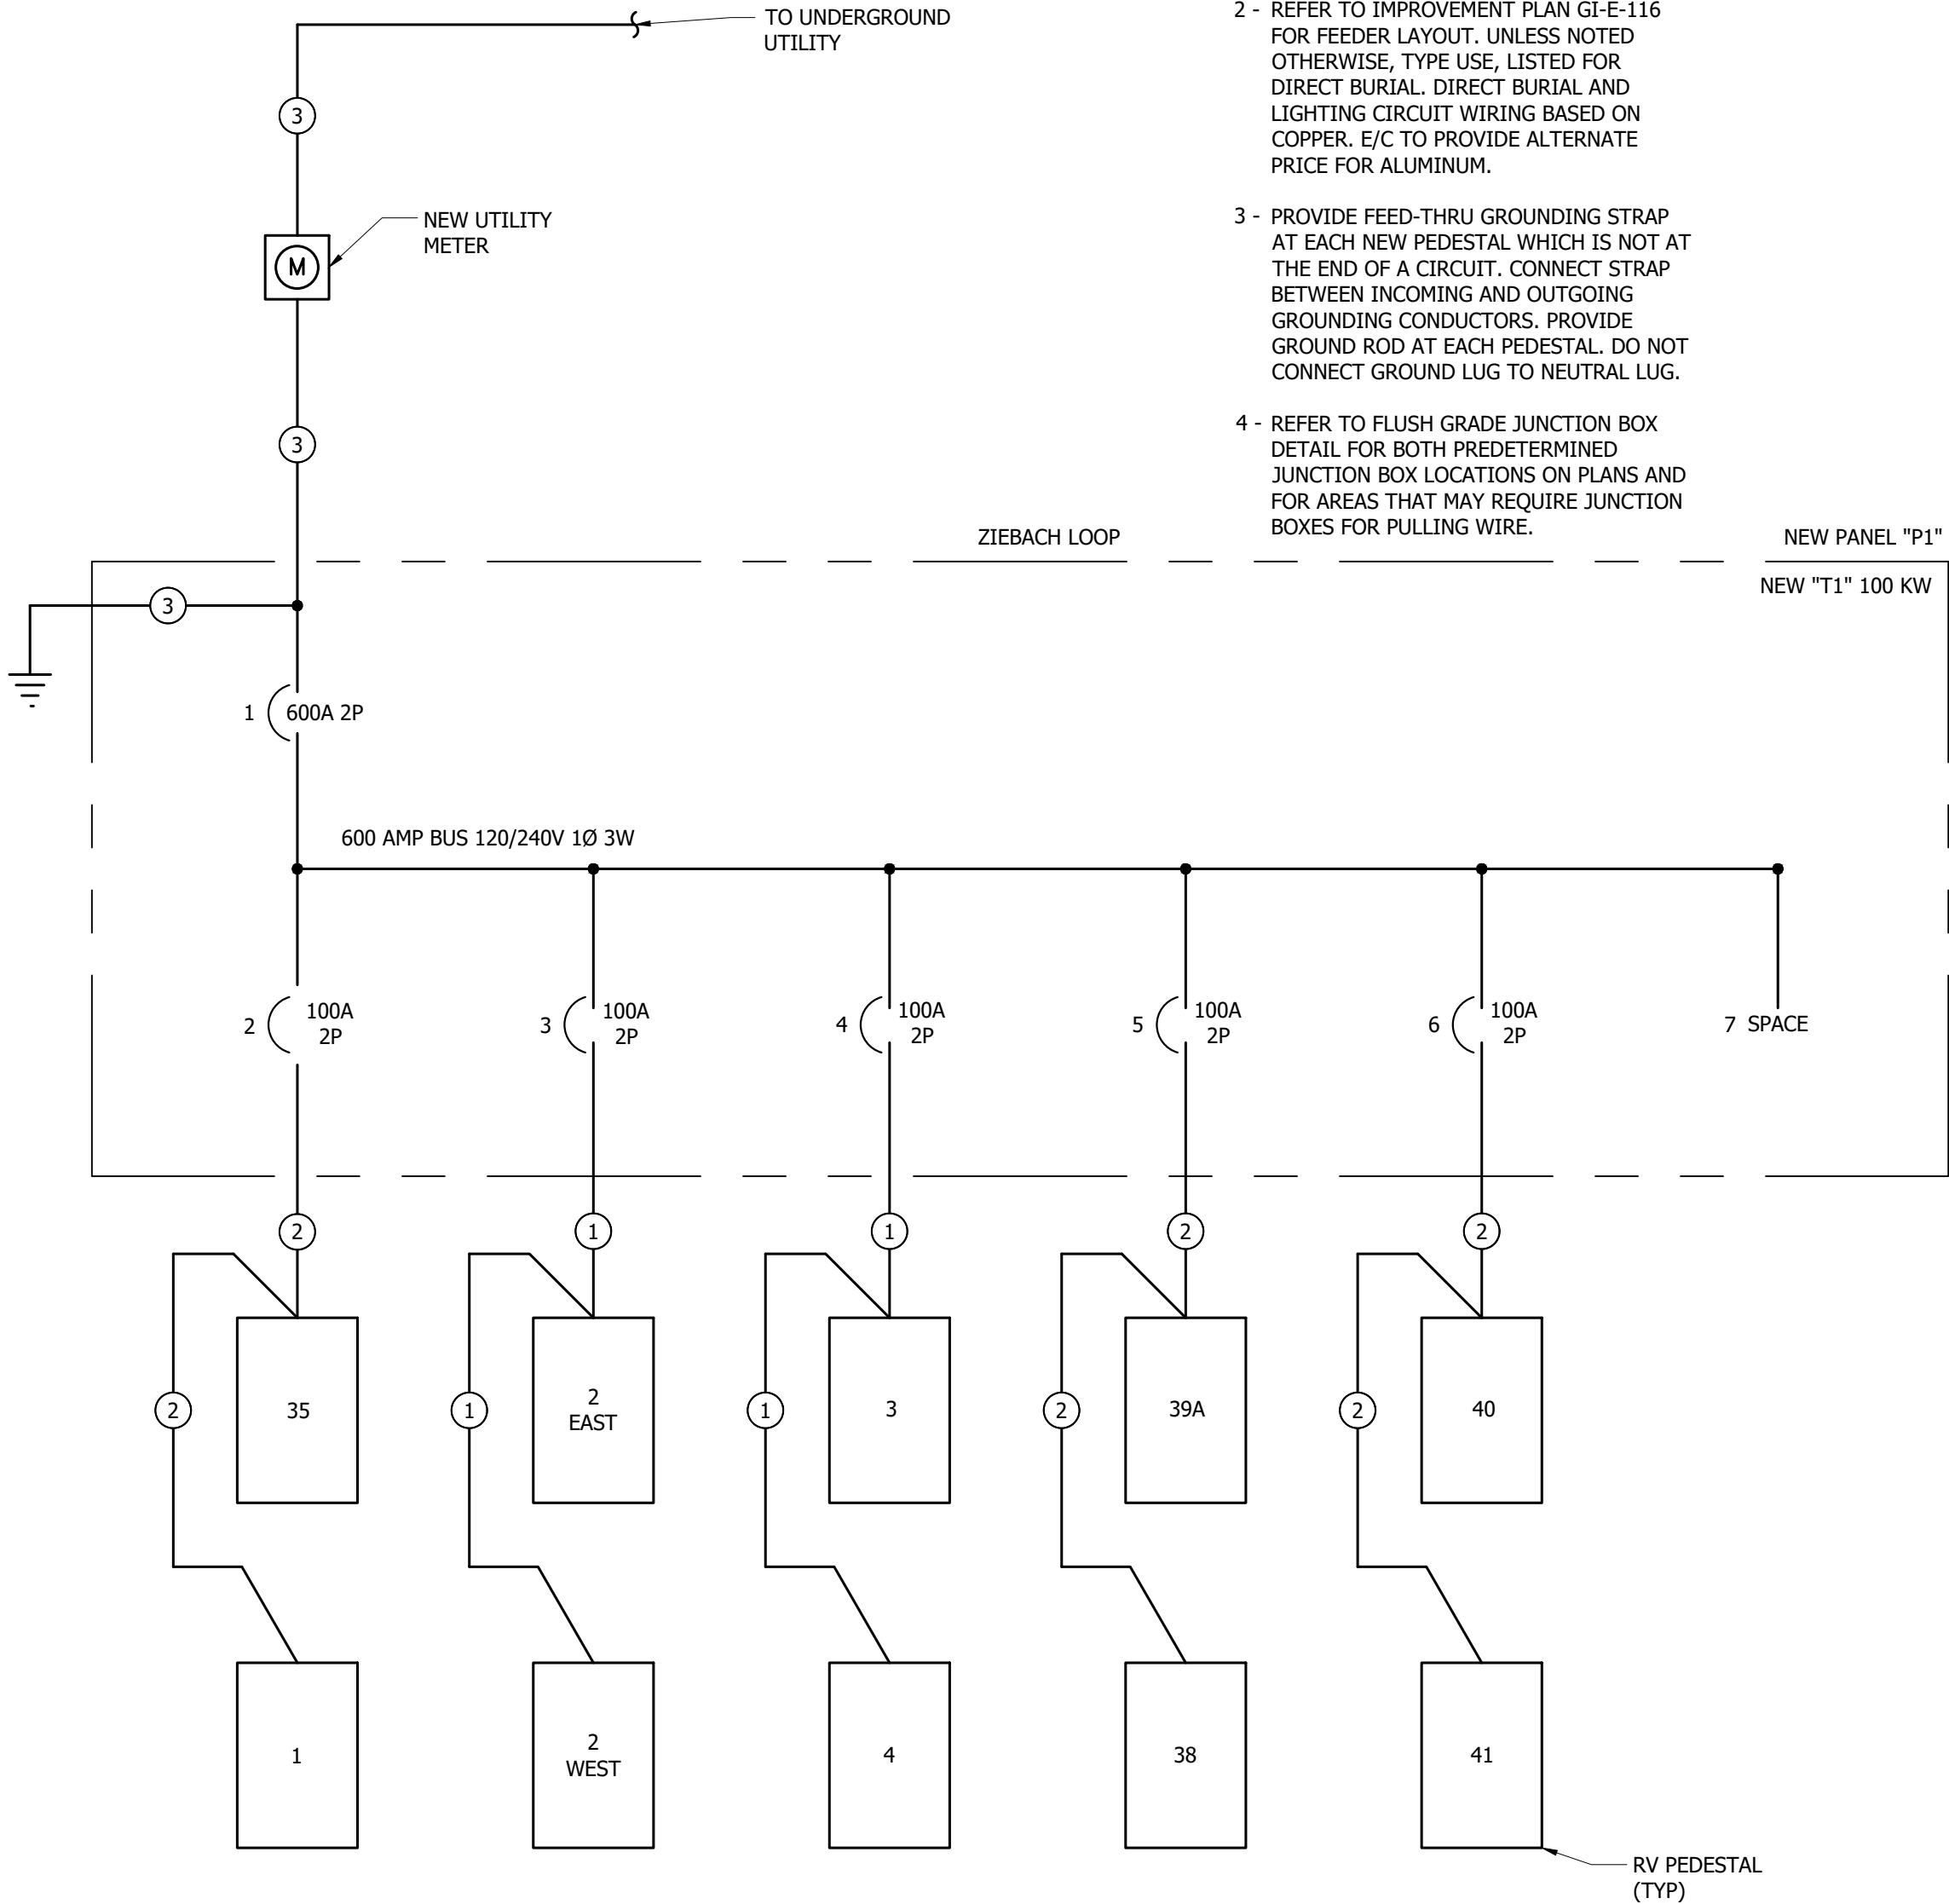
**ELECTRICAL DETAILS**  
**GRAHAM'S ISLAND STATE PARK**  
**NORTH DAKOTA PARKS & RECREATION DEPARTMENT**  
**ELECTRICAL UPGRADES**  
**BISMARCK, NORTH DAKOTA**



DESIGNED BY:	ARH
DRAWN BY:	ARH-SDM
APPROVED BY:	MSV
DESIGN PROJ:	21219.000
CONST PROJ:	
SCALE:	AS NOTED
DATE:	04-24-2023
DRAWING NO:	<b>GI-E-505</b>
SHEET NO:	25 of 32



Last edit on: 4/21/2023 12:11 PM by: SDW01521 Drawing Name: F:\Proj\21000\21219\21219\000\AutoCad\Plan Set\Graham's Island\21219.000E - Electrical Details - GISP.dwg Layout Name: ELECTRICAL DETAILS 6 - GISP Picked By: SDW01521 Picked on: 4/24/2023 2:21:54 PM



ALL POWER OUTLET PEDESTALS ARE BASED ON MIDWEST U075 GP6 POWER OUTLET PANELS W/ 100 AMP MAINS. 1-50 AMP, 2P BKR & 50AMP 240 VOLT RECEPTACLE, 1-30 AMP 1P BKR & 30 AMP 120 VOLT RECEPTACLE, AND 1-20 AMP 1P GFI BKR & 120 VOLT DUPLEX RECEPTACLE.

1 - PROVIDE PANELS WHICH ARE NEMA 3R & SERVICE ENTRANCE RATED.

2 - REFER TO IMPROVEMENT PLAN GI-E-116 FOR FEEDER LAYOUT. UNLESS NOTED OTHERWISE, TYPE USE, LISTED FOR DIRECT BURIAL. DIRECT BURIAL AND LIGHTING CIRCUIT WIRING BASED ON COPPER. E/C TO PROVIDE ALTERNATE PRICE FOR ALUMINUM.


3 - PROVIDE FEED-THRU GROUNDING STRAP AT EACH NEW PEDESTAL WHICH IS NOT AT THE END OF A CIRCUIT. CONNECT STRAP BETWEEN INCOMING AND OUTGOING GROUNDING CONDUCTORS. PROVIDE GROUND ROD AT EACH PEDESTAL. DO NOT CONNECT GROUND LUG TO NEUTRAL LUG.

4 - REFER TO FLUSH GRADE JUNCTION BOX DETAIL FOR BOTH PREDETERMINED JUNCTION BOX LOCATIONS ON PLANS AND FOR AREAS THAT MAY REQUIRE JUNCTION BOXES FOR PULLING WIRE.

11 "P1" ELECTRICAL WIRING DIAGRAM (ZIEBACH LOOP)  
NOT TO SCALE

FEEDER SCHEDULE:

- 3-2 DIRECT BURY CABLE WITH 2G. (BASED ON COPPER)
- 3-3 DIRECT BURY CABLE WITH 3G. (BASED ON COPPER)
- REFER TO ELECTRICAL IMPROVEMENT RISER DIAGRAM.

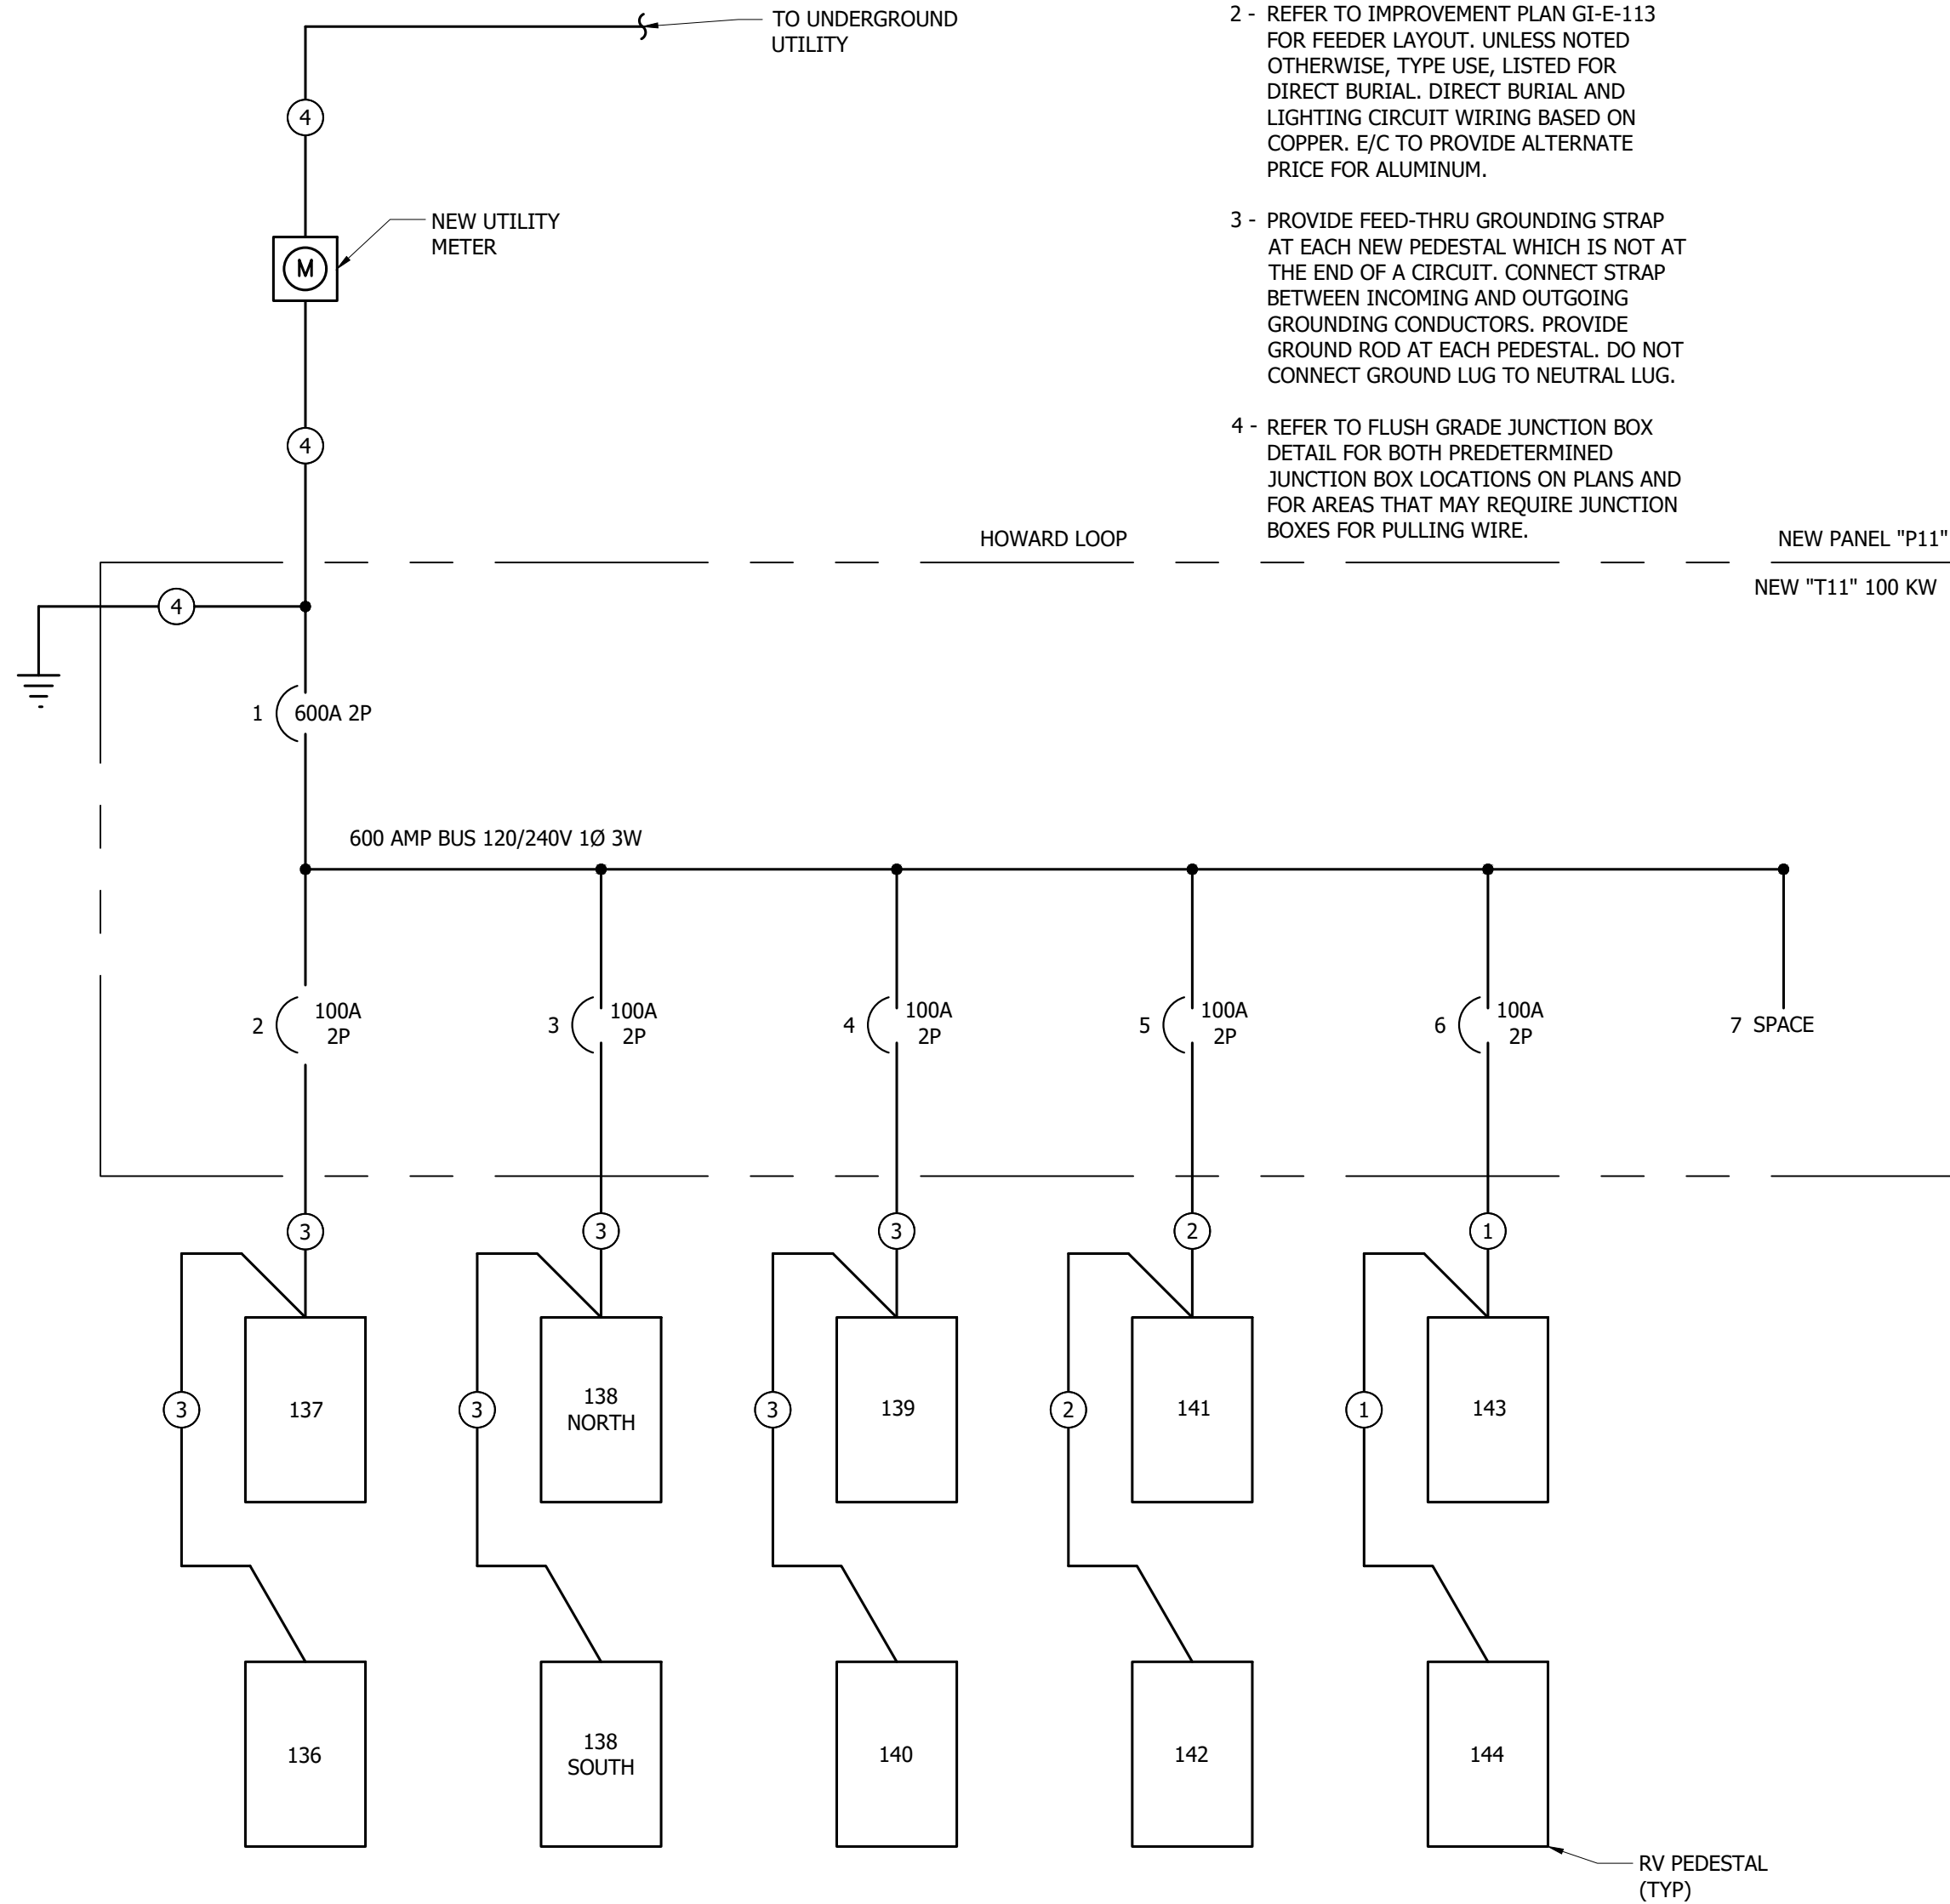

ALL POWER OUTLET PEDESTALS ARE BASED ON MIDWEST U075 GP6 POWER OUTLET PANELS W/ 100 AMP MAINS. 1-50 AMP, 2P BKR & 50AMP 240 VOLT RECEPTACLE, 1-30 AMP 1P BKR & 30 AMP 120 VOLT RECEPTACLE, AND 1-20 AMP 1P GFI BKR & 120 VOLT DUPLEX RECEPTACLE.

1 - PROVIDE PANELS WHICH ARE NEMA 3R & SERVICE ENTRANCE RATED.

2 - REFER TO IMPROVEMENT PLAN GI-E-113 FOR FEEDER LAYOUT. UNLESS NOTED OTHERWISE, TYPE USE, LISTED FOR DIRECT BURIAL. DIRECT BURIAL AND LIGHTING CIRCUIT WIRING BASED ON COPPER. E/C TO PROVIDE ALTERNATE PRICE FOR ALUMINUM.

3 - PROVIDE FEED-THRU GROUNDING STRAP AT EACH NEW PEDESTAL WHICH IS NOT AT THE END OF A CIRCUIT. CONNECT STRAP BETWEEN INCOMING AND OUTGOING GROUNDING CONDUCTORS. PROVIDE GROUND ROD AT EACH PEDESTAL. DO NOT CONNECT GROUND LUG TO NEUTRAL LUG.

4 - REFER TO FLUSH GRADE JUNCTION BOX DETAIL FOR BOTH PREDETERMINED JUNCTION BOX LOCATIONS ON PLANS AND FOR AREAS THAT MAY REQUIRE JUNCTION BOXES FOR PULLING WIRE.

10 "P11" ELECTRICAL WIRING DIAGRAM (HOWARD LOOP)  
NOT TO SCALE


FEEDER SCHEDULE:

- 3-1/0 DIRECT BURY CABLE WITH 1/0G. (BASED ON COPPER)
- 3-2 DIRECT BURY CABLE WITH 2G. (BASED ON COPPER)
- 3-3 DIRECT BURY CABLE WITH 3G. (BASED ON COPPER)
- REFER TO ELECTRICAL IMPROVEMENT RISER DIAGRAM.

**Bartlett & West**


3456 E CENTURY AVENUE - BISMARCK, ND 58503  
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**ELECTRICAL DETAILS**  
**GRAHAM'S ISLAND STATE PARK**  
**NORTH DAKOTA PARKS & RECREATION DEPARTMENT**  
**ELECTRICAL UPGRADES**  
**BISMARCK, NORTH DAKOTA**

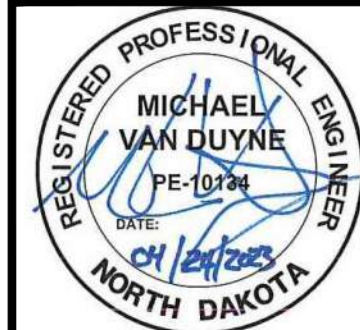

DESIGNED BY:	ARH
DRAWN BY:	ARH/SDM
APPROVED BY:	MSV
DESIGN PROJ:	21219.000
CONST PROJ:	
SCALE:	AS NOTED
DATE:	04-24-2023
DRAWING NO:	<b>GI-E-507</b>
SHEET NO:	


Last edit on: 4/21/2023 12:11 PM by: SDM01521 Drawing Name: F:\proj\21000\21219\01219\000\AutoCad\Plan Set\Graham's Island\01219\_000E - Electrical Details - GSIP.dwg Layout Name: ELECTRICAL DETAILS 7 - GSIP Picked By: SDM01521 Picked on: 4/24/2023 2:21:55 PM

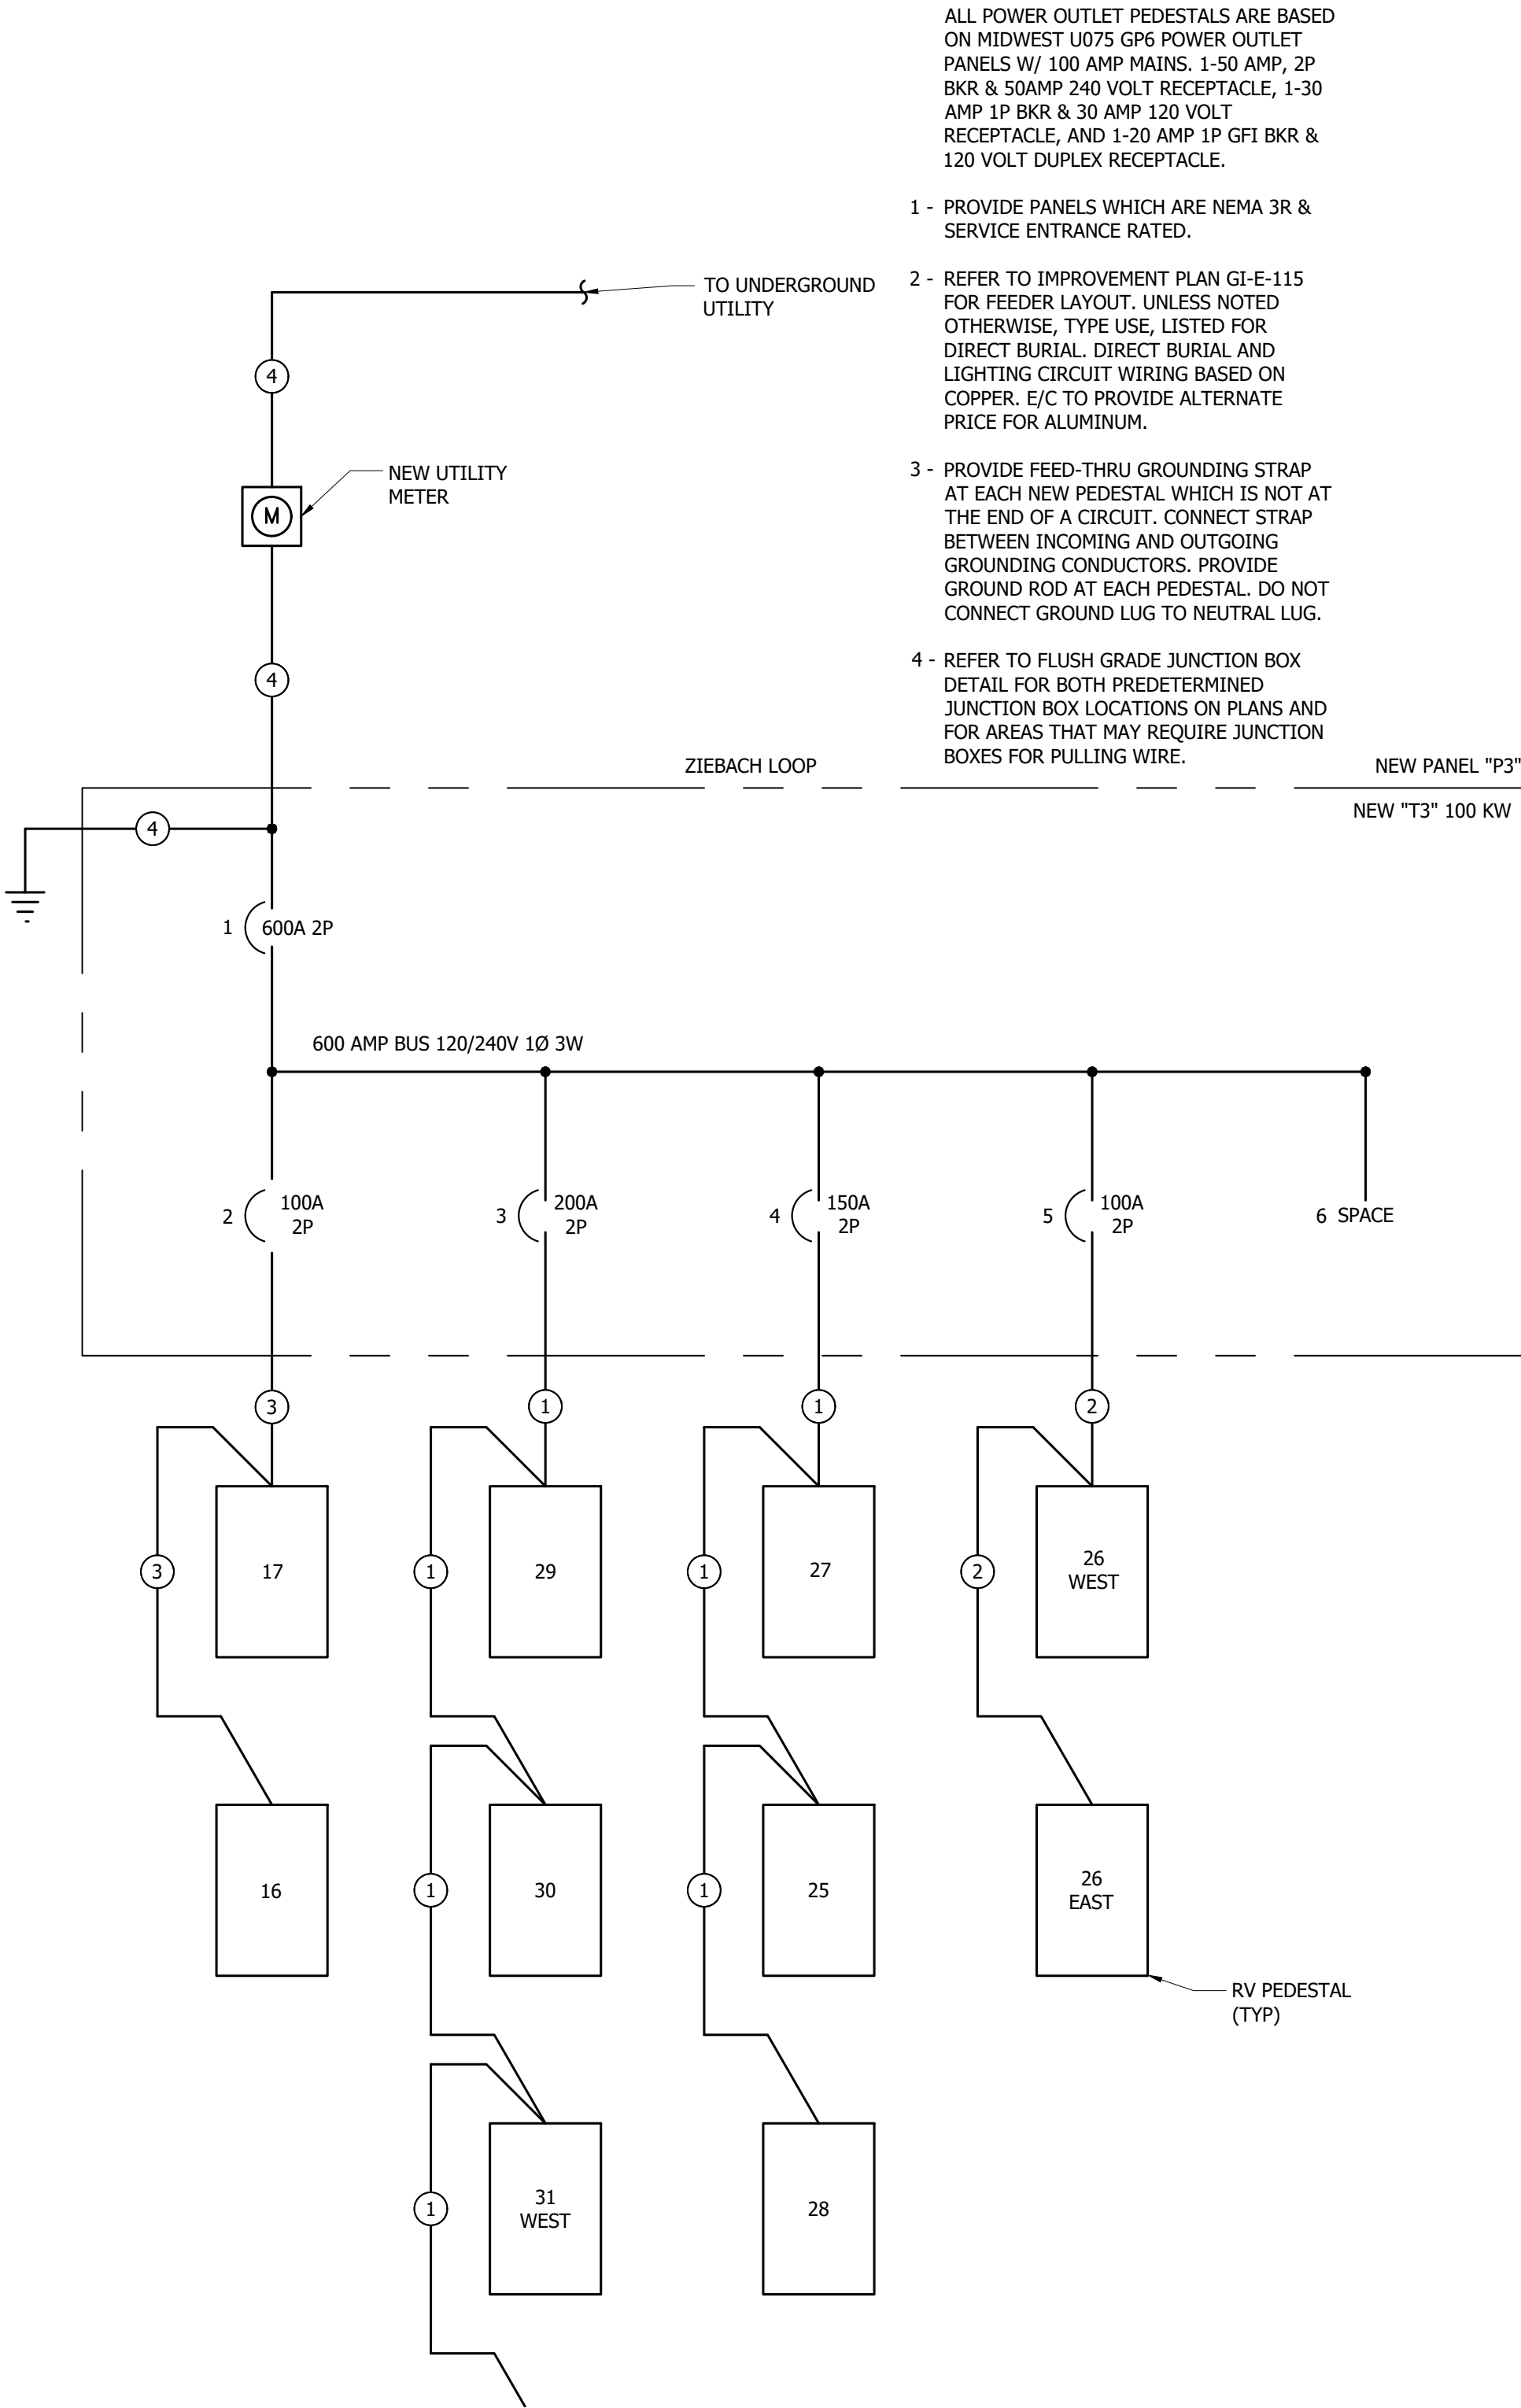

13 "P3" ELECTRICAL WIRING DIAGRAM (ZIEBACH LOOP)  
NOT TO SCALE

FEEDER SCHEDULE:

- 3-1/0 DIRECT BURY CABLE WITH 1/0G. (BASED ON COPPER)
- 3-2/0 DIRECT BURY CABLE WITH 1G. (BASED ON COPPER)
- 3-2 DIRECT BURY CABLE WITH 2G. (BASED ON COPPER)
- REFER TO ELECTRICAL IMPROVEMENT RISER DIAGRAM.

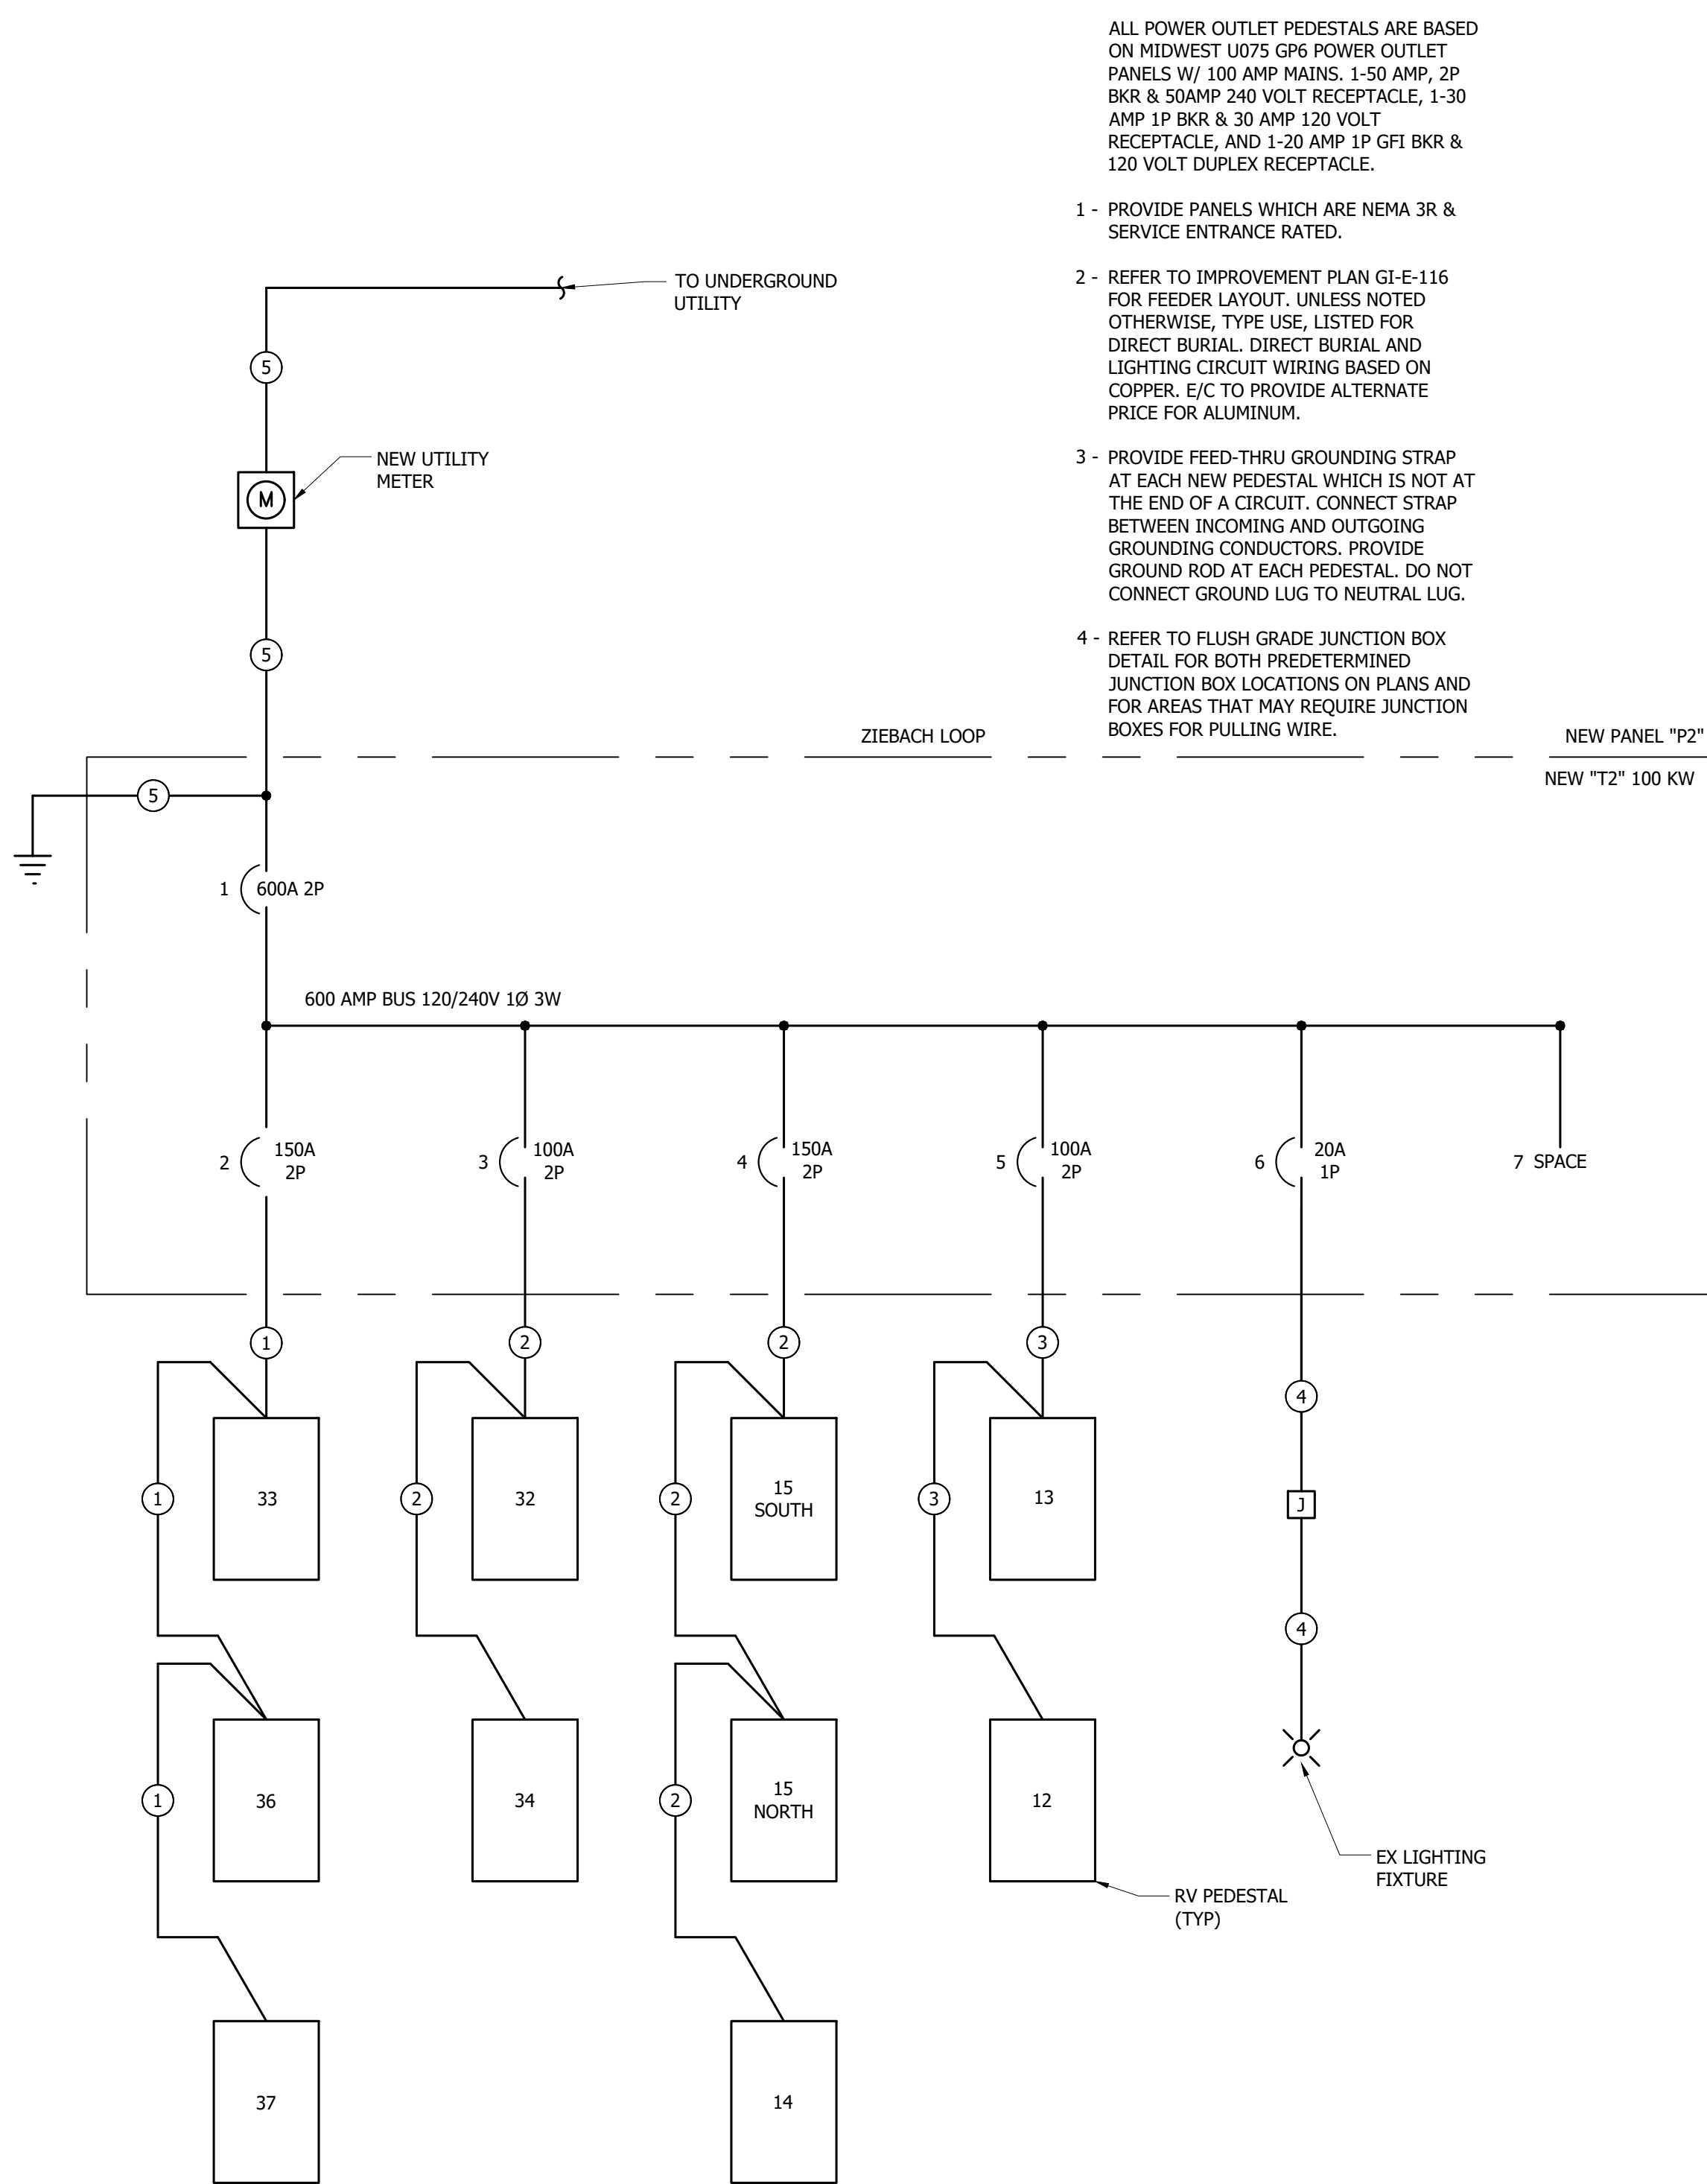

12 "P2" ELECTRICAL WIRING DIAGRAM (ZIEBACH LOOP)  
NOT TO SCALE


FEEDER SCHEDULE:

- 3-2/0 DIRECT BURY CABLE WITH 3/0G.(BASED ON COPPER)
- 3-1/0 DIRECT BURY CABLE WITH 1G. (BASED ON COPPER)
- 3-2 DIRECT BURY CABLE WITH 3G. (BASED ON COPPER)
- 2-10 DIRECT BURY CABLE WITH 1-10G. (BASED ON COPPER)
- REFER TO ELECTRICAL IMPROVEMENT RISER DIAGRAM.

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PHONE 701-258-1110 - FAX 701-258-1111  
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**ELECTRICAL DETAILS**  
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**NORTH DAKOTA PARKS & RECREATION DEPARTMENT**  
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**BISMARCK, NORTH DAKOTA**




DESIGNED BY:	ARH
DRAWN BY:	ARH/SDM
APPROVED BY:	MSV
DESIGN PROJ:	21219.000
CONST PROJ:	
SCALE:	AS NOTED
DATE:	04-24-2023
DRAWING NO:	GI-E-508
SHEET NO:	28 of 32
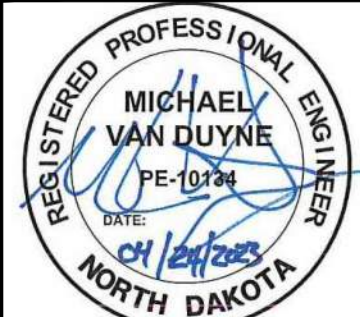
## FEEDER SCHEDULE:

- ① 3-2 DIRECT BURY CABLE WITH 2G.(BASED ON COPPER)
- ② 3-3 DIRECT BURY CABLE WITH 3G. (BASED ON COPPER)
- ③ 2-10 DIRECT BURY CABLE WITH 1-10G. (BASED ON COPPER)
- ④ REFER TO ELECTRICAL IMPROVEMENT RISER DIAGRAM.

ALL POWER OUTLET PEDESTALS ARE BASED ON MIDWEST U075 GP6 POWER OUTLET PANELS W/ 100 AMP MAINS. 1-50 AMP, 2P BKR & 50AMP 240 VOLT RECEPTACLE, 1-30 AMP 1P BKR & 30 AMP 120 VOLT RECEPTACLE, AND 1-20 AMP 1P GFI BKR & 120 VOLT DUPLEX RECEPTACLE.

- 1 - PROVIDE PANELS WHICH ARE NEMA 3R & SERVICE ENTRANCE RATED,
- 2 - REFER TO IMPROVEMENT PLAN GI-E-116 FOR FEEDER LAYOUT. UNLESS NOTED OTHERWISE, TYPE USE, LISTED FOR DIRECT BURIAL. DIRECT BURIAL AND LIGHTING CIRCUIT WIRING BASED ON COPPER. E/C TO PROVIDE ALTERNATE PRICE FOR ALUMINUM.
- 3 - PROVIDE FEED-THRU GROUNDING STRAP AT EACH NEW PEDESTAL WHICH IS NOT AT THE END OF A CIRCUIT. CONNECT STRAP BETWEEN INCOMING AND OUTGOING GROUNDING CONDUCTORS. PROVIDE GROUND ROD AT EACH PEDESTAL. DO NOT CONNECT GROUND LUG TO NEUTRAL LUG.
- 4 - REFER TO FLUSH GRADE JUNCTION BOX DETAIL FOR BOTH PREDETERMINED JUNCTION BOX LOCATIONS ON PLANS AND FOR AREAS THAT MAY REQUIRE JUNCTION BOXES FOR PULLING WIRE.

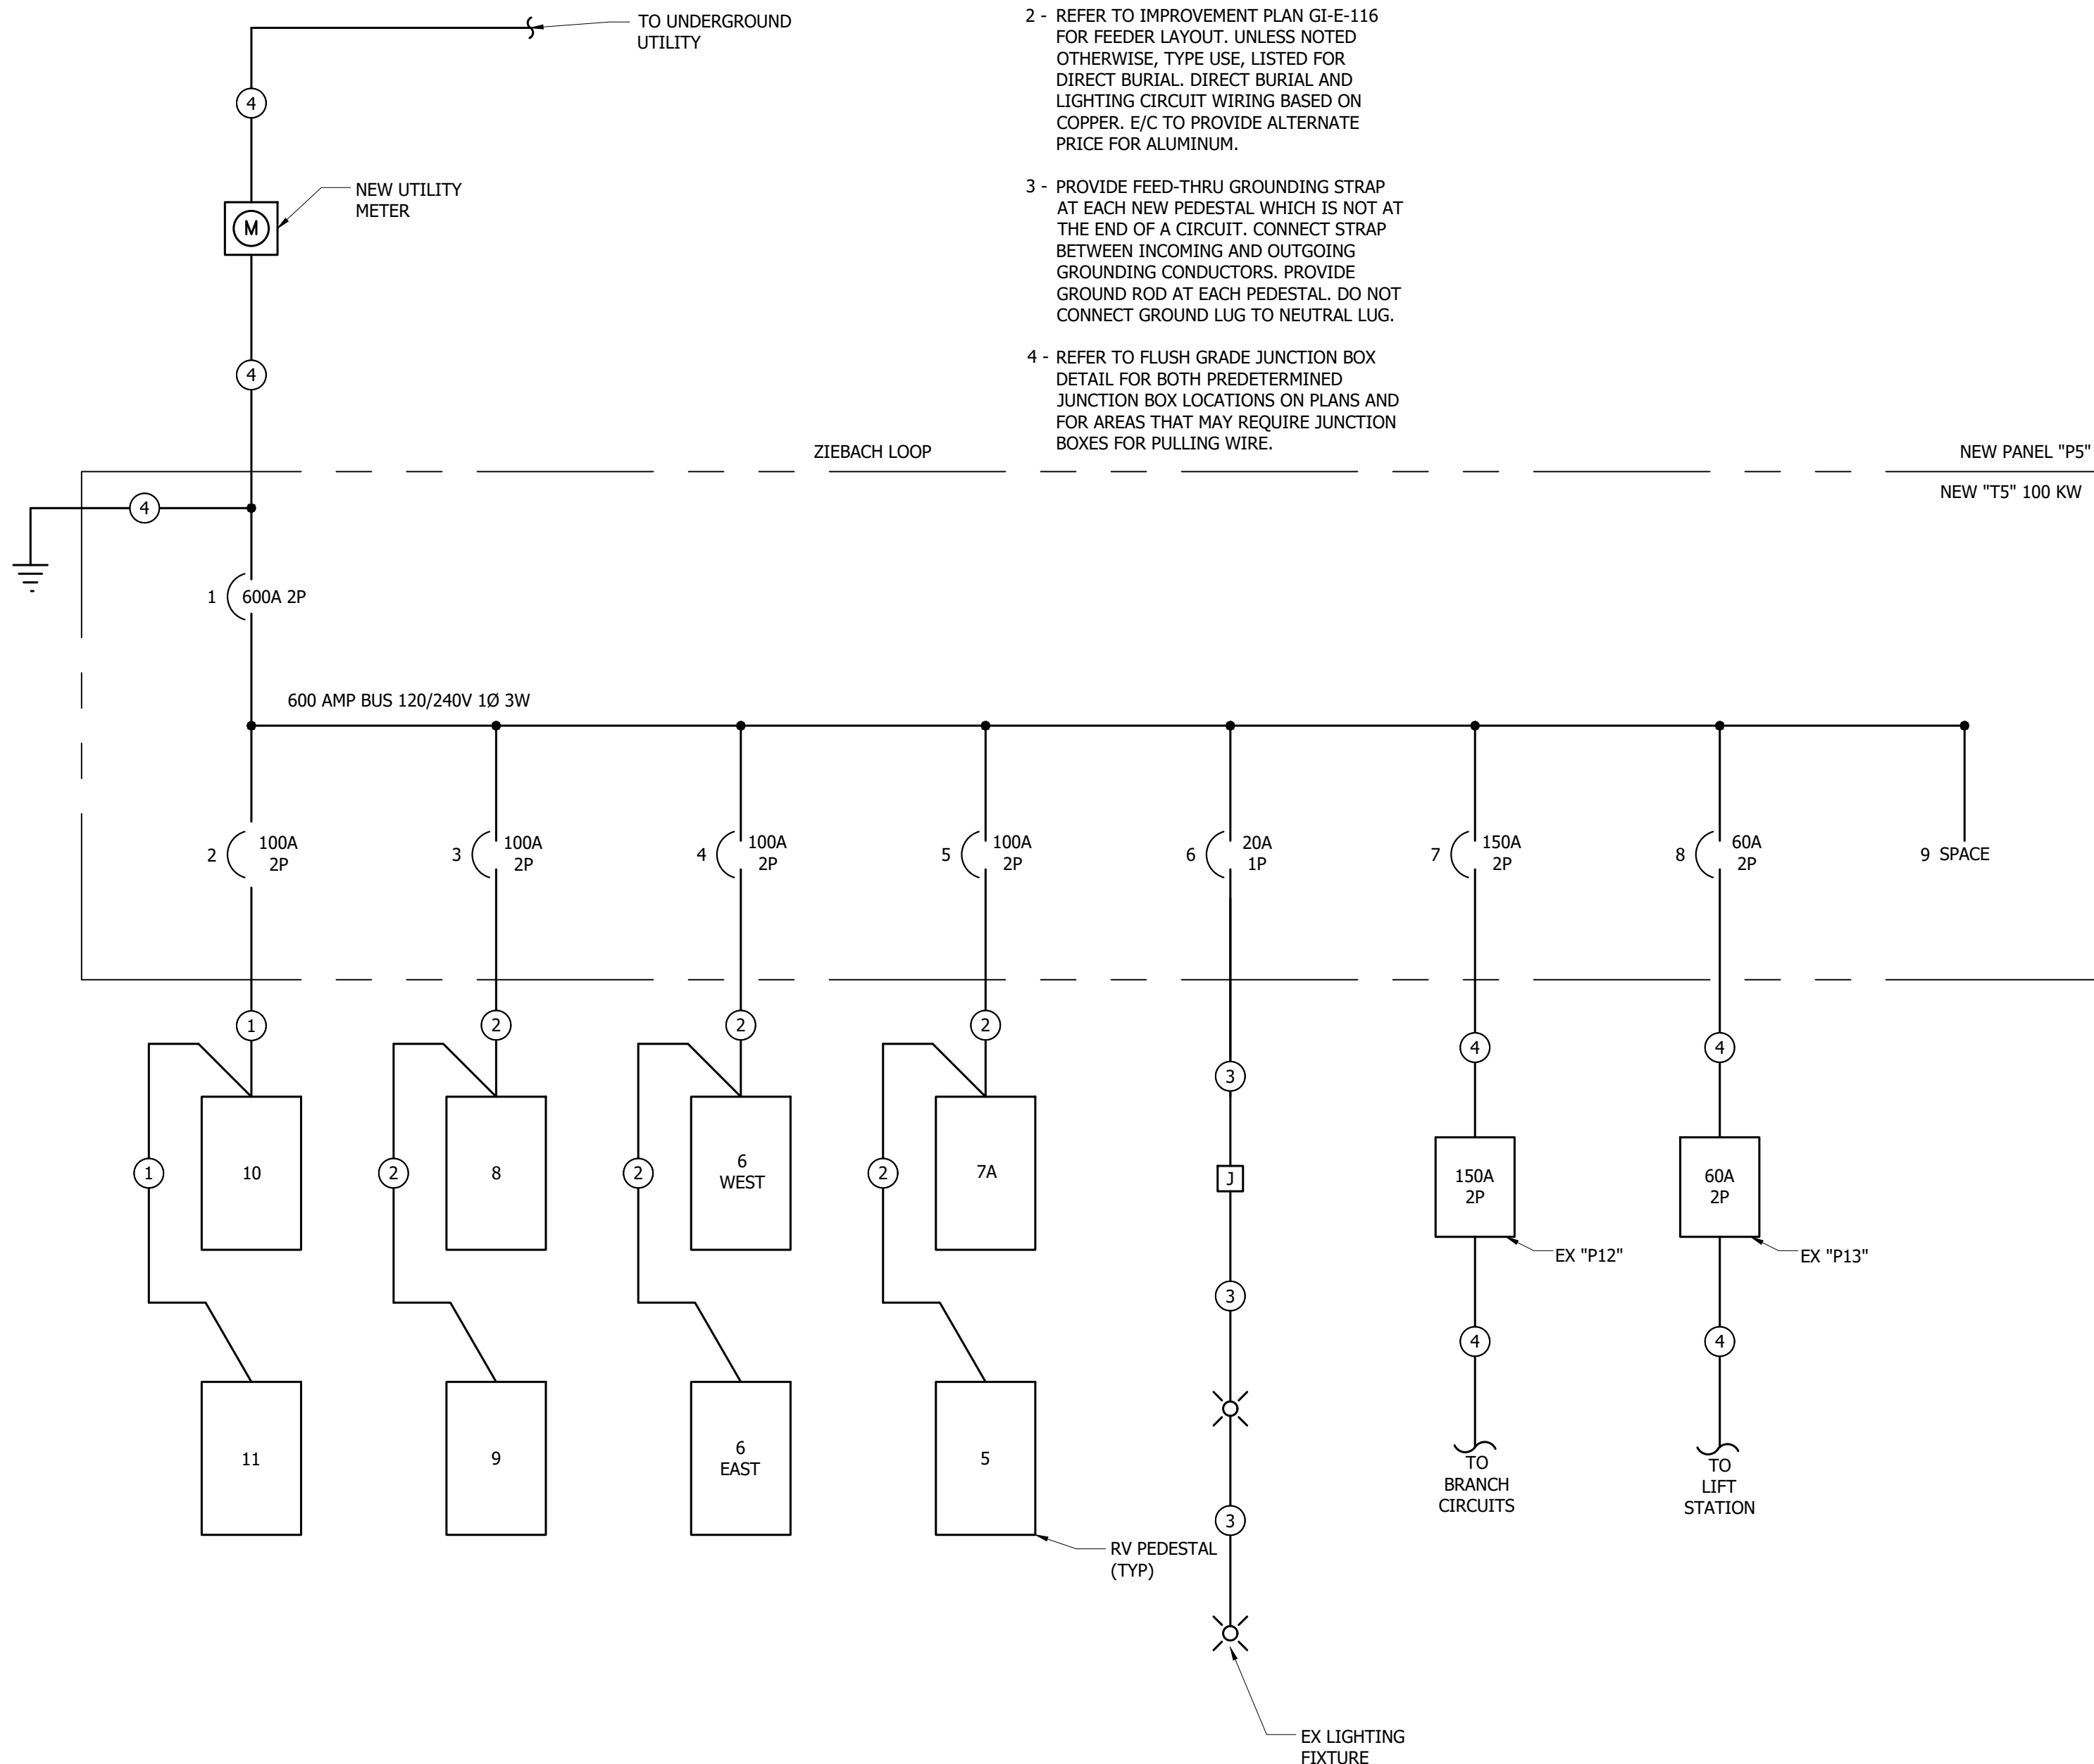


**15** "P5" ELECTRICAL WIRING DIAGRAM (ZIEBACH LOOP)  
NOT TO SCALE

## FEEDER SCHEDULE:

- ① 3-1 DIRECT BURY CABLE WITH 1G. (BASED ON COPPER)
- ② 3-3 DIRECT BURY CABLE WITH 3G. (BASED ON COPPER)
- ③ REFER TO ELECTRICAL IMPROVEMENT RISER DIAGRAM.

ALL POWER OUTLET PEDESTALS ARE BASED ON MIDWEST U075 GP6 POWER OUTLET PANELS W/ 100 AMP MAINS. 1-50 AMP, 2P BKR & 50AMP 240 VOLT RECEPTACLE, 1-30 AMP 1P BKR & 30 AMP 120 VOLT RECEPTACLE, AND 1-20 AMP 1P GFI BKR & 120 VOLT DUPLEX RECEPTACLE.

- 1 - PROVIDE PANELS WHICH ARE NEMA 3R & SERVICE ENTRANCE RATED.
- 2 - REFER TO IMPROVEMENT PLAN GI-E-115 FOR FEEDER LAYOUT. UNLESS NOTED OTHERWISE, TYPE USE, LISTED FOR DIRECT BURIAL, DIRECT BURIAL AND LIGHTING CIRCUIT WIRING BASED ON COPPER. E/C TO PROVIDE ALTERNATE PIPING FOR ALUMINUM.
- 3 - PROVIDE FEED-THRU GROUNDING STRAP AT EACH NEW PEDESTAL WHICH IS NOT AT THE END OF A CIRCUIT. CONNECT STRAP BETWEEN INCOMING AND OUTGOING GROUNDING CONDUCTORS. PROVIDE GROUND ROD AT EACH PEDESTAL. DO NOT CONNECT GROUND LUG TO NEUTRAL LUG.
- 4 - REFER TO FLUSH GRADE JUNCTION BOX DETAIL FOR BOTH PREDETERMINED JUNCTION BOX LOCATIONS ON PLANS AND FOR AREAS THAT MAY REQUIRE JUNCTION BOXES FOR PULLING WIRE.

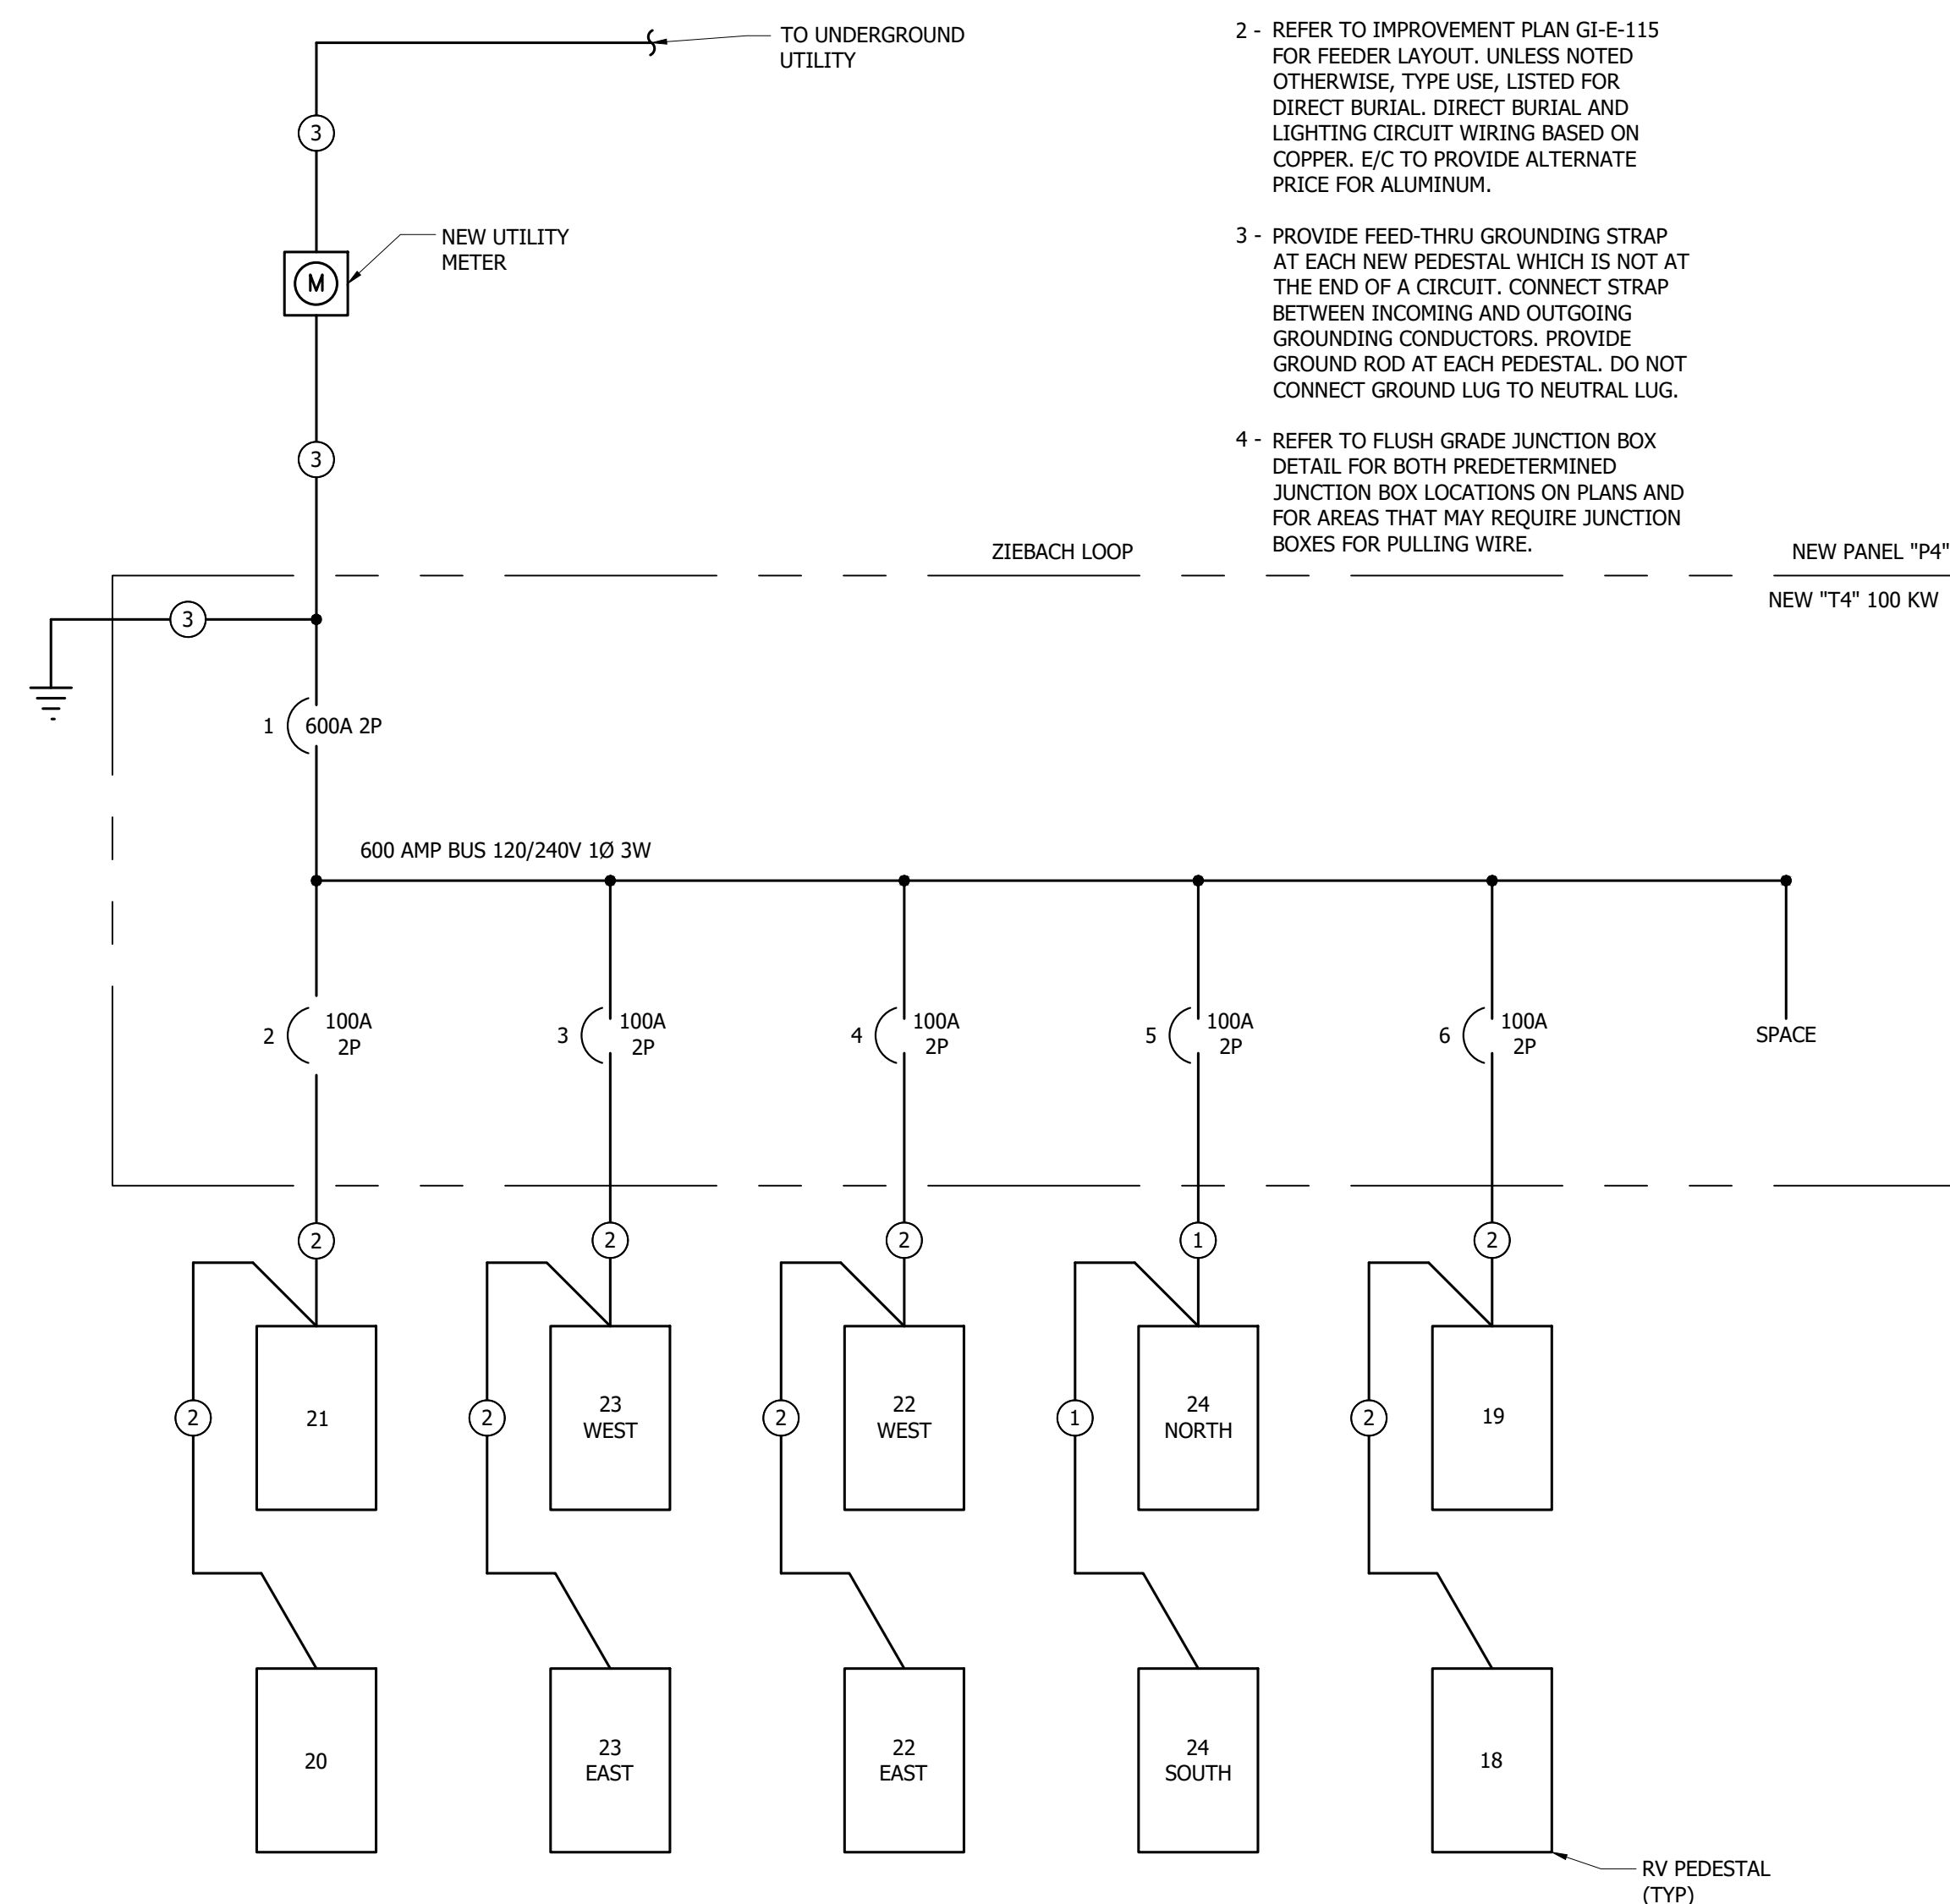

14 "P4" ELECTRICAL WIRING DIAGRAM (ZIEBACH LOOP)  
NOT TO SCALE


[illegible]

**Bartlett & West**

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PHONE 701-258-1110 - FAX 701-258-1111  
[www.bartlettwest.com](http://www.bartlettwest.com)

**ELECTRICAL DETAILS**  
**GRAHAMS ISLAND STATE PARK**

**NORTH DAKOTA PARKS & RECREATION DEPARTMENT**  
**ELECTRICAL UPGRADES**  
**BISMARCK, NORTH DAKOTA**

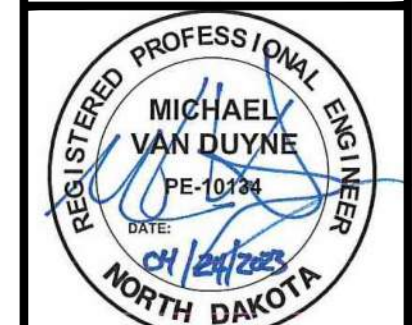

DESIGNED BY:	ARH
DRAWN BY:	ARH/SDM
APPROVED BY:	MSV
DESIGN PROJ:	21219.000
CONST PROJ:	
SCALE:	AS NOTED
DATE:	04-24-2023
DRAWING NO:	
<b>GI-E-509</b>	
SHEET NO:	

RV PEDESTAL SCHEDULE - HOWARD LOOP

MARK	MFR	MODEL	AMPERAGE	VOLTAGE	POLES	"P6" CIRCUIT #	"P7" CIRCUIT #	"P8" CIRCUIT #	"P9" CIRCUIT #	"P10" CIRCUIT #	"P11" CIRCUIT #	RECEPTACLES	ENCLOSURE TYPE	NOTES
"EP100"	MIDWEST	U075GP6	100	240	2	2						50A/2P, 30A/1P, 20A/1P	NEMA 3R	2,3
"EP101"	MIDWEST	U075GP6	100	240	2	2						50A/2P, 30A/1P, 20A/1P	NEMA 3R	2,3
"EP102"	MIDWEST	U075GP6	100	240	2	3						50A/2P, 30A/1P, 20A/1P	NEMA 3R	2,3
"EP103"	MIDWEST	U075GP6	100	240	2	3						50A/2P, 30A/1P, 20A/1P	NEMA 3R	2,3
"EP104"	MIDWEST	U075GP6	100	240	2	4						50A/2P, 30A/1P, 20A/1P	NEMA 3R	2,3
"EP105"	MIDWEST	U075GP6	100	240	2	4						50A/2P, 30A/1P, 20A/1P	NEMA 3R	1,3
"EP106"	MIDWEST	U075GP6	100	240	2	5						50A/2P, 30A/1P, 20A/1P	NEMA 3R	2,3
"EP107"	MIDWEST	U075GP6	100	240	2	5						50A/2P, 30A/1P, 20A/1P	NEMA 3R	2,3
"EP108"	MIDWEST	U075GP6	100	240	2	5						50A/2P, 30A/1P, 20A/1P	NEMA 3R	2,3
"EP109"	MIDWEST	U075GP6	100	240	2		2					50A/2P, 30A/1P, 20A/1P	NEMA 3R	2,3
"EP110"	MIDWEST	U075GP6	100	240	2		2					50A/2P, 30A/1P, 20A/1P	NEMA 3R	2,3
"EP111"	MIDWEST	U075GP6	100	240	2		3					50A/2P, 30A/1P, 20A/1P	NEMA 3R	2,3
"EP112"	MIDWEST	U075GP6	100	240	2		3					50A/2P, 30A/1P, 20A/1P	NEMA 3R	1,3
"EP113N"	MIDWEST	U075GP6	100	240	2		4					50A/2P, 30A/1P, 20A/1P	NEMA 3R	2,3
"EP113S"	MIDWEST	U075GP6	100	240	2		4					50A/2P, 30A/1P, 20A/1P	NEMA 3R	2,3
"EP114"	MIDWEST	U075GP6	100	240	2		5					50A/2P, 30A/1P, 20A/1P	NEMA 3R	1,3
"EP115N"	MIDWEST	U075GP6	100	240	2		5					50A/2P, 30A/1P, 20A/1P	NEMA 3R	2,3
"EP115S"	MIDWEST	U075GP6	100	240	2		5					50A/2P, 30A/1P, 20A/1P	NEMA 3R	2,3
"EP116"	MIDWEST	U075GP6	100	240	2			2				50A/2P, 30A/1P, 20A/1P	NEMA 3R	1,3
"EP117"	MIDWEST	U075GP6	100	240	2			2				50A/2P, 30A/1P, 20A/1P	NEMA 3R	1,3
"EP118"	MIDWEST	U075GP6	100	240	2			3				50A/2P, 30A/1P, 20A/1P	NEMA 3R	2,3
"EP119N"	MIDWEST	U075GP6	100	240	2			4				50A/2P, 30A/1P, 20A/1P	NEMA 3R	2,3
"EP119S"	MIDWEST	U075GP6	100	240	2			4				50A/2P, 30A/1P, 20A/1P	NEMA 3R	2,3
"EP120"	MIDWEST	U075GP6	100	240	2			3				50A/2P, 30A/1P, 20A/1P	NEMA 3R	2,3
"EP121"	MIDWEST	U075GP6	100	240	2			5				50A/2P, 30A/1P, 20A/1P	NEMA 3R	2,3
"EP122"	MIDWEST	U075GP6	100	240	2			5				50A/2P, 30A/1P, 20A/1P	NEMA 3R	1,3
"EP123"	MIDWEST	U075GP6	100	240	2			5				50A/2P, 30A/1P, 20A/1P	NEMA 3R	2,3
"EP124"	MIDWEST	U075GP6	100	240	2				2			50A/2P, 30A/1P, 20A/1P	NEMA 3R	2,3
"EP125N"	MIDWEST	U075GP6	100	240	2				3			50A/2P, 30A/1P, 20A/1P	NEMA 3R	2,3
"EP125W"	MIDWEST	U075GP6	100	240	2				3			50A/2P, 30A/1P, 20A/1P	NEMA 3R	2,3
"EP125E"	MIDWEST	U075GP6	100	240	2				3			50A/2P, 30A/1P, 20A/1P	NEMA 3R	2,3
"EP126"	MIDWEST	U075GP6	100	240	2				4			50A/2P, 30A/1P, 20A/1P	NEMA 3R	2,3
"EP127"	MIDWEST	U075GP6	100	240	2				4			50A/2P, 30A/1P, 20A/1P	NEMA 3R	2,3
"EP128"	MIDWEST	U075GP6	100	240	2				5			50A/2P, 30A/1P, 20A/1P	NEMA 3R	2,3
"EP129"	MIDWEST	U075GP6	100	240	2				5			50A/2P, 30A/1P, 20A/1P	NEMA 3R	2,3
"EP130"	MIDWEST	U075GP6	100	240	2				5			50A/2P, 30A/1P, 20A/1P	NEMA 3R	2,3
"EP131NW"	MIDWEST	U075GP6	100	240	2					2		50A/2P, 30A/1P, 20A/1P	NEMA 3R	2,3
"EP131SW"	MIDWEST	U075GP6	100	240	2					2		50A/2P, 30A/1P, 20A/1P	NEMA 3R	2,3
"EP131SE"	MIDWEST	U075GP6	100	240	2					2		50A/2P, 30A/1P, 20A/1P	NEMA 3R	2,3
"EP131NE"	MIDWEST	U075GP6	100	240	2					2		50A/2P, 30A/1P, 20A/1P	NEMA 3R	2,3
"EP132S"	MIDWEST	U075GP6	100	240	2					3		50A/2P, 30A/1P, 20A/1P	NEMA 3R	2,3
"EP132N"	MIDWEST	U075GP6	100	240	2					4		50A/2P, 30A/1P, 20A/1P	NEMA 3R	2,3
"EP133"	MIDWEST	U075GP6	100	240	2					3		50A/2P, 30A/1P, 20A/1P	NEMA 3R	1,3
"EP134"	MIDWEST	U075GP6	100	240	2					4		50A/2P, 30A/1P, 20A/1P	NEMA 3R	2,3
"EP135"	MIDWEST	U075GP6	100	240	2					4		50A/2P, 30A/1P, 20A/1P	NEMA 3R	2,3
"EP136"	MIDWEST	U075GP6	100	240	2						2	50A/2P, 30A/1P, 20A/1P	NEMA 3R	2,3
"EP137"	MIDWEST	U075GP6	100	240	2						2	50A/2P, 30A/1P, 20A/1P	NEMA 3R	2,3
"EP138N"	MIDWEST	U075GP6	100	240	2						3	50A/2P, 30A/1P, 20A/1P	NEMA 3R	2,3
"EP138S"	MIDWEST	U075GP6	100	240	2						3	50A/2P, 30A/1P, 20A/1P	NEMA 3R	2,3
"EP139"	MIDWEST	U075GP6	100	240	2						4	50A/2P, 30A/1P, 20A/1P	NEMA 3R	2,3
"EP140"	MIDWEST	U075GP6	100	240	2						4	50A/2P, 30A/1P, 20A/1P	NEMA 3R	2,3
"EP141"	MIDWEST	U075GP6	100	240	2						5	50A/2P, 30A/1P, 20A/1P	NEMA 3R	2,3
"EP142"	MIDWEST	U075GP6	100	240	2						5	50A/2P, 30A/1P, 20A/1P	NEMA 3R	2,3
"EP143"	MIDWEST	U075GP6	100	240	2						6	50A/2P, 30A/1P, 20A/1P	NEMA 3R	2,3
"EP144"	MIDWEST	U075GP6	100	240	2						6	50A/2P, 30A/1P, 20A/1P	NEMA 3R	2,3

NOTES: 1. LOCATE NEW BACK IN PEDESTALS 5'-7" FROM LEFT EDGE (DRIVER'S SIDE) OF STAND AND A MAXIMUM OF 15'-0" FROM BACK OF STAND TO COMPLY WITH 551.77(A) OF N.E.C.  
2. LOCATE NEW PULL THROUGH PEDESTALS 5'-7" FROM LEFT EDGE (DRIVER'S SIDE) OF STAND AND A MAXIMUM OF 16'-0" FROM BACK OF STAND TO THE CENTER POINT BETWEEN THE TWO READS THAT GIVE ACCESS TO AND FROM THE SITE TO COMPLY WITH 551.77(A) OF N.E.C.  
3. PROVIDE FEED THRU LUGS.

CIRCUIT BREAKER DISTRIBUTION PANEL SCHEDULE

MARK:	"P9"		NEMA 3R		MAIN BUSS: 600 AMP	
VOLTAGE:	120/240	PHASE: 1	WIRE: 3	GROUND BUS: 300 AMP		
HOWARD LOOP				CIRCUIT BREAKER		
UNIT NO.	EQUIPMENT SERVED			AMP	POLE	
1	MCB			600	2	
2	RV SITE 124			50	2	
3	RV SITE 125 NORTH,125 WEST,125 EAST			150	2	
4	RV SITE 126,127			100	2	
5	RV SITE 128,129,130			150	2	
6	SPACE					
7						
8						
9						
10						
11						
12						
ACCESSORIES:						
35K AIC RATING (MINIMUM)						

CIRCUIT BREAKER DISTRIBUTION PANEL SCHEDULE

MARK:	"P10"		NEMA 3R	MAIN BUSS:	600	AMP
VOLTAGE:	120/240	PHASE:	1	WIRE:	3	GROUND BUS: 300 AMP
HOWARD LOOP				CIRCUIT BREAKER		
UNIT NO.	EQUIPMENT SERVED			AMP	POLE	
1	MCB			600	2	
2	RV SITE 131 NW,131 SW, 131 SE, 131 NE			200	2	
3	RV SITE 132 SOUTH,133			100	2	
4	RV SITE 132 NORTH,134,135			150	2	
5	SPACE					
6						
7						
8						
9						
10						
11						
12						
ACCESSORIES: 35K AIC RATING (MINIMUM)						

CIRCUIT BREAKER DISTRIBUTION PANEL SCHEDULE

MARK:	"P11"		NEMA 3R	MAIN BUSS:	600	AMP
VOLTAGE:	120/240	PHASE:	1	WIRE:	3	GROUND BUS: 300 AMP
HOWARD LOOP				CIRCUIT BREAKER		
UNIT NO.	EQUIPMENT SERVED			AMP	POLE	
1	MCB			600	2	
2	RV SITE 136,137			100	2	
3	RV SITE 138 NORTH,138 SOUTH			100	2	
4	RV SITE 139,140			100	2	
5	RV SITE 141,142			100	2	
6	RV SITE 143,144			100	2	
7	SPACE					
8						
9						
10						
11						
12						
ACCESSORIES:						
35K AIC RATING (MINIMUM)						

CIRCUIT BREAKER DISTRIBUTION PANEL SCHEDULE

MARK: "P6"		NEMA 3R		MAIN BUSS: 600 AMP	
VOLTAGE: 120/240		PHASE: 1	WIRE: 3	GROUND BUS: 300 AMP	
HOWARD LOOP				CIRCUIT BREAKER	
UNIT NO.	EQUIPMENT SERVED			AMP	POLE
1	MCB			600	2
2	RV SITE 100,101			100	2
3	RV SITE 102,103			100	2
4	RV SITE 104,105			100	2
5	RV SITE 106,107,108			150	2
6	LIGHT POLE SOUTH OF SITE 100			20	1
7	SPACE				
8					
9					
10					
11					
12					
ACCESSORIES:					
35K AIC RATING (MINIMUM)					

CIRCUIT BREAKER DISTRIBUTION PANEL SCHEDULE

MARK:	"P7"		NEMA 3R	MAIN BUSS:	600	AMP
VOLTAGE:	120/240	PHASE:	1	WIRE:	3	GROUND BUS: 300 AMP
HOWARD LOOP				CIRCUIT BREAKER		
UNIT NO.	EQUIPMENT SERVED			AMP	POLE	
1	MCB			600	2	
2	RV SITE 109,110			100	2	
3	RV SITE 111,112			100	2	
4	RV SITE 113 NORTH,113 SOUTH			100	2	
5	RV SITE 114,115 NORTH,115 SOUTH			150	2	
6	SPACE					
7						
8						
9						
10						
11						
12						
ACCESSORIES:						
35K AIC RATING (MINIMUM)						

Last edit on: 4/21/2023 12:10 PM by: SDW01521 Drawing Name: F:\Proj\21000\21219\21219.000\AutoCad\Plan Set\Graham's Island\21219.000E - Electrical Schedules - GISP.dwg Layout Name: Electrical Schedules - GISP.dwg Plotted By: SDW01521 Plotted on: 4/24/2023 2:21:58 PM

RV PEDESTAL SCHEDULE - ZIEBACH LOOP

MARK	MFGR	MODEL	AMPERAGE	VOLTAGE	POLES	"P1" CIRCUIT #	"P2" CIRCUIT #	"P3" CIRCUIT #	"P4" CIRCUIT #	"P5" CIRCUIT #	RECEPTACLES	ENCLOSURE TYPE	NOTES
"EP1"	MIDWEST	U075GP6	100	240	2	2					50A/2P, 30A/1P, 20A/1P	NEMA 3R	1,3
"EP2W"	MIDWEST	U075GP6	100	240	2	3					50A/2P, 30A/1P, 20A/1P	NEMA 3R	2,3
"EP2E"	MIDWEST	U075GP6	100	240	2	3					50A/2P, 30A/1P, 20A/1P	NEMA 3R	2,3
"EP3"	MIDWEST	U075GP6	100	240	2	4					50A/2P, 30A/1P, 20A/1P	NEMA 3R	2,3
"EP4"	MIDWEST	U075GP6	100	240	2	4					50A/2P, 30A/1P, 20A/1P	NEMA 3R	2,3
"EP5"	MIDWEST	U075GP6	100	240	2					5	50A/2P, 30A/1P, 20A/1P	NEMA 3R	2,3
"EP6W"	MIDWEST	U075GP6	100	240	2					4	50A/2P, 30A/1P, 20A/1P	NEMA 3R	2,3
"EP6E"	MIDWEST	U075GP6	100	240	2					4	50A/2P, 30A/1P, 20A/1P	NEMA 3R	2,3
"EP7A"	MIDWEST	U075GP6	100	240	2					5	50A/2P, 30A/1P, 20A/1P	NEMA 3R	2,3
"EP8"	MIDWEST	U075GP6	100	240	2					3	50A/2P, 30A/1P, 20A/1P	NEMA 3R	2,3
"EP9"	MIDWEST	U075GP6	100	240	2					3	50A/2P, 30A/1P, 20A/1P	NEMA 3R	2,3
"EP10"	MIDWEST	U075GP6	100	240	2					2	50A/2P, 30A/1P, 20A/1P	NEMA 3R	2,3
"EP11"	MIDWEST	U075GP6	100	240	2					2	50A/2P, 30A/1P, 20A/1P	NEMA 3R	2,3
"EP12"	MIDWEST	U075GP6	100	240	2		5				50A/2P, 30A/1P, 20A/1P	NEMA 3R	1,3
"EP13"	MIDWEST	U075GP6	100	240	2		5				50A/2P, 30A/1P, 20A/1P	NEMA 3R	2,3
"EP14"	MIDWEST	U075GP6	100	240	2		4				50A/2P, 30A/1P, 20A/1P	NEMA 3R	2,3
"EP15N"	MIDWEST	U075GP6	100	240	2		4				50A/2P, 30A/1P, 20A/1P	NEMA 3R	2,3
"EP15S"	MIDWEST	U075GP6	100	240	2		4				50A/2P, 30A/1P, 20A/1P	NEMA 3R	2,3
"EP16"	MIDWEST	U075GP6	100	240	2			2			50A/2P, 30A/1P, 20A/1P	NEMA 3R	2,3
"EP17"	MIDWEST	U075GP6	100	240	2			2			50A/2P, 30A/1P, 20A/1P	NEMA 3R	1,3
"EP18"	MIDWEST	U075GP6	100	240	2				6		50A/2P, 30A/1P, 20A/1P	NEMA 3R	2,3
"EP19"	MIDWEST	U075GP6	100	240	2				6		50A/2P, 30A/1P, 20A/1P	NEMA 3R	2,3
"EP20"	MIDWEST	U075GP6	100	240	2				2		50A/2P, 30A/1P, 20A/1P	NEMA 3R	2,3
"EP21"	MIDWEST	U075GP6	100	240	2				2		50A/2P, 30A/1P, 20A/1P	NEMA 3R	1,3
"EP22W"	MIDWEST	U075GP6	100	240	2				4		50A/2P, 30A/1P, 20A/1P	NEMA 3R	1,3
"EP22E"	MIDWEST	U075GP6	100	240	2				4		50A/2P, 30A/1P, 20A/1P	NEMA 3R	1,3
"EP23W"	MIDWEST	U075GP6	100	240	2				3		50A/2P, 30A/1P, 20A/1P	NEMA 3R	2,3
"EP23E"	MIDWEST	U075GP6	100	240	2				3		50A/2P, 30A/1P, 20A/1P	NEMA 3R	2,3
"EP24N"	MIDWEST	U075GP6	100	240	2				5		50A/2P, 30A/1P, 20A/1P	NEMA 3R	1,3
"EP24S"	MIDWEST	U075GP6	100	240	2				5		50A/2P, 30A/1P, 20A/1P	NEMA 3R	1,3
"EP25"	MIDWEST	U075GP6	100	240	2			4			50A/2P, 30A/1P, 20A/1P	NEMA 3R	2,3
"EP26W"	MIDWEST	U075GP6	100	240	2			5			50A/2P, 30A/1P, 20A/1P	NEMA 3R	1,3
"EP26E"	MIDWEST	U075GP6	100	240	2			5			50A/2P, 30A/1P, 20A/1P	NEMA 3R	1,3
"EP27"	MIDWEST	U075GP6	100	240	2			4			50A/2P, 30A/1P, 20A/1P	NEMA 3R	2,3
"EP28"	MIDWEST	U075GP6	100	240	2			4			50A/2P, 30A/1P, 20A/1P	NEMA 3R	2,3
"EP29"	MIDWEST	U075GP6	100	240	2			3			50A/2P, 30A/1P, 20A/1P	NEMA 3R	2,3
"EP30"	MIDWEST	U075GP6	100	240	2			3			50A/2P, 30A/1P, 20A/1P	NEMA 3R	2,3
"EP31W"	MIDWEST	U075GP6	100	240	2			3			50A/2P, 30A/1P, 20A/1P	NEMA 3R	1,3
"EP31E"	MIDWEST	U075GP6	100	240	2			3			50A/2P, 30A/1P, 20A/1P	NEMA 3R	1,3
"EP32"	MIDWEST	U075GP6	100	240	2		3				50A/2P, 30A/1P, 20A/1P	NEMA 3R	2,3
"EP33"	MIDWEST	U075GP6	100	240	2		2				50A/2P, 30A/1P, 20A/1P	NEMA 3R	2,3
"EP34"	MIDWEST	U075GP6	100	240	2		3				50A/2P, 30A/1P, 20A/1P	NEMA 3R	2,3
"EP35"	MIDWEST	U075GP6	100	240	2	2					50A/2P, 30A/1P, 20A/1P	NEMA 3R	2,3
"EP36"	MIDWEST	U075GP6	100	240	2		2				50A/2P, 30A/1P, 20A/1P	NEMA 3R	2,3
"EP37"	MIDWEST	U075GP6	100	240	2		2				50A/2P, 30A/1P, 20A/1P	NEMA 3R	2,3
"EP38"	MIDWEST	U075GP6	100	240	2	5					50A/2P, 30A/1P, 20A/1P	NEMA 3R	2,3
"EP39A"	MIDWEST	U075GP6	100	240	2	5					50A/2P, 30A/1P, 20A/1P	NEMA 3R	2,3
"EP40"	MIDWEST	U075GP6	100	240	2	6					50A/2P, 30A/1P, 20A/1P	NEMA 3R	2,3
"EP41"	MIDWEST	U075GP6	100	240	2	6					50A/2P, 30A/1P, 20A/1P	NEMA 3R	2,3

NOTES: 1. LOCATE NEW BACK IN PEDESTALS 5'-7" FROM LEFT EDGE (DRIVER'S SIDE) OF STAND AND A MAXIMUM OF 15'-0" FROM BACK OF STAND TO COMPLY WITH 551.77(A) OF N.E.C.  
2. LOCATE NEW PULL THROUGH PEDESTALS 5'-7" FROM LEFT EDGE (DRIVER'S SIDE) OF STAND AND A MAXIMUM OF 16'-0" FROM BACK OF STAND TO THE CENTER POINT BETWEEN THE TWO READS THAT GIVE ACCESS TO AND FROM THE SITE TO COMPLY WITH 551.77(A) OF N.E.C.  
3. PROVIDE FEED THRU LUGS.

CIRCUIT BREAKER DISTRIBUTION PANEL SCHEDULE

MARK:	"P4"	NEMA 3R	MAIN BUSS:	600	AMP
VOLTAGE:	120/240	PHASE:	1	WIRE:	3
GROUND BUS:			300	AMP	
ZIEBACH LOOP			CIRCUIT BREAKER		
UNIT NO.	EQUIPMENT SERVED		AMP	POLE	
1	MCB		600	2	
2	RV SITE 20,21		100	2	
3	RV SITE 23 EAST,23 WEST		100	2	
4	RV SITE 22 EAST,22 WEST		100	2	
5	RV SITE 24 NORTH,24 SOUTH		100	2	
6	RV SITE 18,19		100	1	
7	SPACE				
8					
9					
10					
11					
12					
ACCESSORIES: 35K AIC RATING (MINIMUM)					

CIRCUIT BREAKER DISTRIBUTION PANEL SCHEDULE

MARK:	"P5"	NEMA 3R	MAIN BUSS:	600	AMP
VOLTAGE:	120/240	PHASE:	1	WIRE:	3
GROUND BUS:			300	AMP	
ZIEBACH LOOP			CIRCUIT BREAKER		
UNIT NO.	EQUIPMENT SERVED		AMP	POLE	
1	MCB		600	2	
2	RV SITE 10,11		100	2	
3	RV SITE 8,9		100	2	
4	RV SITE 6 EAST,6 WEST		100	2	
5	RV SITE 5,7A		100	2	
6	LIGHT POLES IN COMFORT STATION PARKING		20	1	
7	COMFORT STATION EX "P12"		150	2	
8	LIFT STATION EX "P13"		60	2	
9					
10					
11					
12					
ACCESSORIES: 35K AIC RATING (MINIMUM)					

CIRCUIT BREAKER DISTRIBUTION PANEL SCHEDULE

MARK:	"P1"	NEMA 3R	MAIN BUSS:	600	AMP
VOLTAGE:	120/240	PHASE:	1	WIRE:	3
GROUND BUS:			300	AMP	
ZIEBACH LOOP			CIRCUIT BREAKER		
UNIT NO.	EQUIPMENT SERVED		AMP	POLE	
1	MCB		600	2	
2	RV SITE 35,1		100	2	
3	RV SITE 2 WEST,2 EAST		100	2	
4	RV SITE 3,4		100	2	
5	RV SITE 38,39A		100	2	
6	RV SITE 40,41		100	2	
7	SPACE				
8					
9					
10					
11					
12					
ACCESSORIES: 35K AIC RATING (MINIMUM)					

CIRCUIT BREAKER DISTRIBUTION PANEL SCHEDULE

MARK:	"P2"	NEMA 3R	MAIN BUSS:	600	AMP
VOLTAGE:	120/240	PHASE:	1	WIRE:	3
GROUND BUS:			300	AMP	
ZIEBACH LOOP			CIRCUIT BREAKER		
UNIT NO.	EQUIPMENT SERVED		AMP	POLE	
1	MCB		600	2	
2	RV SITE 33,36,37		150	2	
3	RV SITE 32,34		100	2	
4	RV SITE 14,15 NORTH,15 SOUTH		150	2	
5	RV SITE 12,13		100	2	
6	LIGHT POLE SOUTH OF SITE 37		20	1	
7	SPACE				
8					
9					
10					
11					
12					
ACCESSORIES: 35K AIC RATING (MINIMUM)					

CIRCUIT BREAKER DISTRIBUTION PANEL SCHEDULE


MARK:	"P3"	NEMA 3R	MAIN BUSS:	600	AMP
VOLTAGE:	120/240	PHASE:	1	WIRE:	3
GROUND BUS:			300	AMP	
ZIEBACH LOOP			CIRCUIT BREAKER		
UNIT NO.	EQUIPMENT SERVED		AMP	POLE	
1	MCB		600	2	
2	RV SITE 16,17		100	2	
3	RV SITE 29,30,31		150	2	
4	RV SITE 25,27,28		150	2	
5	RV SITE 26 WEST,26 EAST		100	2	
6	SPACE				
7					
8					
9					
10					
11					
12					
ACCESSORIES: 35K AIC RATING (MINIMUM)					

ELECTRICAL SCHEDULES  
GRAHAMS ISLAND STATE PARK


**Bartlett & West**




DESIGNED BY:	ARH
DRAWN BY:	ARH
APPROVED BY:	MSV
DESIGN PROJ:	21219.000
CONST PROJ:	
SCALE:	AS NOTED
DATE:	04-24-2023
DRAWING NO:	<b>GI-E-602</b>
SHEET NO:	

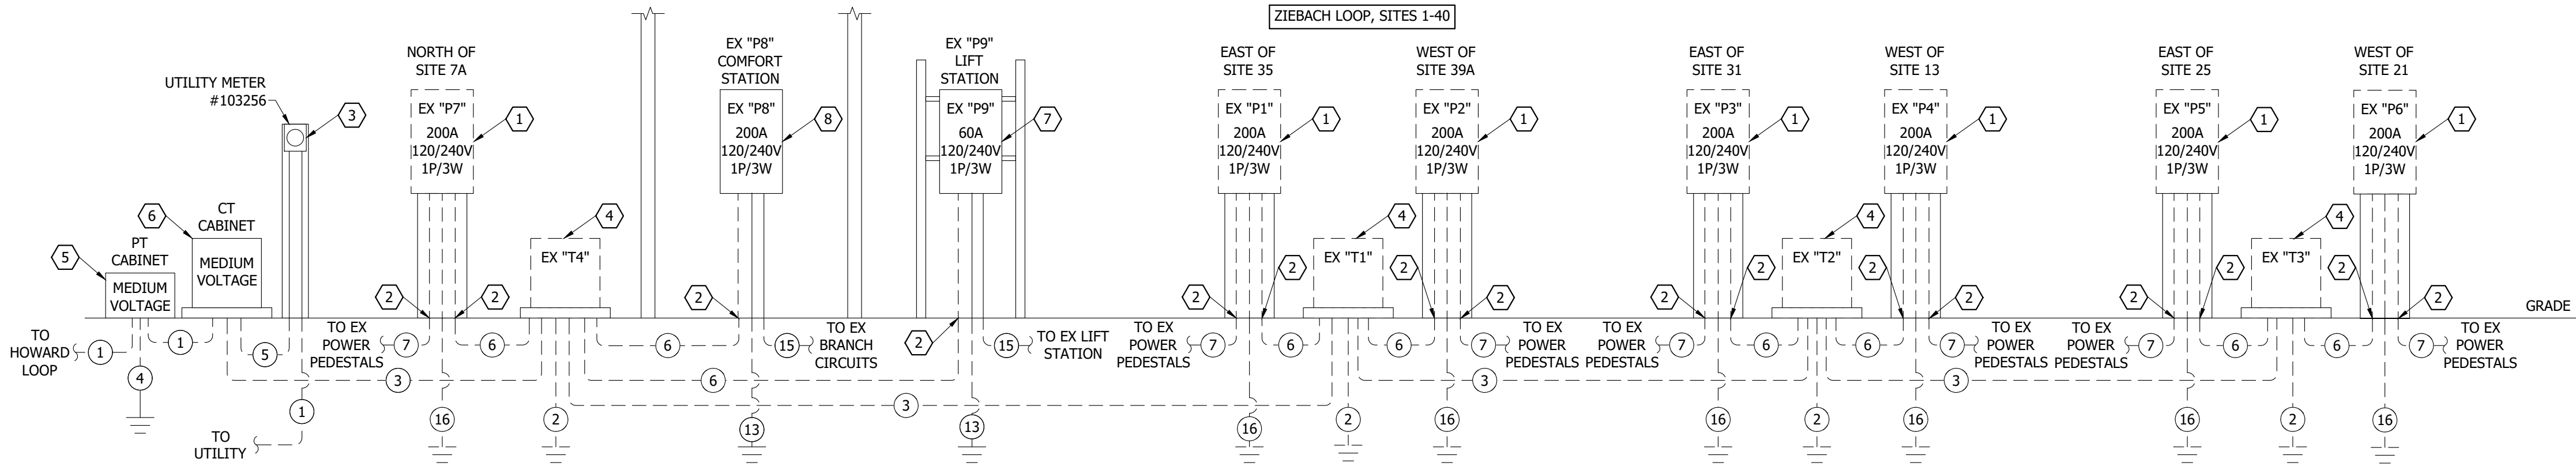


1 ZIEBACH LOOP ELECTRICAL DEMOLITION RISER DIAGRAM  
NOT TO SCALE

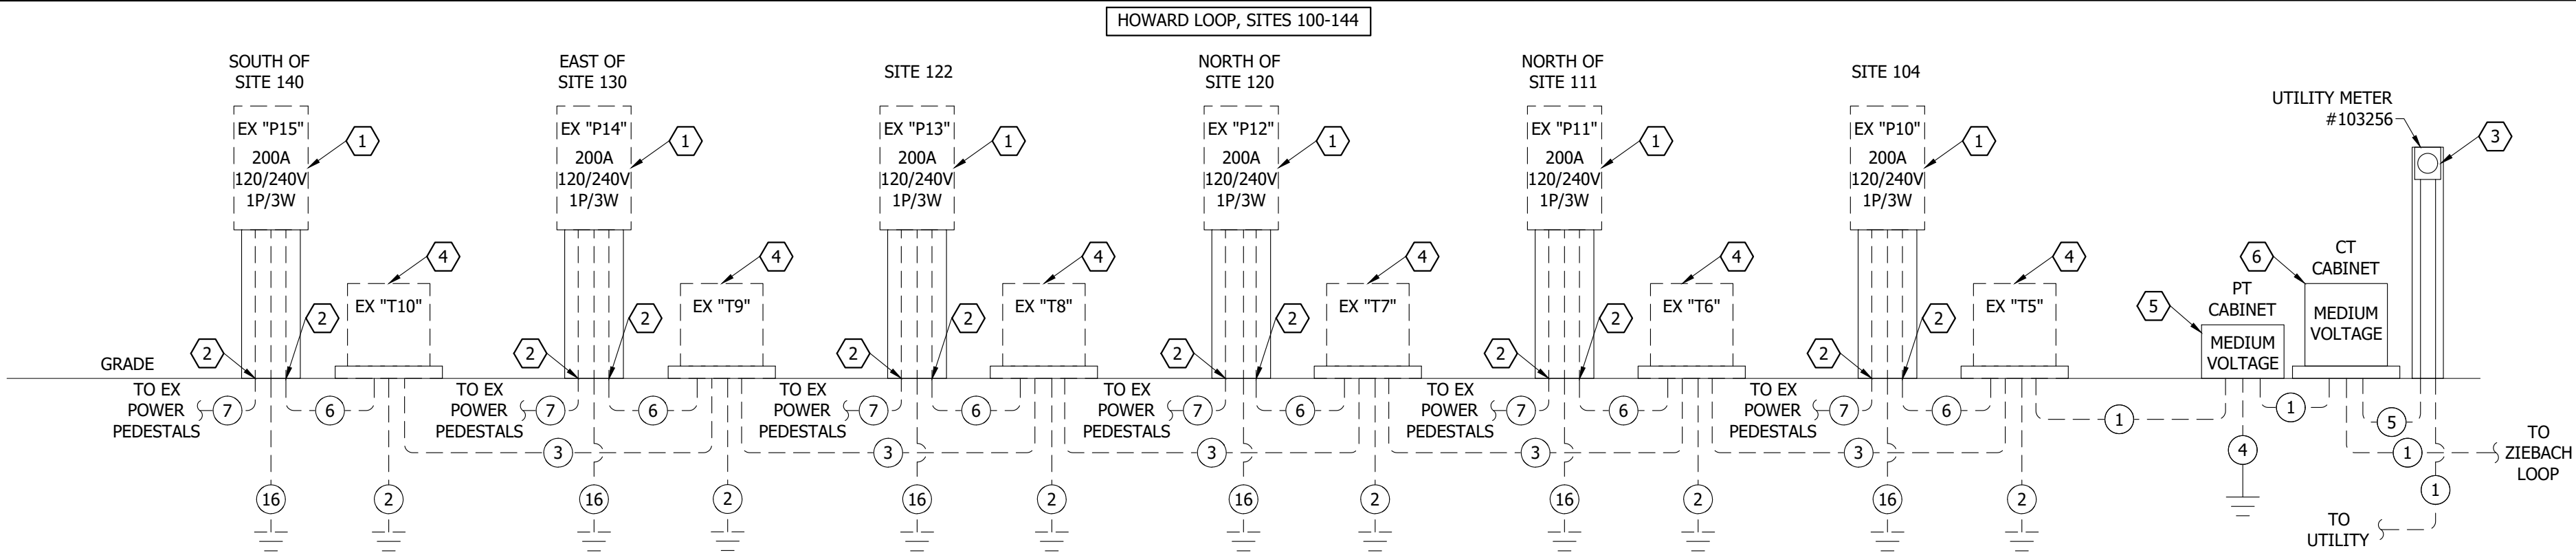

2 HOWARD LOOP ELECTRICAL DEMOLITION RISER DIAGRAM  
NOT TO SCALE

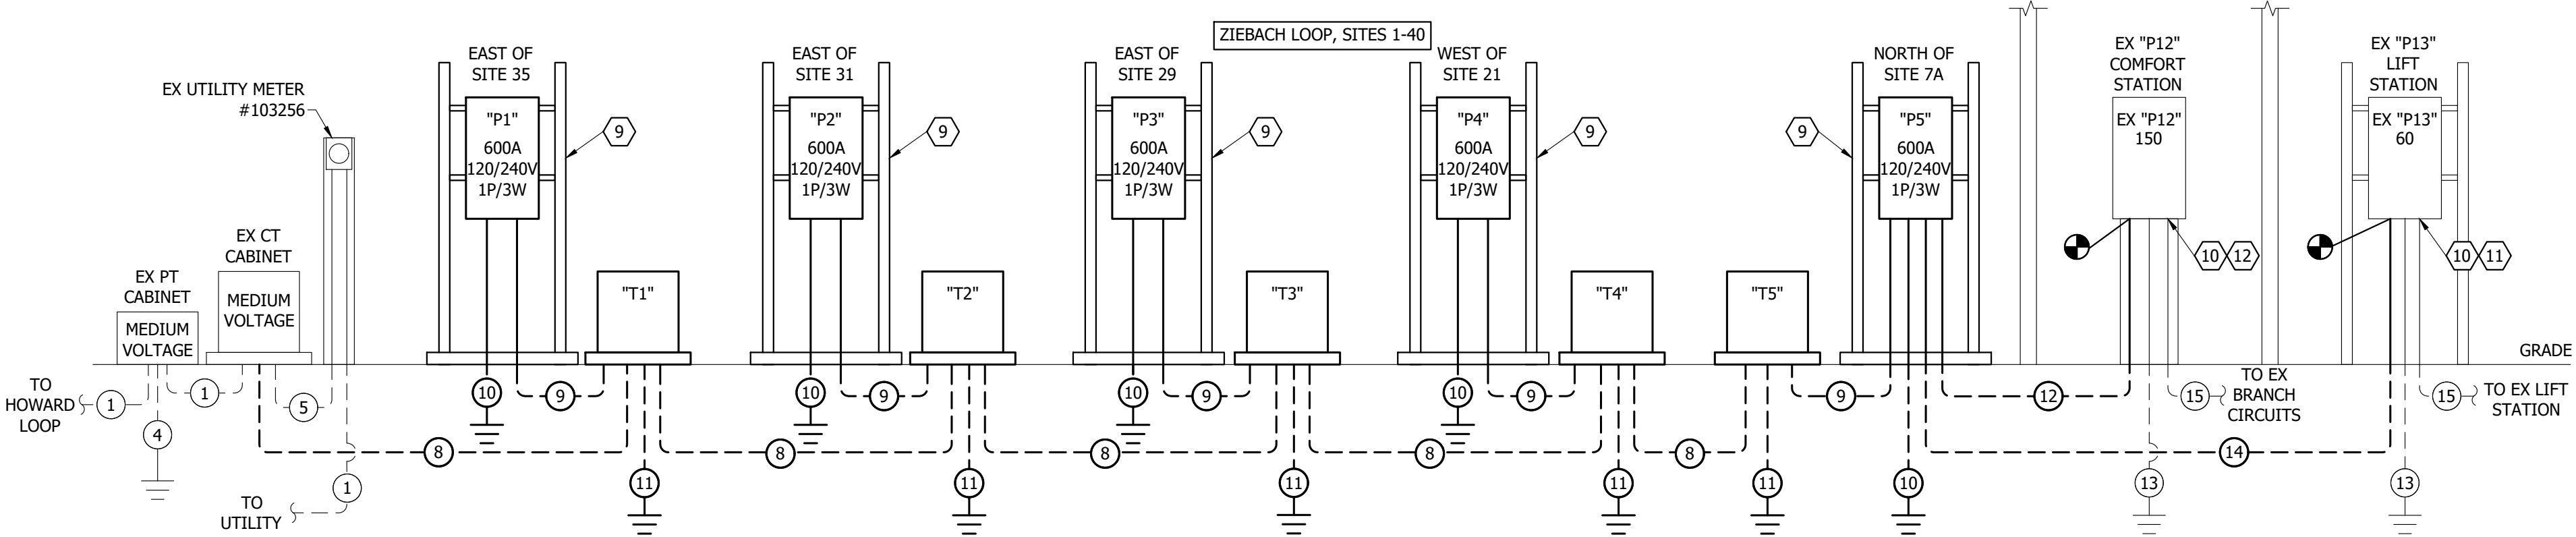

3 ZIEBACH LOOP ELECTRICAL IMPROVEMENT RISER DIAGRAM  
NOT TO SCALE

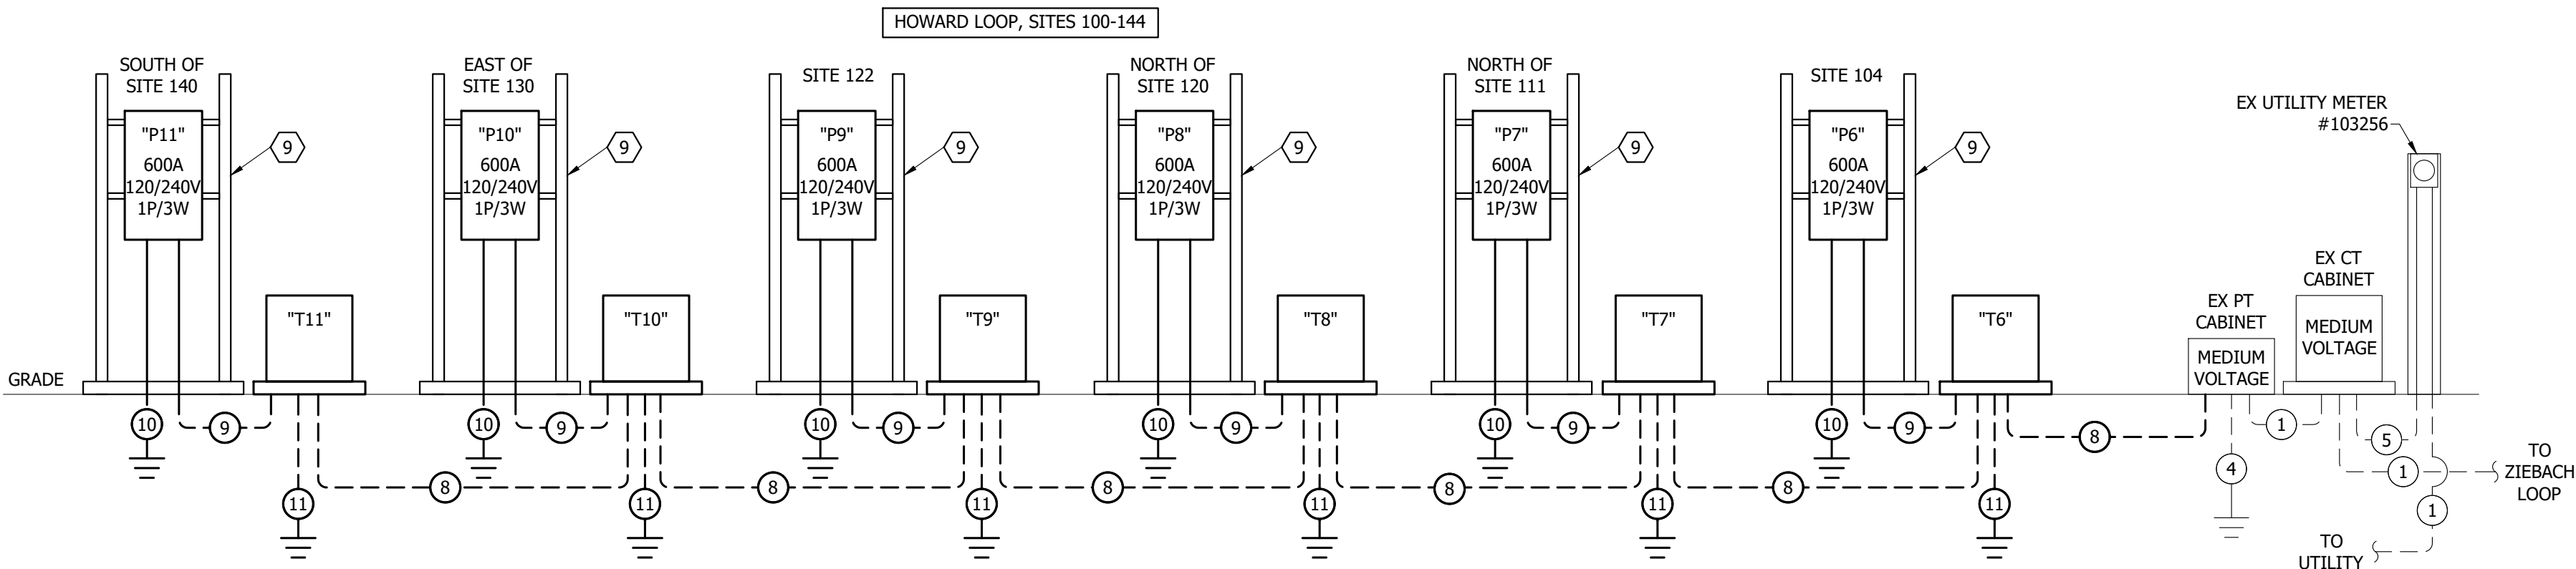

4 HOWARD LOOP ELECTRICAL IMPROVEMENT RISER DIAGRAM  
NOT TO SCALE

REFERENCE NOTES:

- EX PANELBOARD, POWER CONNECTION, WIRE GUTTER, AND ALL ASSOCIATED ABOVE GRADE WIRE AND CONDUIT TO BE REMOVED.
- EX BELOW GRADE DIRECT BURY WIRE TO BE CUT BACK AND REMOVED TO 1'-0" BELOW GRADE. EX BELOW GRADE DIRECT BURY WIRE BELOW 1'-0" TO BE DISCONNECTED AND ABANDONED IN PLACE.
- EX 120/240 VOLT UTILITY METER, METER POLE, AND ASSOCIATED WIRE TO REMAIN. METER NUMBER 103256.
- EX UTILITY TRANSFORMER, EQUIPMENT BASE, AND ASSOCIATED WIRE AND CONDUIT TO BE REMOVED.
- EX PT CABINET, POWER CONNECTIONS, UNI-STRUT, AND EQUIPMENT PAD TO REMAIN. ALL EX WIRE AND CONDUIT TO BE TO REMAIN UNLESS NOTED OTHERWISE.
- EX CT CABINET, POWER CONNECTIONS, UNI-STRUT, AND EQUIPMENT PAD TO REMAIN. ALL EX WIRE AND CONDUIT TO BE TO REMAIN UNLESS NOTED OTHERWISE.
- EX PANELBOARD, POWER CONNECTIONS, ASSOCIATED CONDUIT, BRANCH CIRCUITS, AND UNI-STRUT TO REMAIN. ALL EX WIRE AND CONDUIT TO BE TO REMAIN UNLESS NOTED OTHERWISE.
- EX PANELBOARD, POWER CONNECTIONS, ASSOCIATED CONDUIT AND BRANCH CIRCUITS TO REMAIN. ALL EX WIRE AND CONDUIT TO BE TO REMAIN UNLESS NOTED OTHERWISE.
- E/C TO PROVIDE NEW UNI-STRUT MOUNTING STRUCTURE. REFER TO UNI-STRUT MOUNTING DETAIL 4/GI-E-504.
- EX BRANCH FEEDER WIRE AND CONDUIT TO REMAIN. FIELD VERIFY EXACT LOCATION AND REQUIREMENTS.
- E/C TO PROVIDE NEW LABEL "P13" FOR EXISTING PANELBOARD. REFER TO ELECTRICAL IMPROVEMENT SITE PLAN GI-E-116.
- E/C TO PROVIDE NEW LABEL "P12" FOR EXISTING PANELBOARD. REFER TO ELECTRICAL IMPROVEMENT SITE PLAN GI-E-116.

GENERAL NOTES:

- THE EX CONDITIONS HAVE BEEN SHOWN BASED ON CASUAL ON-SITE INVESTIGATION WITH NO GUARANTEE TO THEIR ACCURACY, CONTRACTOR TO BE RESPONSIBLE TO FIELD VERIFY EX CONDITIONS.
- E/C TO FIELD COORDINATE ALL WORK WITH OTHER TRADES.
- E/C TO FIELD COORDINATE WITH NORTHERN PLAINS ELECTRIC CO-OP (NPEC) FOR ALL UTILITY COORDINATION.  
NPEC CONTACT: KEVIN LARSON  
PHONE: 701-303-0868  
EMAIL: scotti@mwec.com
- E/C TO BE RESPONSIBLE FOR A NEW UTILITY ELECTRICAL CONNECTION COSTS.
- UTILITY TO FIELD VERIFY EX MEDIUM VOLTAGE FEEDERS WILL BE SUFFICIENT FOR NEW LAYOUT. PROVIDE NEW MEDIUM VOLTAGE FEEDERS IF SIZE IS INSUFFICIENT. FIELD COORDINATE WITH E/C.


FEEDER SCHEDULE:

- EX UTILITY PRIMARY MEDIUM VOLTAGE FEEDER WIRE AND CONDUIT TO REMAIN.
- EX UTILITY GROUND WIRE AND CONDUIT TO BE REMOVED.
- EX MEDIUM VOLTAGE MAIN SERVICE FEEDER WIRE AND CONDUIT TO BE REMOVED.
- EX MEDIUM VOLTAGE MAIN SERVICE GROUND WIRE AND CONDUIT TO REMAIN.
- EX MEDIUM VOLTAGE UTILITY METER WIRE AND CONDUIT TO REMAIN.
- EX UNDERGROUND DIRECT BURY MAIN FEEDER TO REMAIN AND BE ABANDONED IN PLACE.
- EX UNDERGROUND DIRECT BURY BRANCH FEEDER TO REMAIN AND BE ABANDONED IN PLACE.
- UTILITY TO PROVIDE PRIMARY MEDIUM VOLTAGE FEEDERS, ASSOCIATED CONDUIT AND TRENCHING. E/C TO COORDINATE WITH UTILITY.
- 3-350 IN EACH OF 2-3". (BASED ON COPPER)
- 1-2/0G IN 1". (BASED ON COPPER)
- UTILITY GROUND WIRE AND CONDUIT, COORDINATE WITH UTILITY.
- 3-1/0 IN OF 2". (BASED ON COPPER)
- EX SERVICE GROUND WIRE AND CONDUIT TO REMAIN.
- 3-4 & 1-10G IN 1".
- EX BRANCH FEEDERS TO REMAIN.
- EX SERVICE GROUND WIRE AND CONDUIT TO BE REMOVED.

**Bartlett & West**

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WWW.BARTLETTWEST.COM

**ELECTRICAL RISER DIAGRAMS**  
**GRAHAMS ISLAND STATE PARK**  
**NORTH DAKOTA PARKS & RECREATION DEPARTMENT**  
**ELECTRICAL UPGRADES**  
**BISMARCK, NORTH DAKOTA**

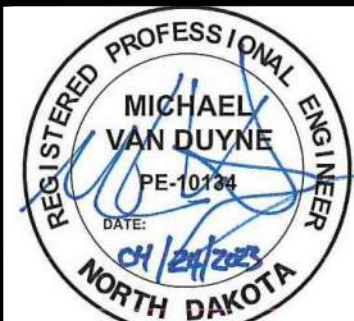

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